



GLAMORGAN/SPRING BAY COUNCIL
NOTICE OF PROPOSED DEVELOPMENT

Notice is hereby given that an application has been made for planning approval for the following development:

SITE: **44 Alma Road, Orford**
CT 186679/1

PROPOSAL: **Single Dwelling Including Secondary**
Residence

Any person may make representation on the application(s) by letter (PO Box 6, Triabunna) or electronic mail (planning@freycinet.tas.gov.au) addressed to the Chief Executive Officer. Representations must be received before midnight on 25 February 2026.

APPLICANT: **Suresh Shanmugam - Homes 4 You**
DATE: **15/01/2026**
APPLICATION NO: **DA 2026 / 00004**

Application for Planning Approval

Advice:

Use this form for all no permit required, permitted and discretionary planning applications including visitor accommodation, subdivision as well as for planning scheme amendment & minor amendments to permits.

Completing this form in full will help ensure that all necessary information is provided and avoid any delay. The planning scheme in clause 6.0 provides details of other information that may be required. A checklist of application documents is provided on page 4 of this form.

Often, it is beneficial to provide a separate written submission explaining in general terms what is proposed and why and to justify the proposal against any applicable performance criteria.

If you have any queries with the form or what information is required, please contact the office.

Details of Applicant and Owner			
Applicant:			
Contact person: (if different from applicant)			
Address:			
Suburb:		Post Code:	
Email:		Phone: / Mobile:	

Note: All correspondence with the applicant will be via email unless otherwise advised

Owner (if different from applicant)			
Address:			
Suburb:		Post Code:	
Email:		Phone: / Mobile:	

Details of Site <i>(Note: If your application is discretionary, the following will be placed on public exhibition)</i>			
Address of proposal:			
Suburb:		Post Code:	
Size of site: (m ² or Ha)			
Certificate of Title(s):			
Current use of site:			

General Application Details *Complete for All Applications*

Description of proposed use or development:			
Estimated value of works: (design & construction) The estimated cost is to include the cost of labour and materials using current industry pricing and is to include GST. You may be required to verify this estimate.			
Is the property on the State Heritage Register? (Circle one)	Yes / No		

For all Non-Residential Applications

Hours of Operation	
Number of Employees	
Describe any delivery of goods to and from the site, including the types of vehicles used and the estimated average weekly frequency	
Describe any hazardous materials to be used or stored on site	
Type & location of any large plant or machinery used (refrigeration, generators)	
Describe any retail and/or storage of goods or equipment in outdoor areas	

Personal Information Protection Statement

The personal information requested will be managed in accordance with the *Personal Information Protection Act 2004*. The personal information is being collected by Glamorgan Spring Bay Council for the purposes of managing, assessing, advising on, and determining the relevant application in accordance with the *Land Use Planning and Approvals Act 1993*(LUPPA) and other related purposes, including for the purpose of data collection.

The information may be shared with contractors and agents of the Council for this purpose, law enforcement agencies, courts and other organisations and it may also be made publicly available on the Council's website and available for any person to inspect in accordance with LUPAA. If you do not provide the information sought, Council will be unable to accept and/or process your application.

Applicant Declaration

I/we hereby apply for planning approval to carry out the use or development described in this application and the accompanying documents and declare that:


- The information in this application is true and correct.
- I/we authorise Council employees or consultants to enter the site to assess the application.
- I/we have obtained all copy licenses and permission from the copyright owner for the publication, communication and reproduction of the application and reports, plans and materials provided as part of the application and for the purposes of managing, assessing, advising on, and determining the application.

I/we authorise the Council to:

- Make available the application and all information, reports, plans, and materials provided with or as part of the application in electronic form on the Council's website and in hard copy at the Council's office and other locations for public exhibition if and as required;
- Make such copies of the application and all information, reports, plans and materials provided with or as part of the application which are, in the Council's opinion, necessary to facilitate a consideration of the application;
- Publish and or reproduce the application and all information, reports, plans and materials provided with or as part of the application in Council agendas, for representors, referral agencies and other persons interested in the application; and
- provide a copy of any documents relating to this application to any person for the purpose of assessment or public consultation and agree to arrange for the permission of the copyright owner of any part of this application to be obtained.

You indemnify the Council for any claim or action taken against the Council for breach of copyright in respect of the application and all information, report, plan, and material provided with or as part of the application.

I/We declare that the Owner has been notified of the intention to make this application in accordance with section 52(1) of the *Land Use Planning and Approvals Act 1993*.

Applicant Signature:		Date:	
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Owners Consent required if application is on or affects Council or Crown owned or administered land

I declare that I have given permission for the making of this application for use and/or development.

Council General Manager or delegate Signature:		Date:	
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If land affected by this application is owned or administered by the Crown or Council, then the written permission of the relevant Minister (or their delegate) and/or the General Manager must be provided. For Crown land, a copy of the instrument of delegation must be provided.

It is the applicant's responsibility to obtain any owners consent prior to lodgement. Written requests for Council consent are via the General Manager. Request for Ministerial consent is to be directed to the relevant department.

Checklist of application documents:

Taken from Section 6 of the Planning Scheme

An application must include:

- ☐ a signed application form;
- ☐ any written permission and declaration of notification required under s.52 of the Act and, if any document is signed by the delegate, a copy of the delegation;
- ☐ details of the location of the proposed use or development;
- ☐ a copy of the current certificate of title for all land to which the permit sought is to relate, including the title plan; and
- ☐ a full description of the proposed use or development.

In addition to the information that is required by clause 6.1.2, a planning authority may, in order to enable it to consider an application, require such further or additional information as the planning authority considers necessary to satisfy it that the proposed use or development will comply with any relevant standards and purpose statements in the zone, codes or a specific area plan, applicable to the use or development including:

- ☐ any schedule of easements if listed in the folio of the title and appear on the plan, where applicable;
- ☐ a site analysis and site plan at a scale acceptable to the planning authority showing, where applicable:
 - (i) the existing and proposed use(s) on the site;
 - (ii) the boundaries and dimensions of the site;
 - (iii) topography including contours showing AHD levels and major site features;
 - (iv) natural drainage lines, watercourses and wetlands on or adjacent to the site;
 - (v) soil type;
 - (vi) vegetation types and distribution including any known threatened species, and trees and vegetation to be removed;
 - (vii) the location and capacity and connection point of any existing services and proposed services;
 - (viii) the location of easements on the site or connected to the site;
 - (ix) existing pedestrian and vehicle access to the site;
 - (x) the location of existing and proposed buildings on the site;
 - (xi) the location of existing adjoining properties, adjacent buildings and their uses;
 - (xii) any natural hazards that may affect use or development on the site;
 - (xiii) proposed roads, driveways, parking areas and footpaths within the site;
 - (xiv) any proposed open space, common space, or facilities on the site; and
 - (xv) proposed subdivision lot boundaries;
- ☐ where it is proposed to erect buildings, a detailed layout plan of the proposed buildings with dimensions at a scale of 1:100 or 1:200 as required by the planning authority showing, where applicable:
 - (xvi) the internal layout of each building on the site;
 - (xvii) the private open space for each dwelling;
 - (xviii) external storage spaces;
 - (xix) parking space location and layout;
 - (xx) major elevations of every building to be erected;
 - (xxi) the relationship of the elevations to existing ground level, showing any proposed cut or fill;
 - (xxii) shadow diagrams of the proposed buildings and adjacent structures demonstrating the extent of shading of adjacent private open spaces and external windows of buildings on adjacent sites; and
 - (xxiii) materials and colours to be used on roofs and external walls.



HOMES4YOU TAS Pty Ltd

YOUR HOME YOUR CHOICE



**Kit Homes
Tasmania**

132 Forster Street Invermay
Launceston. Tasmania 7248

M: 0438 002 261

Email: sales@homes4youtas.com.au

WEB: www.homes4youtas.com.au

Appointment of Agent

To whom it may concern

1/We

(owners name)

I/We further appoint the following person to act as my lawful agent to apply for any required certificates and permits and make the necessary submissions to the proper authorities as required under the Building Act 2016 for all matters relating to this development.

Hereby grant authorization for

Suresh Shanmugam
HOMES4YOU TAS PTY LTD
M: 0438 002 261

(applicant/agents name)

Address of property:

44 Alma Road

Orford TAS 7190

Signature of Owner/s:

Owners Names:

Telephone No:

Dated:

14 Jan 2026

SITE INVESTIGATION REPORT

**AS 2870 SITE CLASSIFICATION &
AS 4055 WIND LOADS FOR HOUSING**

CLIENT:

**PROJECT ADDRESS:
44 ALMA ROAD
ORFORD 7190**

**PROPOSED DEVELOPMENT:
RESIDENTIAL DWELLING X 2**

**FILE NUMBER:
H3065**

**DATE:
8 AUGUST 2025**

**HED CONSULTING
UNIT 2, 1 LIVERPOOL ST, HOBART 7000
P 03 6146 0334 E info@hed-consulting.com.au**

The logo for HED CONSULTING features the letters 'HED' in a stylized, bold font. The 'H' and 'D' are white, while the 'E' is red. A white diagonal line crosses through the 'E'. Below this, the word 'CONSULTING' is written in a white, sans-serif font. The entire logo is set against a dark grey rectangular background.

**HED
CONSULTING**

1. Executive Summary

The subject land is located at 44 Alma Road, Orford. The development proposal includes the construction of two residential dwellings. The site investigation has been conducted in accordance with AS2870:2011 *Residential slabs and footings* and AS4055-2021 *Wind Load for housing*. A summary of the report is detailed within the table below.

Analysis	Observations / Results
Site classification	P (due to presence of fill)
Surface movement (γ_s) range:	20-40mm
Geology:	Triassic dominantly quartz sandstone
Refusal depth:	1.1m (BH01) & 1.0m (BH02)
Estimated soil bearing capacity:	>100 kPa @ 0.3m depth
Modified Emerson Crumb test:	Slightly dispersive
Wind classification:	N2

2. Client Information and Site Location

	Information
Client name:	Claire Horner
Site address:	44 Alma Road Orford
Property ID:	9087544
Title Reference:	186679/1

3. Site information

Site information	Results
Size of development:	Single residential dwellings (2)
Services available:	Power, telecommunications, water, sewer & stormwater
Zoning:	Low Density Residential
Tenure:	Private Freehold
Permit Authority:	Glamorgan Spring Bay Council
Planning Overlays:	Bushfire-prone areas

4. Site visit

Site investigation	Observations / Results
Date of site investigation:	1/8/2025
Slope:	8-10%
Aspect:	East
Rainfall:	68.2mm (preceding two weeks) ¹
Drainage:	Imperfect to poor
Vegetation:	Sparse grass
Erosion:	No erosion was observed

¹ Bureau of Meteorology, <http://www.bom.gov.au>, Daily Rainfall Triabunna (Salmon Flats)

5. Soil Profile

Bore holes revealed a brown clayey sand fill overlying natural brown clay. Auger refused at 1.1m (BH01) and 1.0m (BH02) depth. No groundwater was intercepted in either bore hole. 9Kg Dynamic Cone Penetrometer test was also conducted to establish the estimated bearing capacity of the soil. The soil profile and location of the bore holes / DCP is shown in the appendix of this report.

6. Site Stability

The site exhibits no signs of significant erosion or land instability and is not within a landslide hazard overlay. Earthworks shall comply with AS3798-2007 Guidelines on earthworks for commercial and residential developments.

7. AS2870 Site Classification

The site is classified as: **P** (due to the presence of fill). The natural soil profile has 20-40mm y_s surface movement.

Footings to be bedded / piered to competent bedrock. Concrete shall be placed immediately following the excavation of foundations to prevent the accumulation of water within the footings.

8. AS4055 Wind Classification

The site is classified as per AS4055 – 2021 Wind loads for housing.

Site information	Results
Geographic region:	A
Terrain Category:	2
Topographic classification:	T0
Shielding:	NS
Wind Classification:	N2
Wind Speed ($V_{h,u}$):	40m/s

9. General notes and limitations

Site Investigation:

Site investigation conducted in accordance with the requirements of clause 2.4 of AS2870:2011. The aim of a site investigation is to obtain information about the soil at the location of the intended building(s). The location of bore holes are based on information supplied from the client and other any other location that is deemed necessary by HED Consulting to provide an accurate report. The investigation only applies to this part of the site and the results and recommendations of this report should not be used for any other part of the site.

HED Consulting aims to provide an accurate report at the time of the investigation however natural variations in soil characteristics and depth can occur over short distances. Soil conditions can also vary over time due to climatic events or earthworks. For example, the bearing capacity of clay soils can vary due to the seasonal climatic events. HED Consulting accepts no responsibility for soil conditions that are different to what was inspected at the time of the investigation. If the soil conditions encountered vary to the results of this report HED Consulting should be contacted for advice. As per clause 2.5.2 of AS2870:2011 the site may require to be re-classified if a cut exceeds 500mm or depth of fill would result in a P classification (when the earthworks were not known at the time of investigation).

Soil testing:

Soil samples (when collected) are tested in accordance with AS1289.7.1.1 – 2003 *Soil reactivity tests-determination of the shrinkage index of a soil-shrink swell index*. Soil testing is not required for all sites due to previous testing of similar material and/or using professional opinion. Bearing capacity of soil is based on field testing with accordance to clause 6.1.7 of AS1726:2017 and / or pocket penetrometer and / or DCP method. Bearing capacity of clays can vary seasonally. Clay can lose strength with high moisture content and increase in strength when clay dries. Bearing capacity results are estimated and are valid for the time of the investigation only. Emersion testing is conducted in accordance with Dispersive Soils and their Management, Technical Reference Manual, Marcus Hardie – 2009. This test reveals whether a clay is dispersive or not.

Building maintenance notes:

The building foundations shall be designed by an engineer. The builder must ensure that good site drainage is provided during the construction phase. Soil drains shall be constructed before excavation of the footings. Roof water should be diverted away from the footing as soon as the roof is constructed by using temporary pipes if necessary.

The long-term performance of the building is dependent upon satisfactory ongoing maintenance by the owner. The builder and owner should obtain a copy of the notes contained within the CSIRO – Building Technology Services, Foundation Maintenance and Footing Performance. A copy of this

manual can be purchased from CSIRO Publishing, <http://www.publish.csiro.au>. Earthworks shall comply with AS3798-2007 Guidelines on Earthworks for commercial and residential developments.

Appendix

9.1 Field photos



Photo 1: Field photo showing the soil profile of bore hole BH01.



Photo 2: Field photo showing the soil profile of bore hole BH02.

9.2 Bore hole logs

See attached.

9.3 Site plan

See attached.

9.4 Form 55

See attached.

Engineering Log - Bore hole

Project Number : H3069

Client:

Date:

1/08/2025

Project Address: 44 Alma Road Orford

Borehole Location:

Lat -042.547462° / Long +147.875769° (±2.1m)

Logged By: J Hepper

Drilling Method:

55mm Sitech Auger

Drilling Information					Observation / Notes		
Method	DCP Blows/100mm	Water	Depth (mm)	Group Symbol	Material Description: Colour, Structural, Fraction, Plasticity, Bedding, Additional	Moisture Condition	Consistency / Relative Density
	2		100	SC	FILL: Clayey SAND, trace gravel angular coarse to pebbles, inc. brick, trace rootlets.	M	L-MD
	4		200				
	5		300				
	4		400				
	5		500				
	5		600	Cl, CH	CLAY, with sand, brown, medium to high plasticity, slightly dispersive.	M	St >100 D
	3		700				
	5		800				
	7		900				
	11		1000				
	20+		1100	SC	Sandy CLAY, brown, medium plasticity, dispersive.	M	St >200 D
			1200		Auger refusal on assumed bedrock.		
			1300				
			1400				
			1500				
			1600				
			1700				
			1800				
			1900				
			2000				

Drilling Method

HA - Hand Auger
E - Excavator
WB - Wash Boring

Support

C- Casing

Sample and Tests

U - Undisturbed Sample
D - Disturbed Sample
PP - Pocket Penetrometer
DCP - Dynamic Cone Penetration Test
SPT - Standard Penetration Test
SV - Shear Vane Test

Classification Symbols and Soil Description

Based on Unified Soil Classification System and in accordance with AS1726

Moisture Condition

W - Wet
M - Moist
D - Dry

Consistency / Relative Density

VS - Very Soft L - Loose
S - Soft MD - Medium Dense
F - Firm D - Dense
St - Stiff VD - Very Dense
Vst - Very Stiff
H - Hard
Fr - Friable

Water

Level
Inflow
Partial Loss

Engineering Log - Bore hole

Project Number : H3069

Client:

Date:

1/08/2025

Project Address: 44 Alma Road Orford

Borehole Location:

Lat -042.547434° / Long +147.875906° (±2.2m)

Logged By: J Hepper

Drilling Method:

55mm Sitech Auger

Drilling Information					Observation / Notes		
Method	DCP Blows/100mm	Water	Depth (mm)	Group Symbol	Material Description: Colour, Structural, Fraction, Plasticity, Bedding, Additional	Moisture Condition	Consistency / Relative Density
	NR		100	SC	Some FILL: Clayey SAND, trace gravel, brown, trace rootlets	M	MD
	3		200				
	5		300				
	7		400	SC	Sandy CLAY, brown - grey slightly mottled orange, medium - high plasticity, slightly dispersive.	M	St >100 D
	10		500				
	10		600				
	9		700				
	6		800				
	10		900				
	20+		1000				
			1100		Auger refused on assumed bedrock		
			1200				
			1300				
			1400				
			1500				
			1600				
			1700				
			1800				
			1900				
			2000				

Drilling Method

HA - Hand Auger
E - Excavator
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F - Firm D - Dense
St - Stiff VD - Very Dense
Vst - Very Stiff
H - Hard
Fr - Friable

Water

Level
Inflow
Partial Loss

44 ALMA ROAD ORFORD
BORE HOLE / DCP LOCALITIES

⊗ BH01/
DCP01

44

⊗ BH02/
DCP02

46

42

03

Alma Road



CERTIFICATE OF QUALIFIED PERSON – ASSESSABLE ITEM

Section 321

Form **55**

To: [] Owner /Agent
[] Address
[] Suburb/postcode

Qualified person details:

Qualified person: [JOE HEPPER]
Address: [UNIT 2, 1 LIVERPOOL STREET] Phone No: [03 6146 0334]
[HOBART] [7000] Fax No: []
Licence No: [NA] Email address: [info@hed-consulting.com.au]

Qualifications and Insurance details: [BSc. major in geology
ABOUT UNDERWRITING
PN: ENG 20 000459] (description from Column 3 of the
Director's Determination - Certificates
by Qualified Persons for Assessable
Items)

Speciality area of expertise: [Foundation classification in
accordance with AS2870] (description from Column 4 of the
Director's Determination - Certificates
by Qualified Persons for Assessable
Items)

Details of work:

Address: [44 ALMA ROAD] Lot No: [1]
[ORFORD] [7190] Certificate of title No: [186679]

The assessable item related to this certificate: [Geo – technical assessment] (description of the assessable item being
certified)
Assessable item includes –
- a material;
- a design
- a form of construction
- a document
- testing of a component, building
system or plumbing system
- an inspection, or assessment,
performed

Certificate details:

Certificate type: [Foundation classification – AS2870] (description from Column 1 of
Schedule 1 of the Director's
Determination - Certificates by
Qualified Persons for Assessable
Items n)

This certificate is in relation to the above assessable item, at any stage, as part of - (tick one)

building work, plumbing work or plumbing installation or demolition work: ☒

or

a building, temporary structure or plumbing installation: ☐

In issuing this certificate the following matters are relevant –

Documents:

AS2870 Site Classification and AS4055 Wind Classification dated 8 August 2025.

Relevant
calculations:

References:

AS2870 – 2011, AS4055 – 2021

Substance of Certificate: (what it is that is being certified)

Foundation and wind classification

Scope and/or Limitations

Footings to be bedded / piered into competent bedrock.

Footings to inspected by engineer prior to pour.


Limitations as per section 9.0 of site investigation report dated 8 August 2025.

I certify the matters described in this certificate.

Qualified person:

Signed:

JOE HEPPE

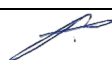


Certificate No:

H3069

Date:

8/8/2025

IMPORTANT NOTE:
BOUNDARIES CERTIFIED BY N.M.CREESE OF LARK & CREESE

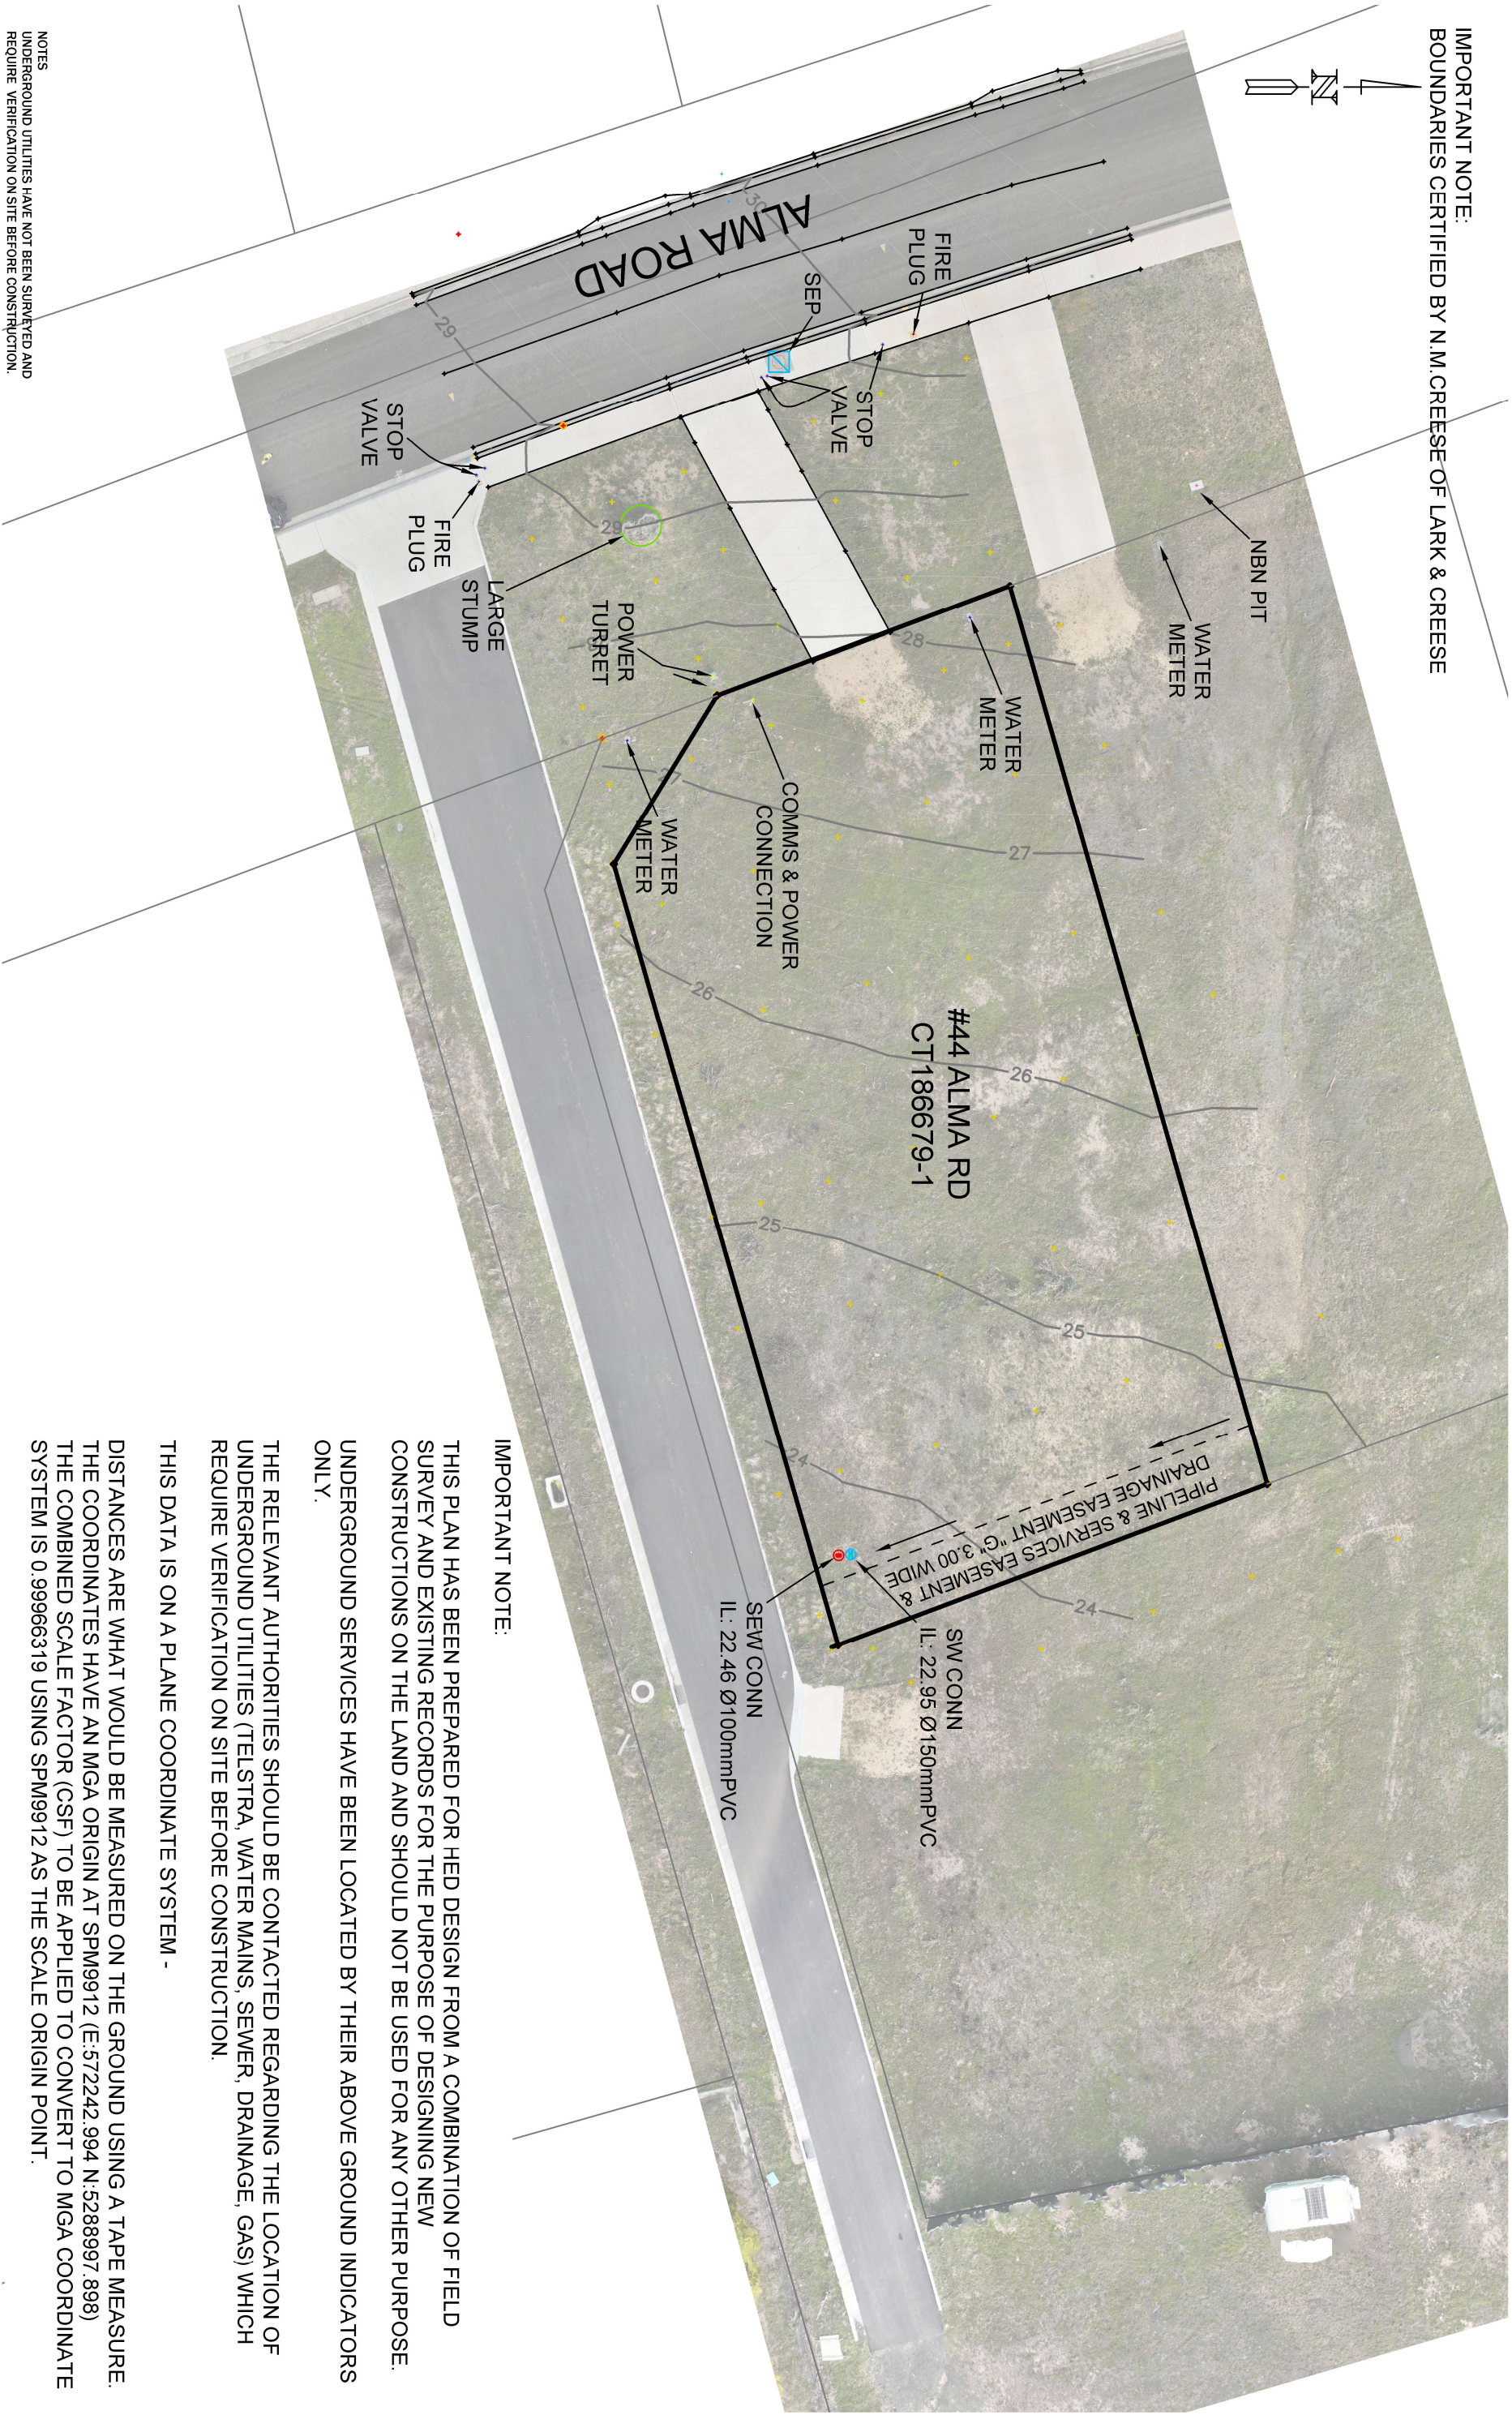

NOTES
UNDERGROUND UTILITIES HAVE NOT BEEN SURVEYED AND
REQUIRE VERIFICATION ON SITE BEFORE CONSTRUCTION.

IMPORTANT NOTE:
THIS PLAN HAS BEEN PREPARED FOR HED DESIGN FROM A COMBINATION OF FIELD SURVEY AND EXISTING RECORDS FOR THE PURPOSE OF DESIGNING NEW CONSTRUCTIONS ON THE LAND AND SHOULD NOT BE USED FOR ANY OTHER PURPOSE.
UNDERGROUND SERVICES HAVE BEEN LOCATED BY THEIR ABOVE GROUND INDICATORS ONLY.

THE RELEVANT AUTHORITIES SHOULD BE CONTACTED REGARDING THE LOCATION OF UNDERGROUND UTILITIES (TELSTRA, WATER MAINS, SEWER, DRAINAGE, GAS) WHICH REQUIRE VERIFICATION ON SITE BEFORE CONSTRUCTION.

THIS DATA IS ON A PLANE COORDINATE SYSTEM -

DISTANCES ARE WHAT WOULD BE MEASURED ON THE GROUND USING A TAPE MEASURE.
THE COORDINATES HAVE AN MGA ORIGIN AT SPM9912 (E:572242.994 N:528897.898)
THE COMBINED SCALE FACTOR (CSF) TO BE APPLIED TO CONVERT TO MGA COORDINATE SYSTEM IS 0.99966319 USING SPM9912 AS THE SCALE ORIGIN POINT.

AM

ARTHUR MOEHRKE SURVEYS

ARTHUR MOEHRKE
SURVEYS PTY LTD
ABN: 69 661 947 557

SURVEYING TASMANIA FOR YOU

ARTHUR MOEHRKE
SURVEYS PTY LTD
ABN: 69 661 947 557

NO	DATE	DRN	CHKD	FIRST ISSUE	DESCRIPTION
0	20/08/25	AM	AM		

This plan is not intended for attachment to
sale contract documents

OUR REF: HED2508 ORFORD D01			
CONTOUR INTERVAL: 200mm			
DATUM: PLANE MGA BASED ON SPM9912			
SCALE: 1:300 @ A3			
DATE OF SURVEY: 18/08/25			
DRAWING No: 01		REV 00	SHEET No: 1 OF 1

COUNCIL APPROVAL

(Insert any qualification to the permit under section 83(5), section 109 or section 111 of the Local Government (Building & Miscellaneous Provisions) Act 1993)
The subdivision shown in this plan is approved

Registered Number

SP186679



In witness whereof the common seal of Glamorgan Spring Bay Council
has been affixed, pursuant to a resolution of the Council of the said municipality
passed the 10th day of July 2024, in the presence of us

Member

Member Alex Woodward Acting General Manager

Council Delegate [Signature]

Council Reference SA2020/009

NOMINATIONS

For the purpose of section 88 of the Local Government (Building & Miscellaneous Provisions) Act 1993
the owner has nominated

BUTLER McINTYRE AND BUTLER LAWYERS Solicitor to act for the owner

PDA SURVEYORS, ENGINEERS & PLANNERS Surveyor to act for the owner

PDA ref: 47605NG

OFFICE EXAMINATION:

Indexed ✓

Computed ✓

Examined MG 5/8/24

SEARCH OF TORRENS TITLE

VOLUME 186679	FOLIO 1
EDITION 4	DATE OF ISSUE 06-Sept-2025

SEARCH DATE : 15-Jan-2026

SEARCH TIME : 10.46 am

DESCRIPTION OF LAND

Parish of TRIABUNNA Land District of PEMBROKE

Lot 1 on Sealed Plan [186679](#)

Derivation : Part of Lot 9974, 55A-3R-0P Gtd. to Anna Rosa Budd

Prior CT [35054/1](#)SCHEDULE 1

[N248129](#) TRANSFER to Registered
10-Apr-2025 at noon

SCHEDULE 2

Reservations and conditions in the Crown Grant if any

[SP186679](#) EASEMENTS in Schedule of Easements[SP186679](#) FENCING PROVISION in Schedule of Easements[E391420](#) AGREEMENT pursuant to Section 78 of the Land Use

Planning and Approvals Act 1993 Registered

20-Aug-2024 at noon

[E424096](#) MORTGAGE to Teachers Mutual Bank Limited Registered

06-Sept-2025 at noon


UNREGISTERED DEALINGS AND NOTATIONS


No unregistered dealings or other notations


<p>OWNER: ORFORD DEVELOPMENTS PTY LTD</p> <p>FOLIO REFERENCE: F.R.35054/1</p> <p>GRANTEE: Part of Lot 9974 Gtd to Anna Rosa Rudd</p>	<p>PLAN OF SURVEY</p> <p>BY SURVEYOR: C. M. TERRY of OPDA <small>SURVEYORS, ENGINEERS & PLANNERS</small></p> <p>127 BATHURST STREET, HOBART</p> <p>LOCATION: Parish of TRIABUNNA, Land District of PEMBROKE</p>	<p>REGISTERED NUMBER SP186679</p> <p>APPROVED EFFECTIVE FROM 20 AUG 2024</p> <p><i>[Signature]</i> Recorder of Titles</p>
<p>SCALE 1: 750 LENGTHS IN METRES SURVEYORS REF 47605NG</p>		<p>ALL EXISTING SURVEY NUMBERS TO BE CROSS REFERENCED ON THIS PLAN</p>
<p>PRIORITY FINAL PLAN</p>		

INDEX PLAN

<p><i>[Signature]</i> Registered Land Surveyor</p> <p>11/2/2024 Date</p>	<p><i>[Signature]</i> Council Delegate</p> <p>10/07/24 Date</p>
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Unit 2, 1 Liverpool St
Hobart, Tas. 7000

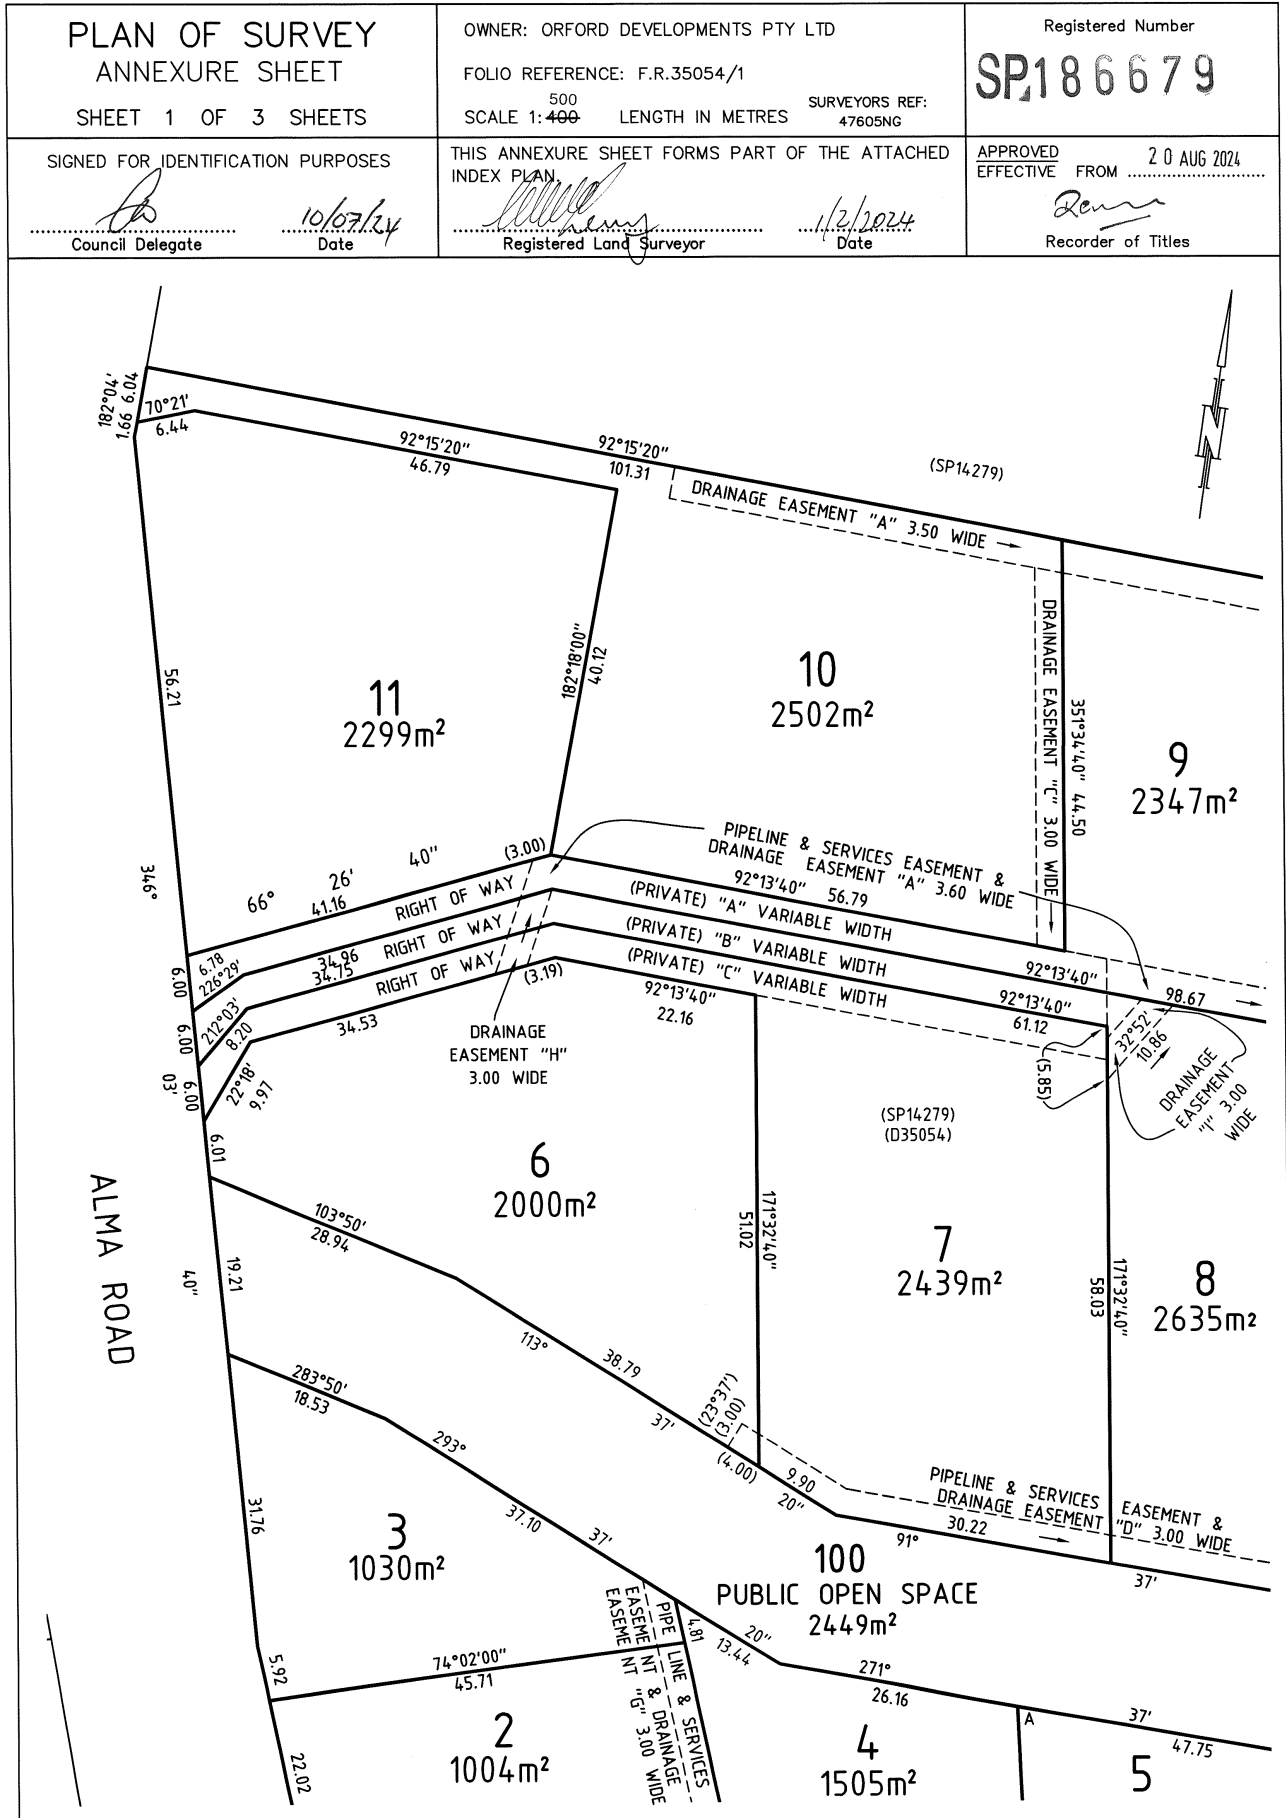P 03 6146 0334
E info@hed-consulting.com.au

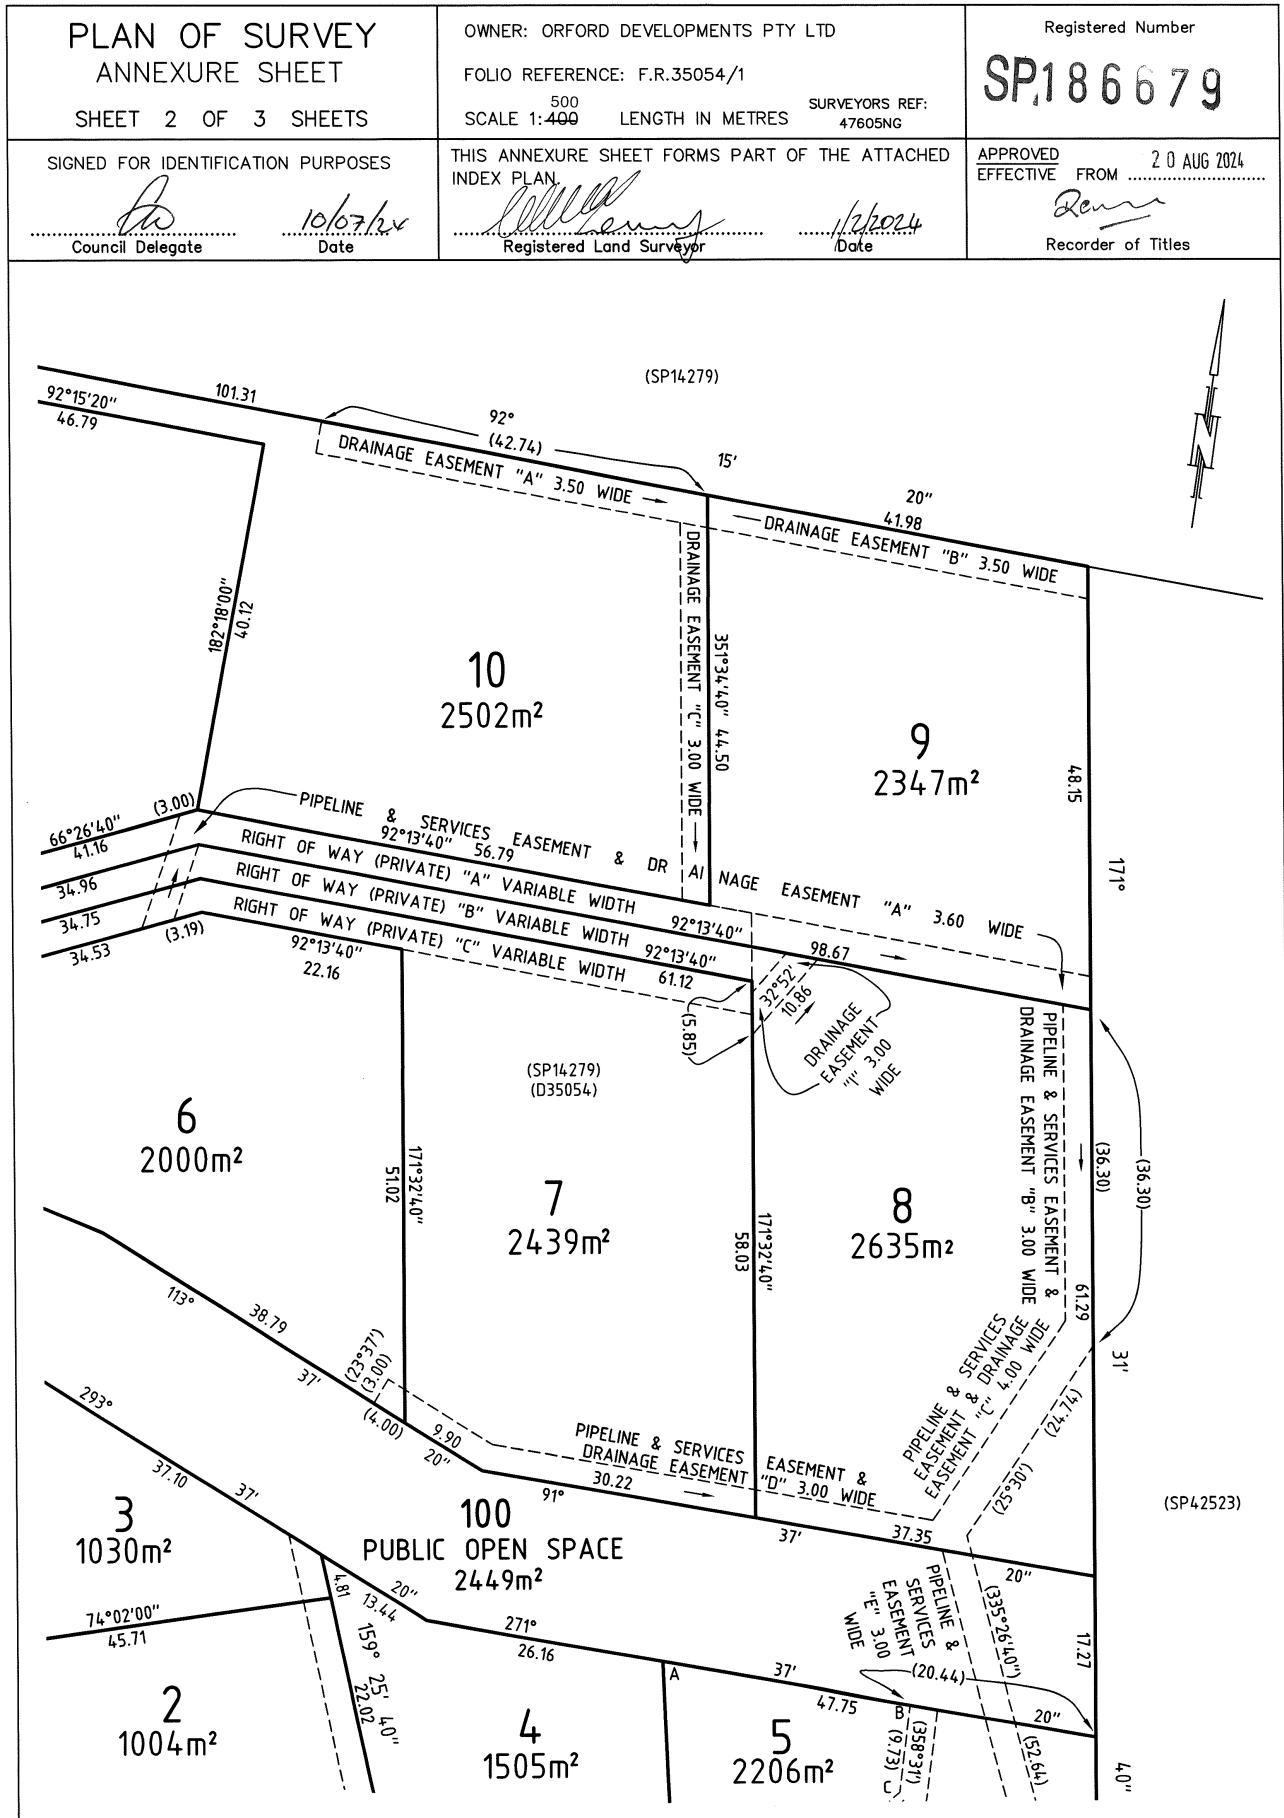BUSHFIRE HAZARD REPORT & BUSHFIRE HAZARD MANAGEMENT PLAN

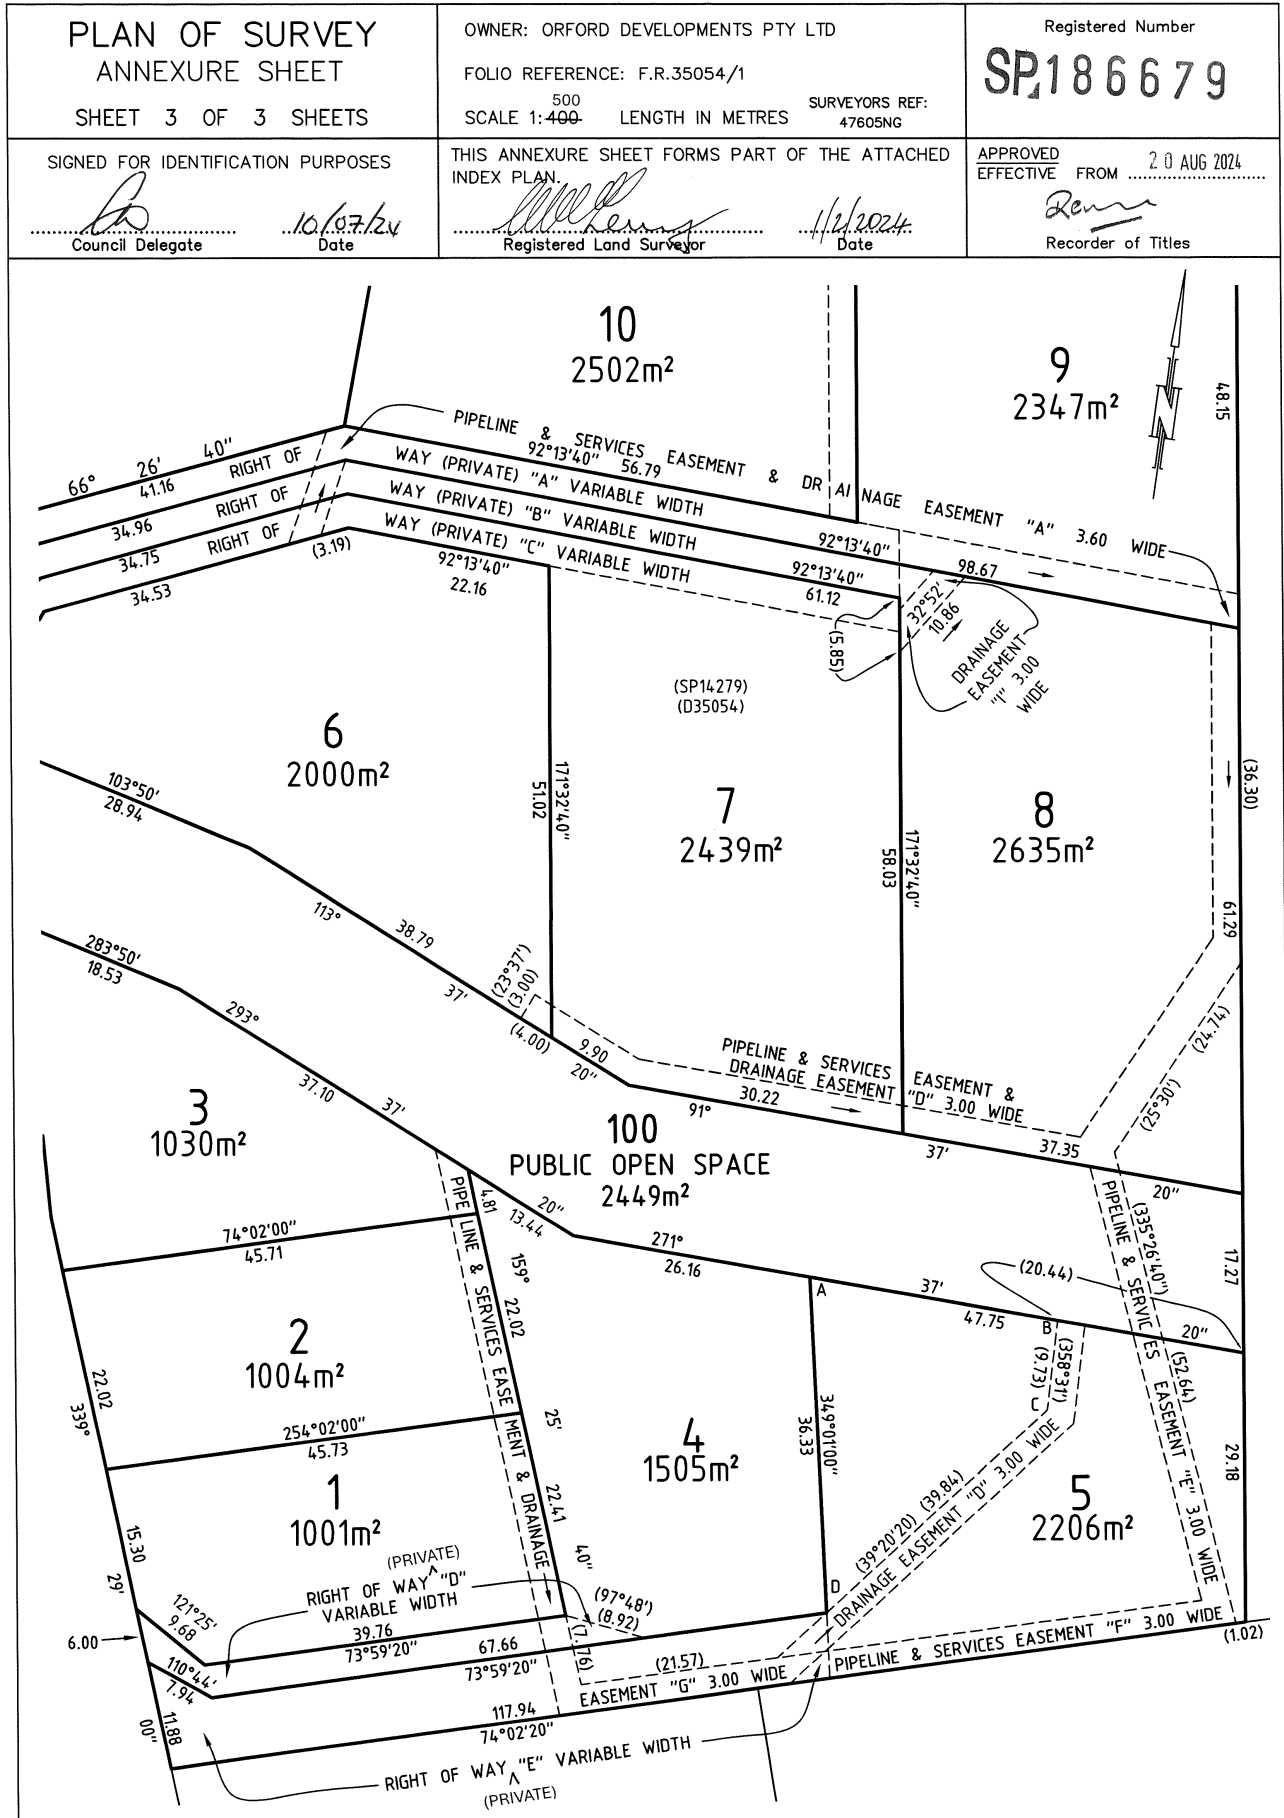

NEW RESIDENTIAL DWELLINGS X 2

**44 ALMA ROAD
ORFORD 7190**

1 SEPTEMBER 2025 – VERSION 1.0

EXECUTIVE SUMMARY

The subject land is located at 44 Alma Road, Orford. The proposed development includes the construction of two new single residential dwelling (Class 1a buildings). The site and proposed development are assessed to comply with the requirements of AS3959-2018 *Construction of Buildings in bushfire-prone areas*, Tasmanian Planning Scheme, Director's Determination – Bushfire Hazard Areas v1.2 (Determination), Building Regulations 2016.

If design and construction for the building works comply with the BAL – 19 of AS3959-2018 and provisions provided by the Bushfire Hazard Management Plan (BHMP) are implemented and maintained, the bushfire risk is reduced and the residual risk is deemed to be acceptable. The bushfire hazard management plan (BHMP) is certified as meeting the Deemed-to-Satisfy (DtS) requirements in the Determination.

LIMITATIONS

This report is based on findings concluded from a desktop and field investigation of the subject property. Classification of vegetation has been based on the site inspection and does not account for any further growth of existing or new vegetation.

The assessment is based on information provided at the time of the report. If the location of the proposed development differs from the location shown in the Bushfire Hazard Report and Bushfire Hazard Management Plan the author must be contacted otherwise both the report and plan is void.

The BAL assessment is based on the Fire Danger Index (FDI) of 50. The FDI will exceed 50 when the Australian Fire Danger Rating System is Extreme or Catastrophic.

The forward of AS3959 – 2018, *Construction of buildings in bushfire prone areas* states that “It should be borne in mind that the measures contained in this standard cannot guarantee that a building will survive a bushfire event on every occasion. This is substantially due to the degree of vegetation management, the unpredictable nature and behaviour of fire, and extreme weather conditions.”

Due to the unpredictable nature and behaviour of fire, compliance with AS359-2018 does not guarantee a dwelling will survive a bushfire event.

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1.0 INTRODUCTION

1.1 SCOPE

To determine a Bushfire Attack Level in accordance with *AS3959 – 2018 Construction of buildings in bushfire-prone areas* and assess the site against the *Director's Determination – Bushfire Hazard Areas v1.2*.

1.2 PROPOSAL

Two new residential dwellings.

1.3 GENERAL INFORMATION

SITE ADDRESS

44 Alma Road Cygnet

OWNER

Claire Horner

TITLE REFERENCE

C.T. 186679/1

PROPERTY ID NUMBER

9087544

PROPERTY SIZE

993m² (approximate)

PROPOSED DEVELOPMENT AREA SIZE

Two residential dwellings

MUNICIPALITY

Glamorgan Spring Bay Council

ZONING

Low Density Residential, Tasmanian Planning Scheme

2.0 SITE DESCRIPTION

2.1 LOCALITY

The subject land is located at 44 Alma Road, Orford. The site located on the lower slopes of Rudds Hill with developing residential surrounds to the north, east and south. Further to the west, beyond Alma Road a large area of bushland extends up Rudds Hill. The closest nearby safer place is located at the Orford Golf Course which is a 2-minute drive from the site.



Figure 1: Locality map of the area with subject lot and proposed building area shown (red fill and blue circle). Source: Land Information System Tasmania, <http://www.thelist.tas.gov.au>

The property is accessed from Alma Road, which is a dual lane, sealed and council-maintained road.

2.1.2 FIRE HISTORY

Recent bushfires¹ / planned burns have burnt within 1km of the subject lot.

Ignition date	Fire / Planned burn name	Type	Size	Distance to site
1/12/2021	ORF_02AP	Planned burn	88.29 ha	250m
18/4/2018	Station Creek	Planned burn	1158.45 ha	92m

¹ Information sourced from Fire History Layer from <http://www.thelist.tas.gov.au>, this is an incomplete search and does not show most of the historic bushfire and burns.

2.1.2 PLANNING – ZONING & TENURE

The lot is zoned as Low Density Residential and is privately owned. Zoning and tenure of surrounding lots is shown below (within 100m from property boundaries).

Direction	Zoning	Tenure
North	Low Density Residential	Private Freehold & Local Government Act Reserve
East	Low Density Residential	Private Freehold
South	Low Density Residential	Private Freehold
West	Low Density Residential & General Residential	Private Freehold

2.1.3 PLANNING – OVERLAYS

Overlay	Within proposed Hazard Management Area (HMA)	Development Response
Bushfire-prone areas	Yes	The Bushfire Hazard Report and BHMP satisfy this code.

2.1.4 PLANNING – THREATENED FLORA AND FAUNA

A threatened flora and fauna search² revealed no threatened flora and fauna on the subject land.

² Threatened species search using Land Information Systems Tasmania. This is not a complete search and other information may be available from other agencies.

2.2 TOPOGRAPHY & VEGETATION



Figure 2: Aerial photo of the area with proposed development and existing buildings shown. The yellow circle is a minimum 100m from edge of the proposed building. Classified vegetation and exclusions shown. Source: Land Information System Tasmania, <http://www.thelist.tas.gov.au>.

The subject lot is mapped as FAG – Agricultural Land (TAS Veg 4.0) and towards the north and east. FUR – Urban area (Tas Veg 4.0) is mapped towards the south and along Alma Road. Tree vegetation towards the west is mapped as DPU – Eucalyptus pulchella forest and woodland.

Vegetation types and effective slope shown below. Distance measured from the edge of the lot.

Direction	Distance from site and vegetation description	Effective slope
North	<p>0m: Vacant lots managed in minimal fuel condition³.</p> <p>Exclusion: Low threat vegetation as per clause 2.2.3.2 (f) of AS3959:2018.</p> <p>20m: Riparian strip along existing drainage channel. Future shrub plantings and other vegetation.</p> <p>Classified vegetation: D: Scrub</p> <p>38m: Vacant lots managed in minimal fuel condition.</p> <p>Exclusion: Low threat vegetation as per clause 2.2.3.2 (f) of AS3959:2018.</p>	Upslope / 0°
East	<p>0m: Vacant lots managed in minimal fuel condition.</p> <p>Exclusion: Low threat vegetation as per clause 2.2.3.2 (f) of AS3959:2018.</p> <p>50m: Riparian strip along existing drainage channel. Future shrub plantings and other vegetation.</p> <p>Classified vegetation: D: Scrub</p> <p>78m: Dense pasture with over storey foliage cover estimated to be <10%.</p> <p>Classified vegetation: G: Grassland</p>	Downslope >0° - 5°
South	<p>0m: Roadway and road reserve.</p> <p>Exclusion: Low threat vegetation as per clause 2.2.3.2 (e) & (f) of AS3959:2018.</p> <p>10.7m: Dense pasture, periodically cured. Isolated tree vegetation. Over storey foliage cover <10%.</p> <p>Classified vegetation: G: Grassland</p> <p>80m: Managed residential gardens and lawn.</p> <p>Exclusion: Low threat vegetation as per clause 2.2.3.2 (f) of AS3959:2018.</p>	Upslope / 0°

³ Bushfire Hazard Report, Proposed Subdivision, 66 Alma Road Orford, PDA Surveyors dated 30 June 2020.

West	<p>0m: Dense pasture, vegetation to be managed in 'minimal fuel condition.'</p> <p>Exclusion: Low threat vegetation as per clause 2.2.3.2 (f) of AS3959:2018.</p> <p>75m: Over storey of eucalypts with a canopy height of 20m. Under storey of smaller trees, shrubs and grass. Overall foliage cover estimated to be between 30-70%.</p> <p>Classified vegetation: A: Forest</p>	Upslope / 0°
-------------	--	---------------------

3.0 BUSHFIRE SITE ASSESSMENT

3.1 EXISTING BUSHFIRE HAZARD ASSESSMENT

3.1.1 CONSTRUCTION & DESIGN

No existing buildings on site subject lot.

3.1.2 PROPERTY ACCESS

The property is accessed from Bedford Street. The existing property access has a length <30m, gravel and terminates near the sheds at the southern end of the property.

3.1.3 WATER SUPPLY

The site has a reticulated water supply. Fire hydrants are located along the east side of Bedford Street.

3.1.4 HAZARD MANAGEMENT AREA

At the time of inspection, the lot was well maintained with ground fuels cleared and lawn kept to a short height.

3.1.5 EMERGENCY PLAN

No emergency plan exists for the subject lot.

3.2 BUSHFIRE ATTACK LEVEL ASSESSMENT

Proposed residential dwelling x 2

	North	East	South	West
Vegetation classification as per AS3959:2018	Scrub	Scrub & Grassland	Grassland	Forest
Exclusions (where applicable from clause 2.2.3.2 of AS3959 - 2018)				
Distance to classified vegetation (m) from proposed / existing edge of building.	20	>100	10.7	75
Classified vegetation	Scrub	Scrub	Grassland	Forest
Effective slope under the classified vegetation	Upslope / 0°	Downslope >0° - 5°	Upslope / 0°	Upslope / 0°
Minimum separation distance to achieve BAL – 19.	19m	22m	10m	23m
Minimum separation distance to achieve BAL – 12.5.	27m	31m	14m	32m
Minimum Hazard Management Area Dimensions	To property boundary	To property boundary	To property boundary	To property boundary

The assessment is based on a FDI of 50. The FDI will exceed 50 when the Australian Fire Danger Rating System is Extreme or Catastrophic.

4.0 BUSHFIRE HAZARD MANAGEMENT REQUIREMENTS

The following bushfire hazard management requirements are required comply with the DtS provisions of the Determination. A DtS solution which complies with the following DtS provisions is deemed to achieve compliance with the Performance Requirements in the Determination.

4.1 Design and Construction

4.1.1 Deemed-to-Satisfy Provisions

(1) Building work (including additions or alterations to an existing building) in a bushfire-prone area must be designed and constructed in accordance with the relevant Deemed-to-Satisfy provisions of:

- (a) NCC Volume 1, Part G5 for Class 2 or Class 3 Buildings or Certain Class 9 Buildings and a Class 10a Building or deck associated with a building to which this Division applies.
- (b) NCC Volume 2, Part H7 for Class 1 building and Class 10a Building or deck associated with a building to which the Division applies.

(2) Despite subclause (1) is above, permissible variations are specified in Table 1 below for Class 1, Class 2 and Class 3 Buildings and an associated Class 10a Building or deck.

(3) Performance Requirements for buildings subject to BAL – 40 or BAL Flame Zone (BAL-FZ) cannot be satisfied by Deemed-to-Satisfy provisions and must be satisfied by means of a Performance Solutions

4.1.2 Proposed Development Solutions

(1) The proposed building works shall comply with DtS provisions of Part H7 of the NCC 2022.

(2) Permissible variations (if any) are demonstrated in Table 1 within the appendix of this report.

(3) Not applicable – Site is not assessed as BAL 40 or BAL Flame Zone.

4.2 Property Access

4.2.1 Deemed-to-Satisfy Provisions

(1) The following building work must be provided with property access to the building and the firefighting water point, accessible by a carriageway, designed and constructed as specified in subclause (4) below:

- (a) a new habitable building
- (b) a new Class 10a Building to which this Division applies, if not accessible using an existing property access.

(2) For an addition or alteration to an existing building in a bushfire-prone area, if there is no property access available, property access must be provided to the building and the firefighting water point accessible by a carriageway as specified in subclause (4).

(3) An addition or alteration to an existing building in a bushfire-prone area must not restrict any existing property access to the building or the water supply for firefighting.

(4) Vehicular access from a public road to a building must:

- (a) comply with the property access requirements specified in Table 2;
- (b) include access from a public road to a hardstand within 90 metres of the furthest part of the building as measured by a hose lay;
- (c) include access to the hardstand area for the firefighting water point.

(5) Certain Class 9 Buildings have additional property access requirements as specified in Table 2.

4.2.2 Proposed Development Solutions

(1) Proposed works are for habitable buildings and thus the property access shall be designed and constructed with accordance to subclause (4). Property access requirements for Table 2 are shown in the appendix of this report.

(2) Not applicable – Proposed works are not for an addition to existing building.

(3) Not applicable – Proposed works are not for an addition to existing building.

(4) The proposed property access shall comply with subclause (4).

(5) Not applicable – Proposed works are for a not for a certain Class 9 building.

4.3 Water Supply for Fire Fighting

4.3.1 Deemed-to-Satisfy Provisions

- (1) The following building work must be provided with a water supply dedicated for firefighting purposes which complies with the requirements specified in Table 3A or Table 3B:
 - (a) a new habitable building; or
 - (b) a new Class 10a Building to which this division applies; if not protected by an existing firefighting water supply.
- (2) For an addition or alteration to an existing building in a bushfire-prone area, if there is no water supply for firefighting available, the building must be provided with a water supply for firefighting purposes which complies with the requirements specified in Table 3A or Table 3B.
- (3) Certain Class 9 Buildings have specific requirements for water supply for firefighting as specified in Table 3A or Table 3B.

4.3.2 Proposed Development Solutions

- (1) The existing reticulated water supply dedicated for firefighting purposes complies with the requirements specified in Table 3A.
- (2) Not applicable – Proposed building works is not for additions or alteration to an existing building.
- (3) Not applicable – Proposed building works is not for a Class 9 building.

4.4 Hazard Management Areas

4.4.1 Deemed-to-Satisfy Provisions

- (1) The following building work must be provided with a hazard management area of sufficient dimensions and which provides an area around the building which separates the building from the bushfire hazard and complies with subclause (2), (3), (4) and (5):
 - (a) a new habitable building;
 - (b) an existing building in the case of an addition or alteration to a building; or
 - (c) a new Class 10a Building to which this Determination applies unless fire separation is provided in accordance with clause 3.2.3 of AS3959.
- (2) The hazard management area must comply with the requirements specified in Table 4.
- (3) The hazard management area for a particular BAL must have the minimum dimensions required for the separation distances specified for the BAL in Table 2.6 of AS 3959 (Method 1)
- (4) The hazard management area must be established and maintained such that fuels are reduced sufficiently, and other hazards are removed such that the fuels and other hazards do not significantly contribute to the bushfire attack.
- (5) Certain Class 9 Buildings have additional requirements for hazard management areas as specified in Table 4.

4.4.2 Proposed Development Solutions

- (1) The new buildings must be provided with a hazard management area of sufficient dimensions and provides an area around the building that separates the building from the bushfire hazard. The hazard management area must comply with subclauses (2), (3), (4) and (5) below.
- (2) The hazard management area shall comply with the requirements specified in Table 4.
- (3) The hazard management area must have minimum dimensions required for the separation distances specified in Table 2.6 of AS 3959 (Method 1).
- (4) The hazard management area shall be established and maintained such that fuels are reduced sufficiently, and other hazards are removed such that the fuel s and other hazard do not significantly contribute to the bushfire attack. The hazard management area shall be installed as per the certified BHMP
- (5) Not applicable – Proposed building works are for Class 1a building.

4.5 Bushfire Emergency Plan

4.5.1 Deemed-to-Satisfy Provisions

(1) In a bushfire prone area, a bushfire emergency plan must be prepared for:

- (a) a new building
- (b) an existing building in the case of an addition or alteration to a building;
- (c) an existing building in the case of a change of building class;
- (d) a building associated with the use, handling, generation or storage of a hazardous chemical or explosive;
- (i) clause (1) does not apply to following:
 - (a) Class 1a Buildings;
 - (b) Class 10a Buildings; or
 - (c) decks associated with another class of building.

(2) A bushfire emergency plan must comply with the requirements specified in Table 5.

4.5.2 Proposed Development Solutions

(1) A bushfire emergency plan is not required for a residential building (Class 1a).

(2) Not applicable (as above).

5.0 CONCLUSIONS AND RECOMMENDATIONS

A bushfire hazard assessment report has been completed for the proposed development which includes the construction of two residential dwellings on the subject lot.

The site is within 100m of bushfire-prone vegetation greater than 1Ha in area and is within the Bushfire Prone Area overlay. The bushfire attack level for the proposed development with the proposed HMA installed has been assessed as BAL – 19. The building works shall be constructed to BAL – 19 construction requirements as per section 3 and 5 of AS3959:2018.

For client information minimum separation distance for BAL – 12.5 has also been provided. A building must be located wholly within the BAL – 12.5 separation distance to apply to the building.

The proposed property access shall comply with the DtS provisions of the Determination including Table 2.

The existing reticulated water supply for firefighting purposes complies with the DtS provisions of the Determination including Table 3A.

The BHMP is certified and meets the DtS provisions of the Determination.

This Bushfire Hazard Report and BHMP does not endorse the removal of any vegetation without the approval from the local government authority.

It is the owners' responsibility to ensure that the requirements of the bushfire assessment report and bushfire hazard management plan are implemented and maintained for the life of the development.

6.0 REFERENCES

AS3959 – 2018 - Construction of Buildings in Bushfire Prone Areas

Director's Determination – Bushfire Hazard Areas, version 1.2

Building regulations 2016

The LIST - Department of Primary Industries Parks Water & Environment

Tasmanian Planning Scheme

Bushfire Hazard Report, Proposed Subdivision, 66 Alma Road Orford, dated 30 June 2020

7.0 APPENDIX

7.1 FIELD PHOTOS



Photo 1: Photo facing north from the subject lot. Exclusion: Low threat vegetation as per clause 2.2.3.2 (f) of AS3959:2018 shown.



Photo 2: Photo facing east from the subject lot. Exclusion: Low threat vegetation as per clause 2.2.3.2 (f) of AS3959:2018 shown.

Date & Time: Fri, 01 Aug 2025 at 09:31:47 AEST
Position: -042.547499° / +147.875917° (±4.7m)
Altitude: 27m (±3.0m)
Datum: AUSTRALIAN GEOCENTRIC 2020 (GDA2020)
Azimuth/Bearing: 181° S01W 3218mils True (±11°)
Elevation Angle: +03.6°
Horizon Angle: +02.9°
Zoom: 0.5X



Photo 3: Photo facing south from the subject lot. Exclusion: Low threat vegetation as per clause 2.2.3.2 (e) & (f) of AS3959:2018 shown in the foreground and G: Grassland in the background.

Date & Time: Fri, 01 Aug 2025 at 09:32:16 AEST
Position: -042.547480° / +147.875684° (±4.7m)
Altitude: 30m (±3.0m)
Datum: AUSTRALIAN GEOCENTRIC 2020 (GDA2020)
Azimuth/Bearing: 270° N90W 4800mils True (±11°)
Elevation Angle: +15.2°
Horizon Angle: -00.1°
Zoom: 0.5X



Photo 4: Photo facing west from the subject lot. Exclusion: Low threat vegetation as per clause 2.2.3.2 (f) of AS3959:2018 shown in the foreground and A: Forest in the background.




Photo 5: Example of Classified vegetation: G: Grassland towards the south from the subject lot.

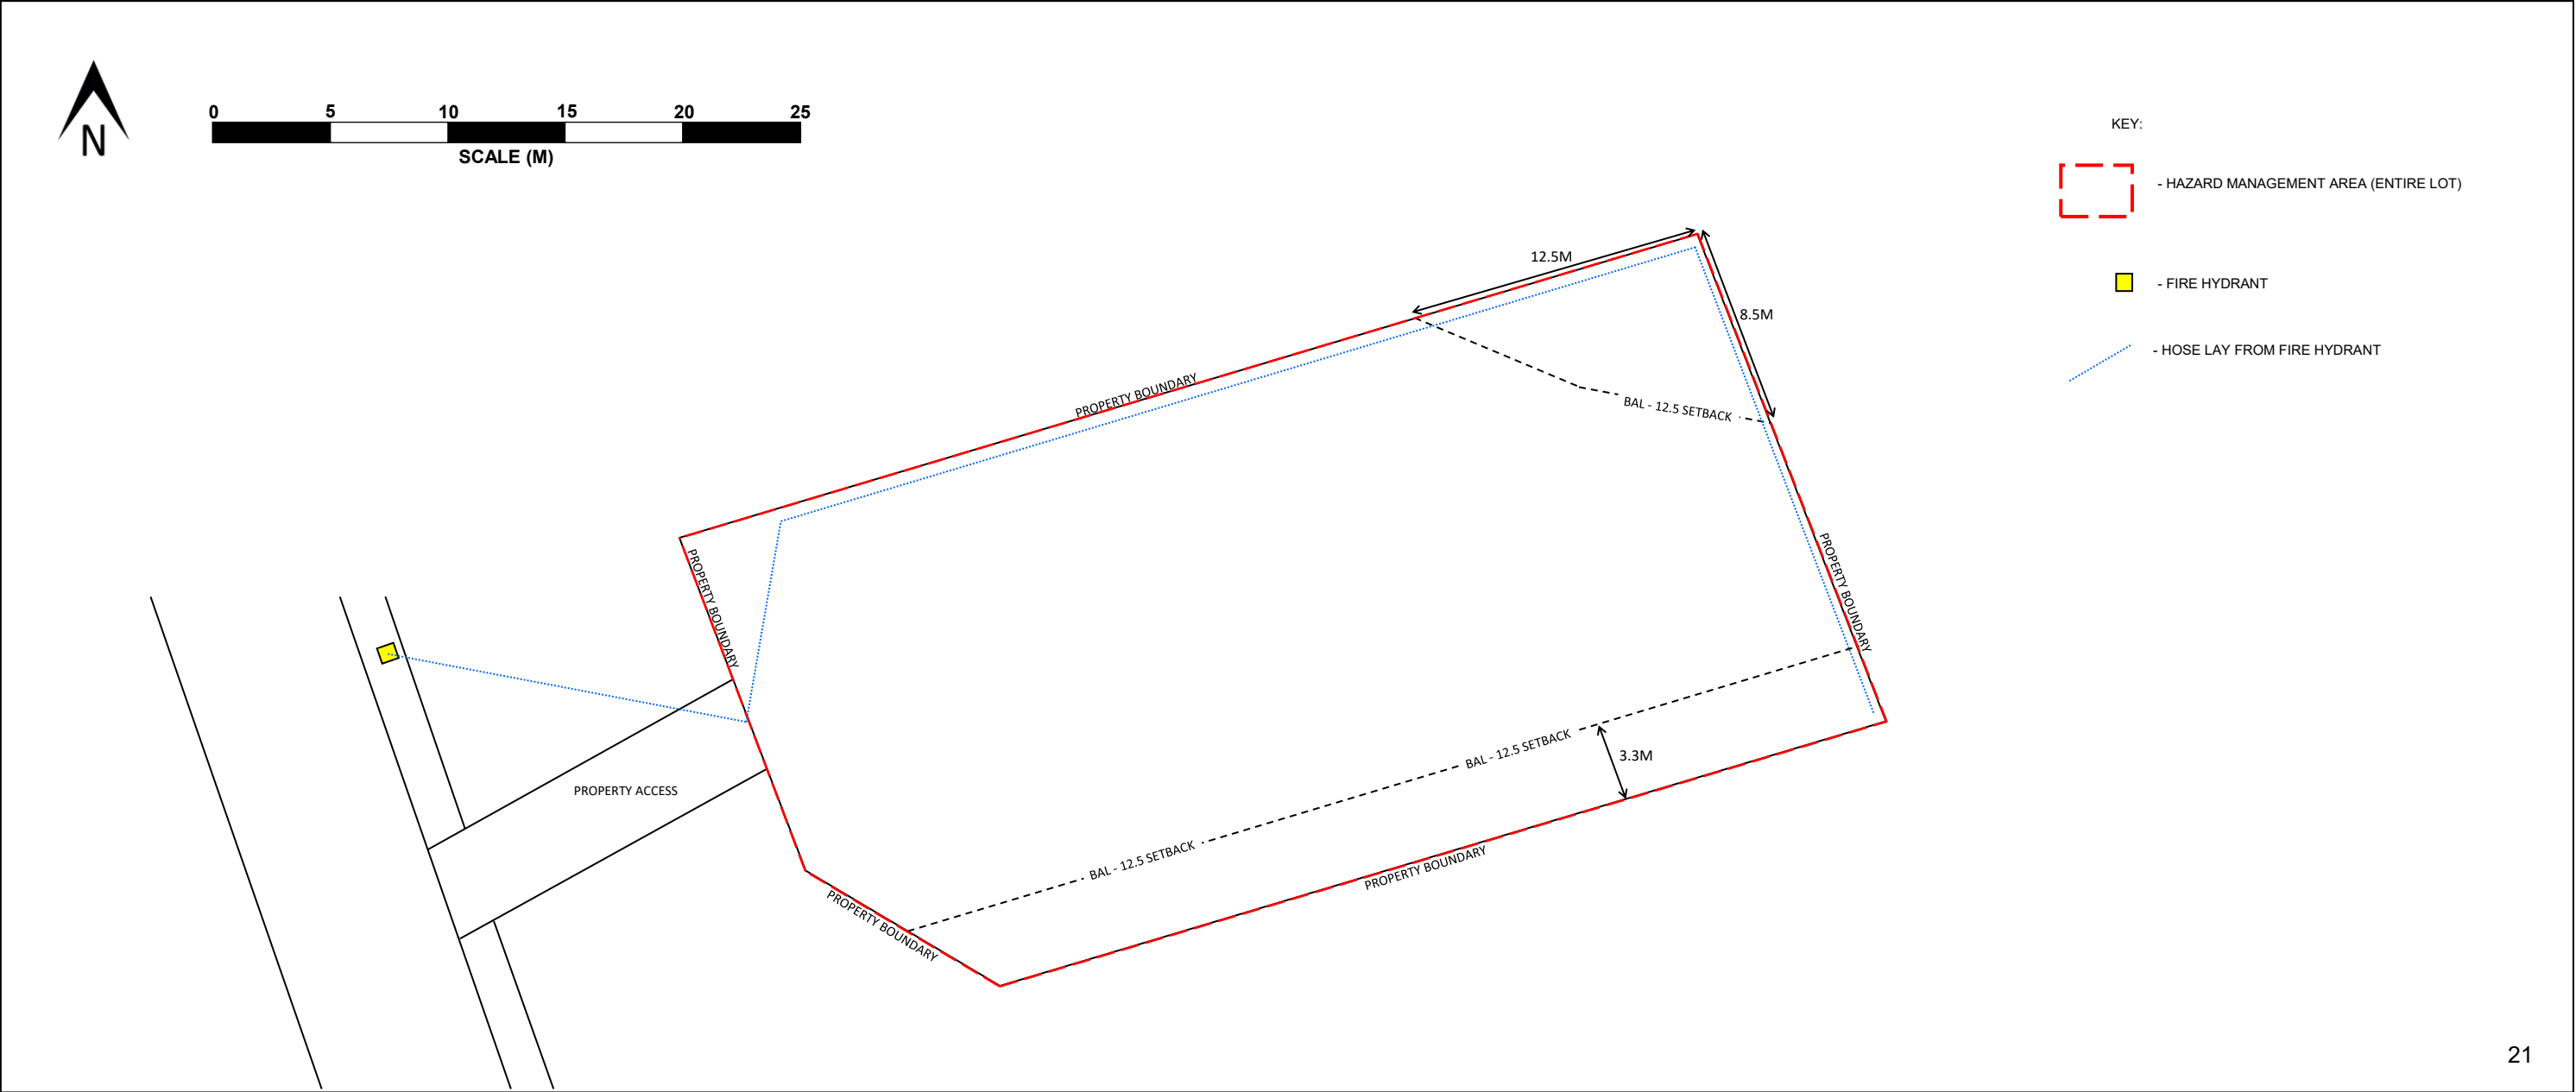


Photo 6: Field photo showing an example of Classified vegetation: A: Forest shown towards west of the subject lot.



Photo 7: Field photo showing location of fire hydrant adjacent the subject lot. Car is park on property access.

BUSHFIRE HAZARD MANAGEMENT REQUIREMENTS		BUSHFIRE HAZARD MANAGEMENT PLAN
1. <u>Building Design & Construction</u>	<ul style="list-style-type: none"> - Minimum separation distances shown on this plan provide for a BAL - 19 solution. - Building works must be designed and constructed to comply with AS3959:2018 - Section 3 for General Requirements and Section 6 for BAL - 19 requirements. - BAL - 12.5 setback also shown. Buildings wholly constructed within this setback can be constructed to BAL - 12.5 requirements (Section 3 and Section 5 of the AS3959:2018). 	CLIENT: 44 ALMA ROAD ORFORD 7190 ADDRESS: 9087544 CT: 186679/1 PROPERTY ID: 1/9/2025 DATE: 1.0 VERSION: JOE HEPPER CERTIFIED BY: BUSHFIRE PRACTITIONER (BFP - 148, SCOPE 1, 2, 3A, 3B) SIGNED:
2. <u>Property Access</u>	<ul style="list-style-type: none"> - Property access is not required for fire appliance to access the fire fighting water point. There are no specified property access design and construction requirements for firefighting purposes. 	
3. <u>Reticulated Water Supply For Firefighting</u>	<ul style="list-style-type: none"> - Water supply for fire fighting is provided by the existing fire hydrant located within less than 120m of the furthest element of the habitable building measured as a hose lay. - Carriageway of the public road serves as hardstand. 	 1-7 LIVERPOOL STREET HOBART TAS 7000 P 03 6146 0334 / E info@hed-consulting.com.au
4. <u>Hazard Management Area (HMA)</u>	<ul style="list-style-type: none"> - The dimensioned HMA to be managed as defensible space from a bushfire flame, radiant heat and ember attack. - Maintain in minimal fuel condition in perpetuity, ensuring all fuels are reduced significantly and other hazards are removed such that the fuels and other hazards do not significantly contribute to the bushfire attack. - Limited amounts of low flammability plants are acceptable within the HMA. This includes maintained lawn, low growing plants and ground covers, low flammability ornamental gardens, vegetable gardens and similar. - Do not plant adjacent to walls & decks or directly below glazed elements. - Ground fuels such as fallen branches, sticks, leaves, bark, lawn clippings etc. to be removed regularly. - Maintain lawn height to less than 100mm. - Non - combustible ground cover of small rock and pebbles to be used instead of pine bark or mulch. - Thin-out understory vegetation and prune low-hanging tree branches. Prune canopies to maintain horizontal separation between canopies. - Minimise storage of flammable materials such as firewood and building materials. - Keep roof gutters clear of leaves and other debris. 	



7.3.1 DIRECTOR'S DETERMINATION – BUSHFIRE HAZARD AREAS V1.2

Table 1 – Construction Requirements and Construction Variations

Column 1		Column 2	Proposed development can satisfy	Development response
Element		Requirement		
A.	Straw Bale Construction	May be used in exposures up to and including BAL 19.	Yes	Straw Bale Construction is acceptable.
B.	Shielding provisions under Section 3.5 of AS3959-2018.	<p>To reduce construction requirements due to shielding, building plans must include suitable detailed elevations or plans that demonstrate that the requirements of Section 3.5 of the Standard can be met.</p> <p>Comment: Application of Section 3.5 of the standard cannot result in an assessment of BAL – LOW.</p>	No	Bushfire can come from all directions thus the shielding provisions cannot be used.
C.	Additional requirements for Certain Class 9 Buildings.	Refer to NCC Vol. 1 – Part G5 (incorporating TAS G5P1 and TAS G5P2) and Specification 43.	NA	Not applicable. Proposed building works is not a Certain Class 9 building.

7.3.2 DIRECTOR'S DETERMINATION – BUSHFIRE HAZARDS V1.2

Table 2 – Requirements for Property Access

Column 1		Column 2		
Element		Requirement	Existing property access can satisfy	Notes
A.	Property access length is less than 30 metres, or access is not required for a fire appliance to access a firefighting water point.	There are no specified design and construction requirements.	Yes	Access is less than 30m and access is not required for a fire appliance to access a firefighting water point.
B.	Property access length is 30 metres or greater, or access is required for a fire appliance to a firefighting water point	The following design and construction requirements apply to property access:	NA	Not applicable.
		(a) All – weather construction;		
		(b) Load capacity of at least 20 tonnes, including for bridges and culverts;	NA	Not applicable.
		(c) Minimum carriageway width of 4m;	NA	Not applicable.
		(d) Minimum vertical clearance of 4m;	NA	Not applicable.
		(e) Minimum horizontal clearance of 0.5m from the edge of the carriageway;	NA	Not applicable.

		(f) Cross falls of less than 3° (1:20 or 5%);	NA	Not applicable.
		(g) Dips less than 7° (1:8 or 12.5%) entry and exit angle;	NA	Not applicable.
		(h) Curves with a minimum inner radius of 10m	NA	Not applicable.
		(i) Maximum gradient of 15° (1:3.5 or 28%) for sealed road, and 10° (1:5.5 or 18%) for unsealed roads;	NA	Not applicable.
		(j) Terminate with a turning area for fire appliances provided by one of the following: <ul style="list-style-type: none"> (i) A turning circle with a minimum outer radius of 10m (ii) A property access encircling the building; or (iii) A hammerhead “T” or “Y” turning head 4m wide and 8m long 	NA	Not applicable.
C.	Property access length is 200m or greater.	The following design and construction requirements apply to property access: <ul style="list-style-type: none"> (a) The Requirements for B above; and (b) Passing bays of 2m additional 	NA	Not applicable. Property access is less than 200m.

		carriageway width and 20m length provided every 200m		
D.	Property access length is greater than 30m, and access is provided to 3 or more properties	<p>The following design and construction requirements apply to property access:</p> <p>(a) The Requirements for B above; and</p> <p>(b) Passing bays of 2m additional carriageway width and 20m length provided every 100m</p>	NA	Property access provides access to a single property.

7.3.3 DIRECTOR'S DETERMINATION – BUSHFIRE HAZARDS V1.2

Table 3A – Requirements for Reticulated Water Supply for Firefighting

Column 1		Column 2	Existing reticulated water supply for firefighting purposes compliance	Development response
Element		Requirement		
A.	Distance between building to be protected and water supply	The following requirements apply: (a) the building area to be protected must be located within 120m of a fire hydrant;	Yes	The existing fire hydrant is located within 120m of the building area.
		(b) the distance must be measured as a hose lay, between the fire fighting point and the furthest part of the building area.	Yes	The existing fire hydrant is located within 120m from the furthest part of the building area.
B.	Design criteria for proposed fire hydrants	The following requirements apply; (a) fire hydrant system must be designed and constructed in accordance with <i>TasWater Supplement to Water Supply Code of Australia WSA 03-2011-3.1 MRWA</i> Edition V2.0 as amended from time to time; and	NA	Not applicable - no proposed fire hydrant.
		(b) fire hydrants are not installed in parking areas.	NA	Not applicable - no proposed fire hydrant.

C.	Hardstand associated with proposed fire hydrants	A hardstand area for fire appliance must be provided: (a) no more than thirty metres from the hydrant, measured as a hose lay;	NA	Not applicable - no proposed fire hydrant.
		(b) no closer than six metres from the building to be protected;	NA	Not applicable - no proposed fire hydrant.
		(c) with a minimum width of 3 metres and minimum length of six metres constructed to the same standard as the carriageway; and	NA	Not applicable - no proposed fire hydrant.
		(d) connected to the property access by a carriageway equivalent to the standard of the property access.	NA	Not applicable - no proposed fire hydrant.

7.3.4 DIRECTOR'S DETERMINATION – BUSHFIRE HAZARDS V1.2

Table 4 – Requirements for Hazard Management Area

Column 1		Column 2	Proposed HMA compliance required	Development response
Element		Requirement		
A.	New buildings on lots provided with a BAL at the time of subdivision.	A new building must: (a) be provided with a HMA no smaller than the required separation distances required for BAL – 19, except where a higher BAL was approved as part of the subdivision bushfire hazard management plan; and	Yes	A new building shall be provided with a HMA no smaller than the separation distances required for BAL – 19.
		(b) have a HMA established in accordance with a certified bushfire hazard management plan.	Yes	HMA is established in accordance with a certified bushfire hazard management plan.
B.	New buildings on lots not provided with a BAL at the time of subdivision.	A new building must: (a) be provided with a HMA no smaller than the required separation distances required for BAL – 29; and	NA	Not applicable.
		(b) Hve a HMA established in accordance with a certified bushfire hazard management plan.	NA	Not applicable.

C.	Alterations and additions to buildings.	<p>An alteration or addition to a building must:</p> <p>(a) be located on the lot so as to be provided with a HMA which:</p> <p>(i) has the separation distance required for the BAL assessed for the construction of the existing building; or</p> <p>(ii) in the case of a building without an existing BAL assessment, is no smaller than the separation distances required for BAL 29; and</p>	NA	Not applicable.
		(b) Have an HMA established in accordance with a certified bushfire hazard management plan.	NA	Not applicable.
D.	New buildings and additions and alterations to buildings classified as an accommodation building Class 1b, Class 2, or Class 3, other than communal residence for persons with a disability, a respite centre or a residential aged care facility or similar.	<p>A new building or an alteration or addition must:</p> <p>(a) be located on the lot so as to provided with HMA's no smaller than the separation distances required for BAL – 12.5; and</p>	NA	Not applicable.
		(b) have an HMA established in accordance with	NA	Not applicable.

		a certified bushfire hazard management plan.		
E.	New buildings and additions and alterations to existing buildings classified as vulnerable use as defined in the relevant planning scheme.	A new building or an alteration or addition, including change of use, for a building associated with the use, handling, generation or storage of a hazardous chemical must: (a) be located on the lot so as to be provided with a HMA no smaller than the required separation distances for the BAL determined in the certified bushfire hazard management plan; and	NA	Not applicable
		(b) have an HMA established in accordance with a certified bushfire hazard management plan.	NA	Not applicable
F.	New buildings or additions and alterations to buildings associated with the use, handling, generation or storage of a hazardous chemical or explosive.	A new building or an alteration or addition, including change of use, for a building associated with the use, handling, generation or storage of a hazardous chemical must: (a) be located on the lot so as to be provided with a HMA no smaller than the required separation distances for the BAL determined in the certified bushfire hazard management plan: and	NA	Not applicable
		(b) have a HMA established in accordance with a certified bushfire hazard management	NA	Not applicable

		plan.		
G.	Additional requirements for Certain Class 9 Buildings and associated Class 10a Buildings and decks.	Refer to NCC Vol. 1 – Part G5 (incorporating TAS G5P1 and TAS G5P2) and Specification 43.	NA	Not applicable.

CERTIFICATE OF QUALIFIED PERSON – ASSESSABLE ITEM

Section 321

Form **55**

To:

Owner /Agent

Address

Suburb/postcode

Qualified person details:

Qualified person: **JOE HEPPER**

Address: **UNIT 2, 1 LIVERPOOL STREET**

Phone No: **03 6146 0334**

HOBART

7000

Fax No:

Licence No: **BFP - 148**

Email address: **info@hed-consulting.com.au**

Qualifications and Insurance details:

Accredited to report on bushfire hazards under Part IVA of the *Fire Services Act 1979*.
About Underwriting, AHWB Pty Ltd t/as HED Consulting.

(description from Column 3 of the Director's Determination - Certificates by Qualified Persons for Assessable Items)

Speciality area of expertise:

Analysis of hazards in bushfire-prone areas

(description from Column 4 of the Director's Determination - Certificates by Qualified Persons for Assessable Items)

Details of work:

Address: **44 ALMA ROAD**

Lot No: **1**

ORFORD

7190

Certificate of title No: **186679**

The assessable item related to this certificate:

Assessment of the Bushfire Attack Level (BAL) and Bushfire Hazard Management Plan

(description of the assessable item being certified)

Assessable item includes –

- a material;
- a design
- a form of construction
- a document
- testing of a component, building system or plumbing system
- an inspection, or assessment, performed

Certificate details:

Certificate type: **Bushfire Hazard**

(description from Column 1 of Schedule 1 of the Director's Determination - Certificates by Qualified Persons for Assessable Items n)

This certificate is in relation to the above assessable item, at any stage, as part of - (tick one)

building work, plumbing work or plumbing installation or demolition work: ☒

or

a building, temporary structure or plumbing installation:

In issuing this certificate the following matters are relevant –

Documents:	Bushfire Hazard Report dated 1 September 2025, version 1.0 and Bushfire Hazard Management Plan dated 1 September 2025, version 1.0
Relevant calculations:	
References:	AS3959 – 2018 Construction of buildings in bushfire prone areas Director’s Determination – Bushfire Hazard Areas, 16 July 2024, version 1.2 Tasmanian Planning Scheme Building Regulations 2016 Bushfire Hazard Report, Proposed Subdivision, 66 Alma Road Orford, dated 30 June 2020.

Substance of Certificate: (what it is that is being certified)

Bushfire Hazard Report dated 1 September 2025, version 1.0 and Bushfire Hazard Management Plan dated 1 September 2025, version 1.0

Scope and/or Limitations

The provisions in the Bushfire Hazard Assessment Report and Bushfire Hazard Management Plan as based on present conditions at the time of inspection. Vegetation growth (natural and manmade) or any other changes on the existing property and adjacent properties have not been considered.

The assessment is based on information provided at the time of the report. If the location of the proposed development differs from the location shown in the Bushfire Hazard Assessment Report and Bushfire Hazard Management Plan, both the report and plan is void.

The Bushfire Hazard Management Plan must be implemented and maintained for the life of the development otherwise the plan is void.

I certify the matters described in this certificate.

	<i>Signed:</i>	<i>Certificate No:</i>	<i>Date:</i>
Qualified person:	JOE HEPPE	H3069	1/9/2025



H4U_02 - CLAIRE HORNER
44 ALMA ROAD, ORFORD



Site Information

Land Title Reference: CT 186679/1
Wind Classification: N2
Soil Classification: P
Climate Zone: 7
BAL Level: 12.5
Alpine Area: N/A Less than 900m AHD
Corrosion Environment: TBC
Other Hazards:
Zoning:

AREA SCHEDULE

Site Area	:	1001 m ²
Main Dwelling Area	:	37.4 m ²
Deck	:	21 m ²
Ancillary Dwelling Area	:	37.4 m ²
Deck	:	21 m ²
Total Area (37.4+37.4)	:	74.8 m²
Total Deck	:	42 m²

The owner (s) acknowledge that this set of contract plans may not reflect all of the selections made or requested. I agree that deviating color choices or update plans can be signed with construction plans before construction begins.

PLEASE NOTE: No Variations will be accepted on these plans after signature. I the owner/s accept these plans:

SIGNATURE:

DATE:



Drawing No. Description

- 01 SITE PLAN
- 02 FLOOR PLAN_ MAIN DWELLING
- 03 ROOF PLAN_ MAIN DWELLING
- 04 ELEVATIONS_ MAIN DWELLING
- 05 SECTION_ MAIN DWELLING
- 06 ELECTRICAL PLAN_ MAIN DWELLING
- 07 FLOOR PLAN_ ANCILLARY DWELLING
- 08 ROOF PLAN_ ANCILLARY DWELLING
- 09 ELEVATIONS_ ANCILLARY DWELLING
- 10 SECTION_ ANCILLARY DWELLING
- 11 ELECTRICAL PLAN_ ANCILLARY DWELLING

Drawing No. Description

- 12 3D VIEWS
- 13 DRAINAGE PLAN
- 14 BAL 12.5 NOTES
- 15 GENERAL NOTES
- 16 WET AREA SPECS

NOTE:
3D View colours/materials is indicative only and is subject to final selection

GLAZING NOTE:
All windows are Double glazed

BAL Level: 12.5

	DA PLANS	14.11.2025	RK
No.	Amendment	Date	Drawn



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177 Pulpit Rock Road, New Norfolk
Hobart TAS 7140

Designer: Ranjot Kaur
Mob. 0450 656 007
Email: ranjot@perytonhomes.com.au
Licence Number: 173530973

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CONTROL MEASURE:
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TITLE

COVER SHEET

Scale Check 40mm original size

Scale: 1 : 200

Date: 14.11.2025


Drawn by: Ranjot Kaur

Job No: H4U_02

Sheet No: 00

Project Address
44 ALMA ROAD, ORFORD

Main Dwelling-Ground FL	26.800
Main Dwelling-CL	29.200
Ancillary-Ground FL	25.700
Ancillary-CL	28.100

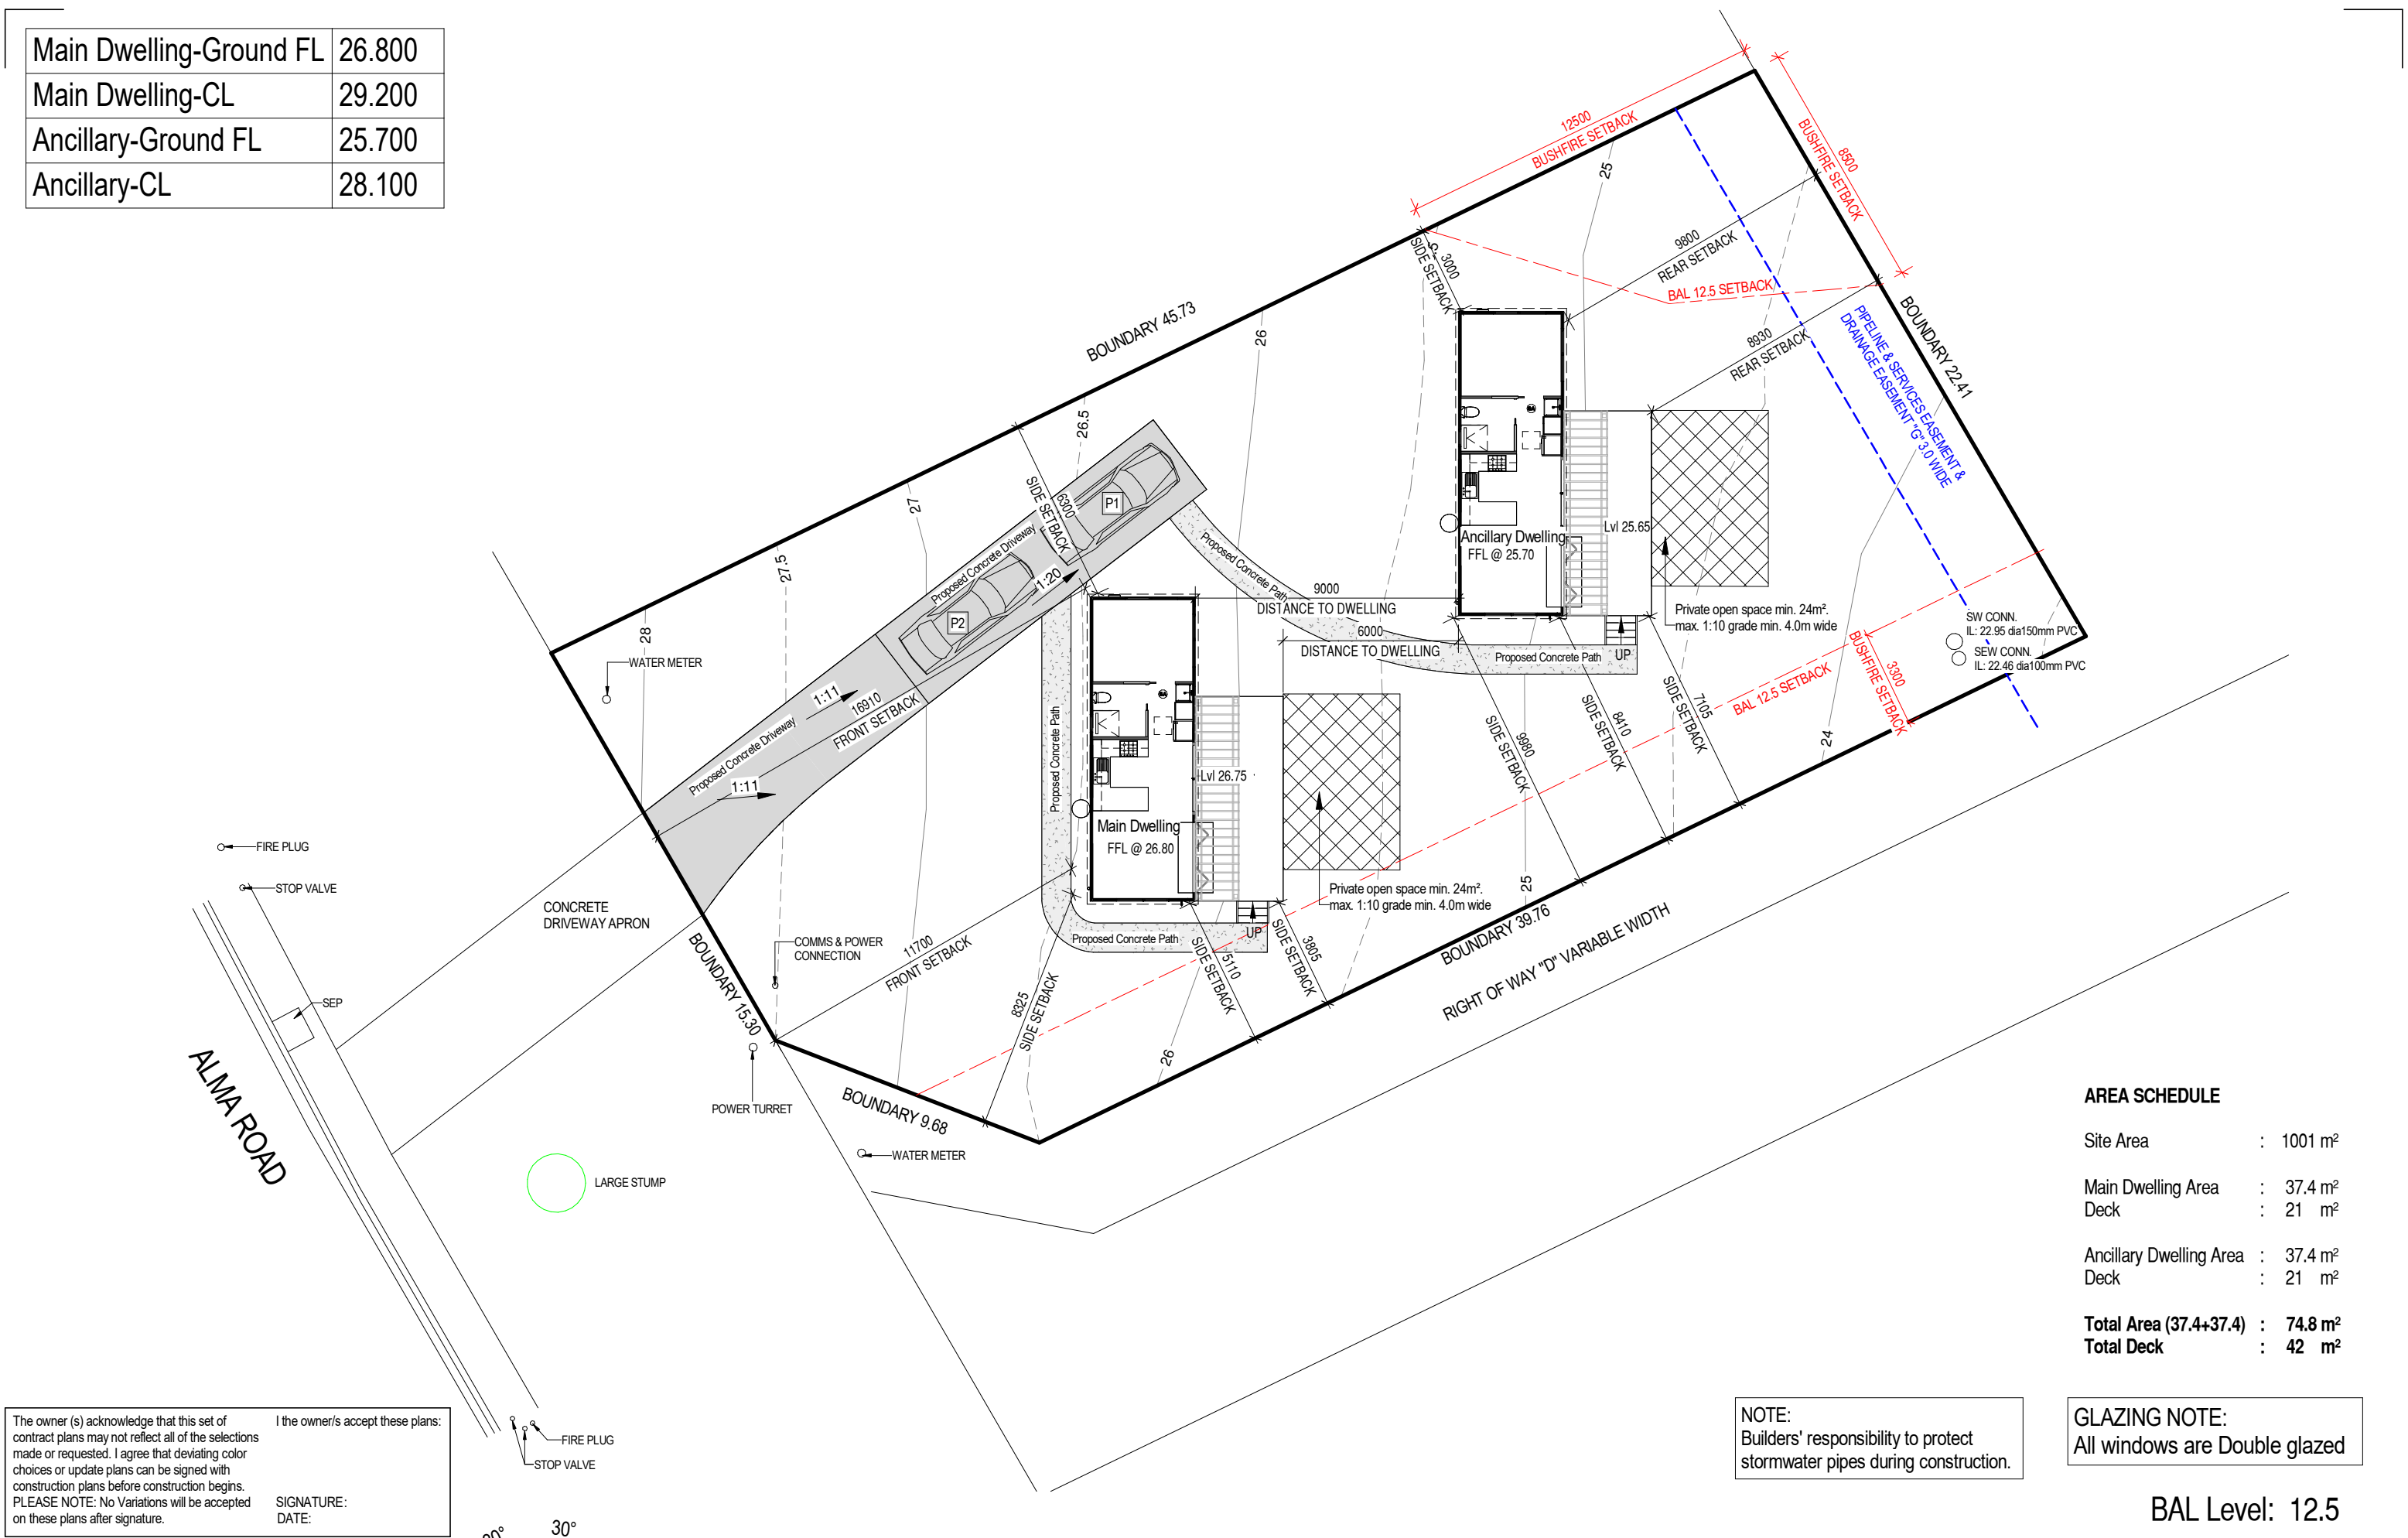

AREA SCHEDULE

Site Area	: 1001 m²
Main Dwelling Area	: 37.4 m²
Deck	: 21 m²
Ancillary Dwelling Area	: 37.4 m²
Deck	: 21 m²
Total Area (37.4+37.4)	: 74.8 m²
Total Deck	: 42 m²

NOTE:
Builders' responsibility to protect
stormwater pipes during construction.

GLAZING NOTE:
All windows are Double glazed

BAL Level: 12.5

The owner (s) acknowledge that this set of contract plans may not reflect all of the selections made or requested. I agree that deviating color choices or update plans can be signed with construction plans before construction begins. PLEASE NOTE: No Variations will be accepted on these plans after signature.

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DA PLANS

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Revision Description

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TITLE

SITE PLAN

Scale Check 40mm original size

Scale:

1 : 200

Date:

14.11.2025

Drawn by:

Ranjot Kaur

Client / Project Name

Project Address

44 ALMA ROAD, ORFORD

Job No:

H4U_02

Sheet No:


01

Main Dwelling-Ground FL	26.800
Main Dwelling-CL	29.200

AREA SCHEDULE

Site Area	:	1001 m ²
Main Dwelling Area	:	37.4 m ²
Deck	:	21 m ²
Ancillary Dwelling Area	:	37.4 m ²
Deck	:	21 m ²
Total Area (37.4+37.4)	:	74.8 m²
Total Deck	:	42 m²

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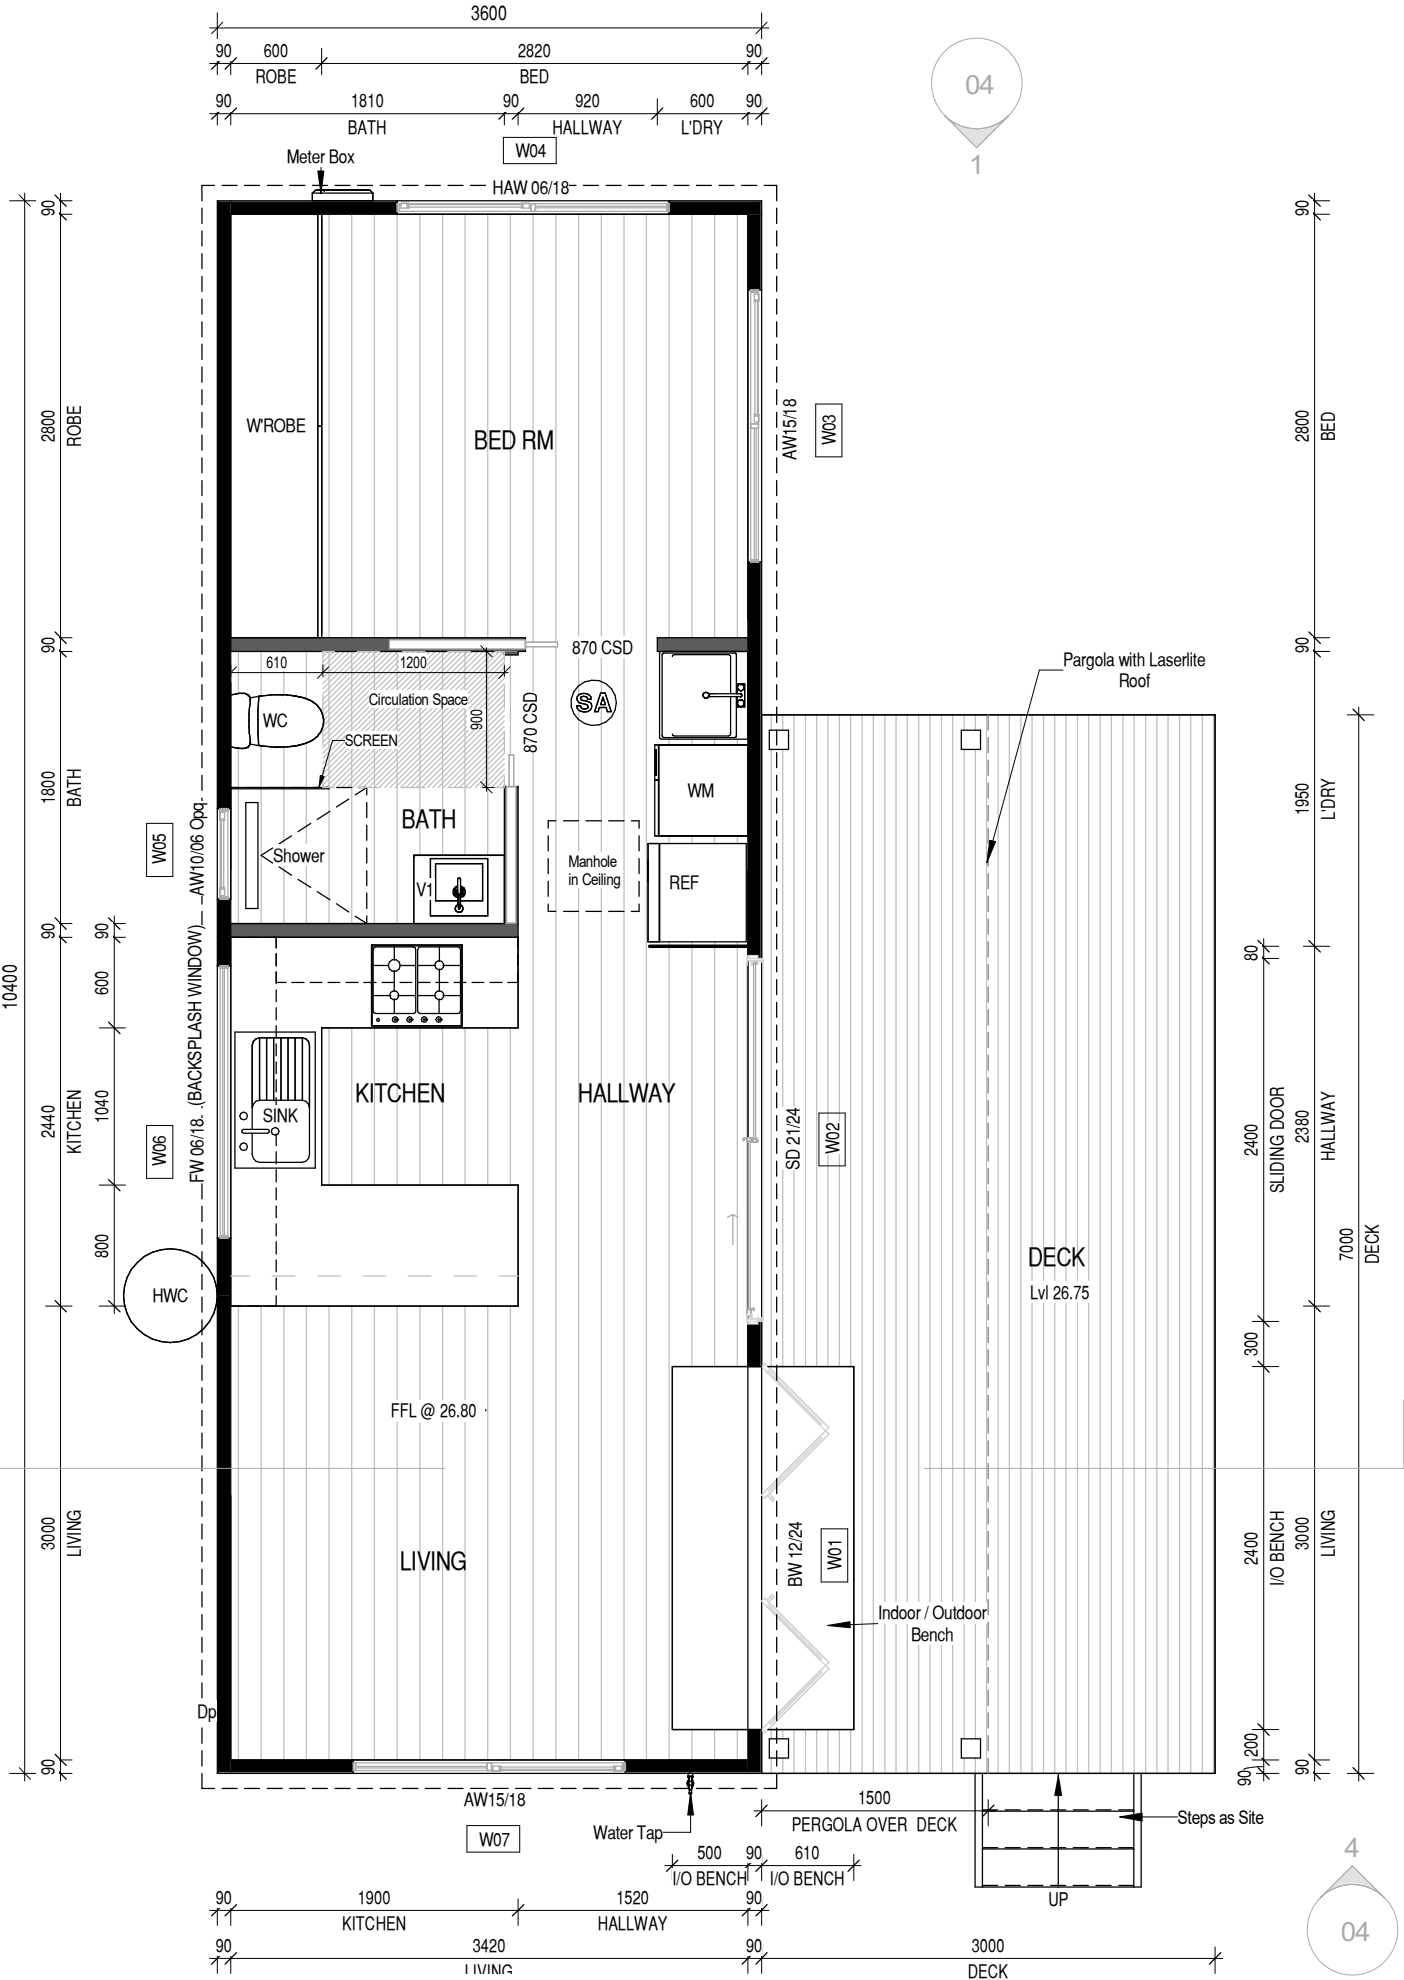
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Mob. 0450 656 007
Email: ranjot@perytonhomes.com.au
Licence Number: 173530973

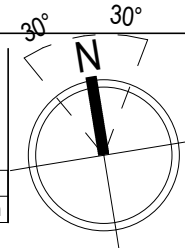

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TITLE
FLOOR PLAN MAIN DWELLING
Scale Check 40mm original size

Scale:	As indicated	Job No:	H4U_02
Date:	14.11.2025	Project Address	44 ALMA ROAD, ORFORD
Drawn by:	Ranjot Kaur	Sheet No:	02



Window Schedule

Window No.	Type	Size	Glass	Height	Width	Sill Height	Head Height
01	BW	12-24	Clear	1200	2400	900	2100
02	SD	21-24	Clear	2100	2400	0	2100
03	AW	15-18	Clear	1500	1800	600	2100
04	HAW	06-18	Clear	600	1800	1500	2100
05	AW	10-06	Opaque	1000	600	1100	2100
06	FW	06-18	Clear	600	1800	900	1500
07	AW	15-18	Clear	1500	1800	600	2100

LEGEND:

BF = Bi-Fold Window;
AW = Awning window;
FW = Fixed Window;
SD = Sliding Door;
FD = French Door;
TW = Transom Window;
SW = Sliding Window;

NOTE:

Windows supplied MUST HAVE Uw, SHGC & Air infiltration performance values EQUAL TO or BETTER THAN those specified above.
* Glass specification may change to comply with BAL requirements.
(Refer to sheet 'BAL NOTES')

Vanity Legend	
VB	450 mm
V1	600 mm
V2	750 mm
V3	900 mm
V4	1200 mm
V5	1500 mm

NOTE:
Steel Frame and Roof System


GLAZING NOTE:
All windows are Double glazed

BAL Level: 12.5

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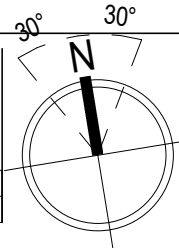


ROOF CATCHMENT AREA CALCULATION		
Ah	42 m²	Plan area of roof including 115mm Quad gutter (m²)
Ac	43.7 m²	catchment area of a roof - Ah x slope factor (m²)
Gutter Type	A	effective cross-sectional area 6500 mm² (determined from NCC Table 7.4.3b)
DRI	85	Design Rainfall intensity Hobart (determined from NCC Table 7.4.3d)
Acdp	70	Max.catchment area of roof per 90mm downpipe
Downpipes required	1	Ac / Acdp
Downpipes provided	1	
NOTE: Roof catcmnt areas to comply with AS3500.3		

GLAZING NOTE:
All windows are Double glazed

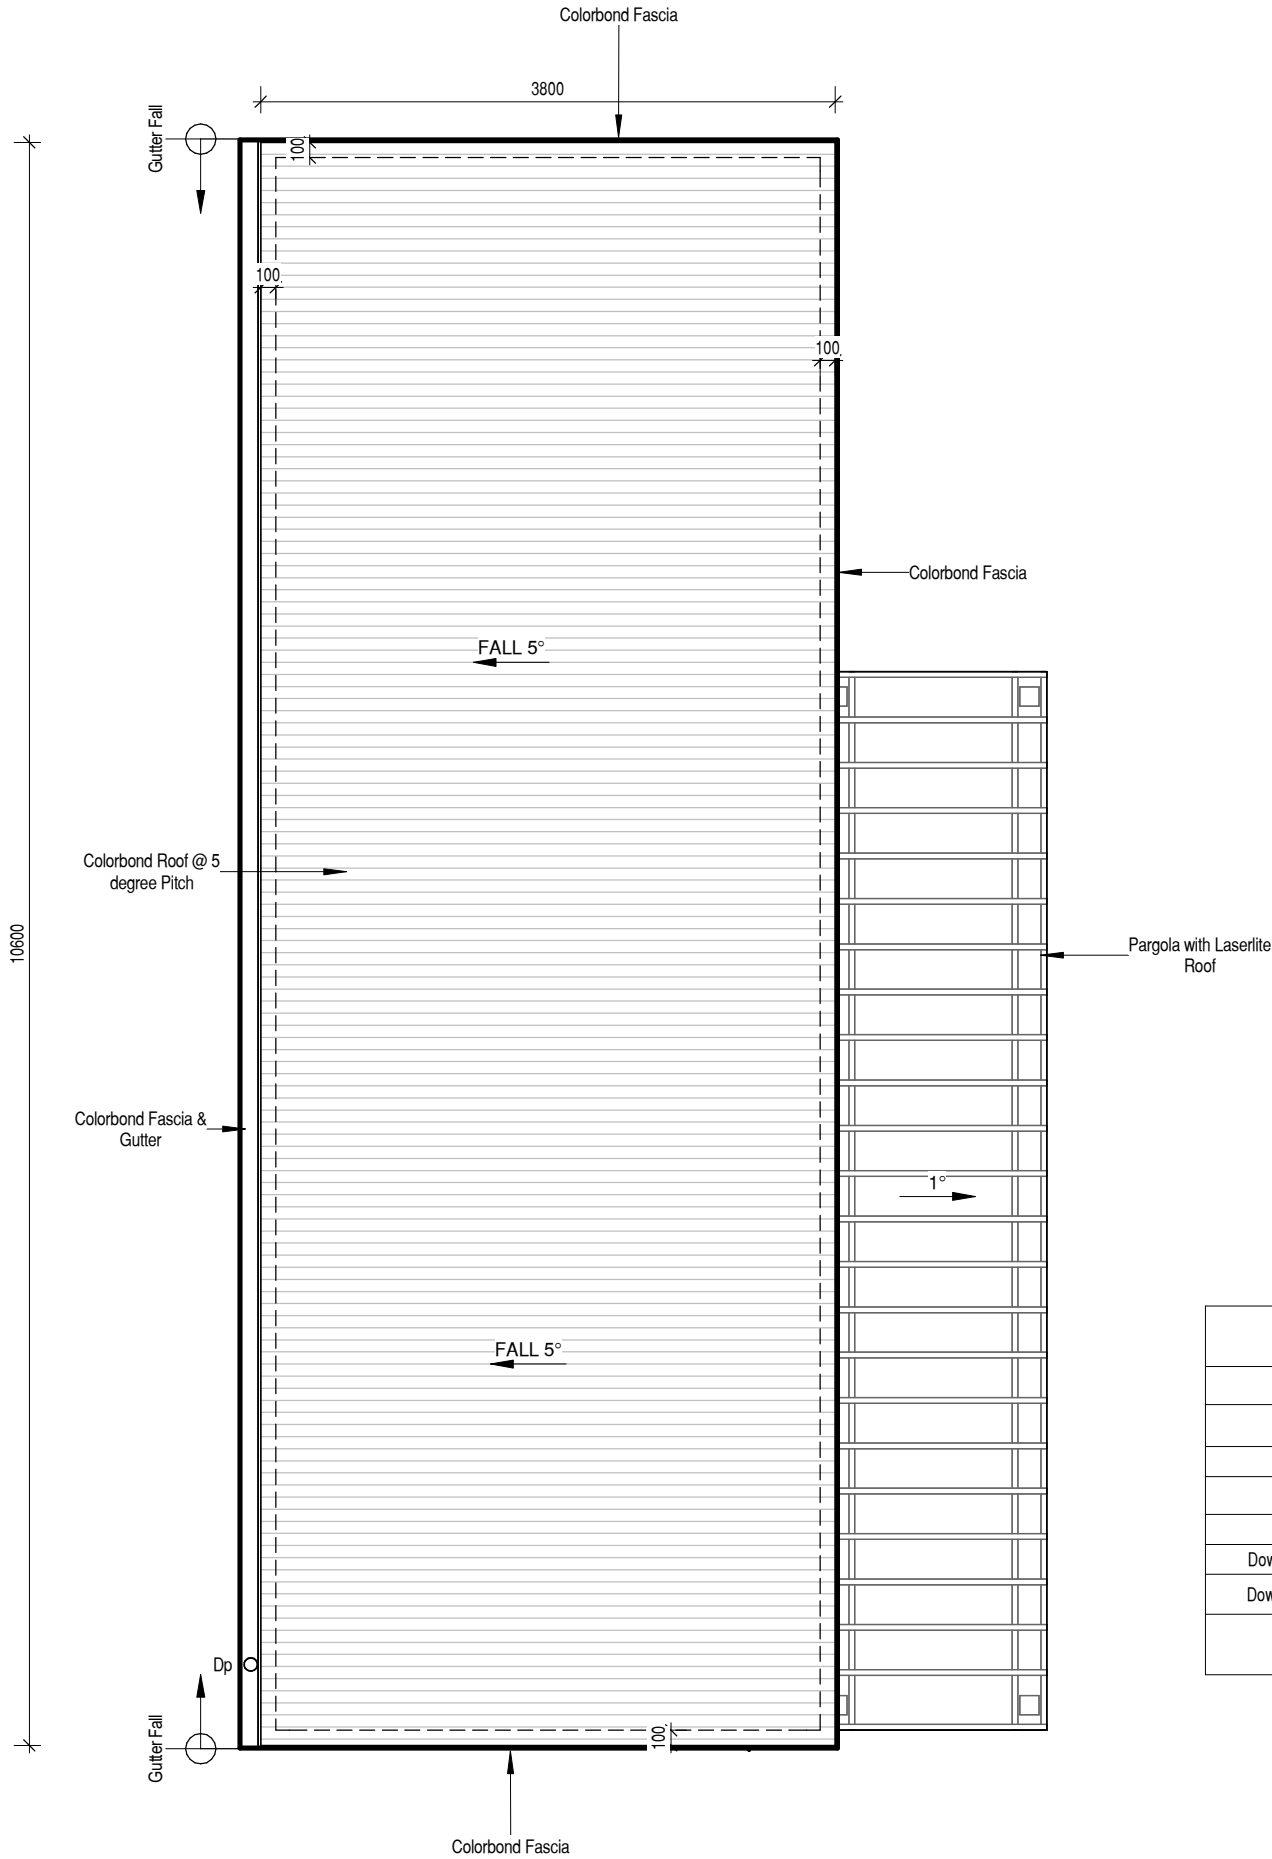BAL Level: 12.5

Rev.	DA PLANS	Revision Description	14.11.2025	RK
			Date	Drawn



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Hobart TAS 7140

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Mob. 0450 656 007
Email: ranjot@perytonhomes.com.au
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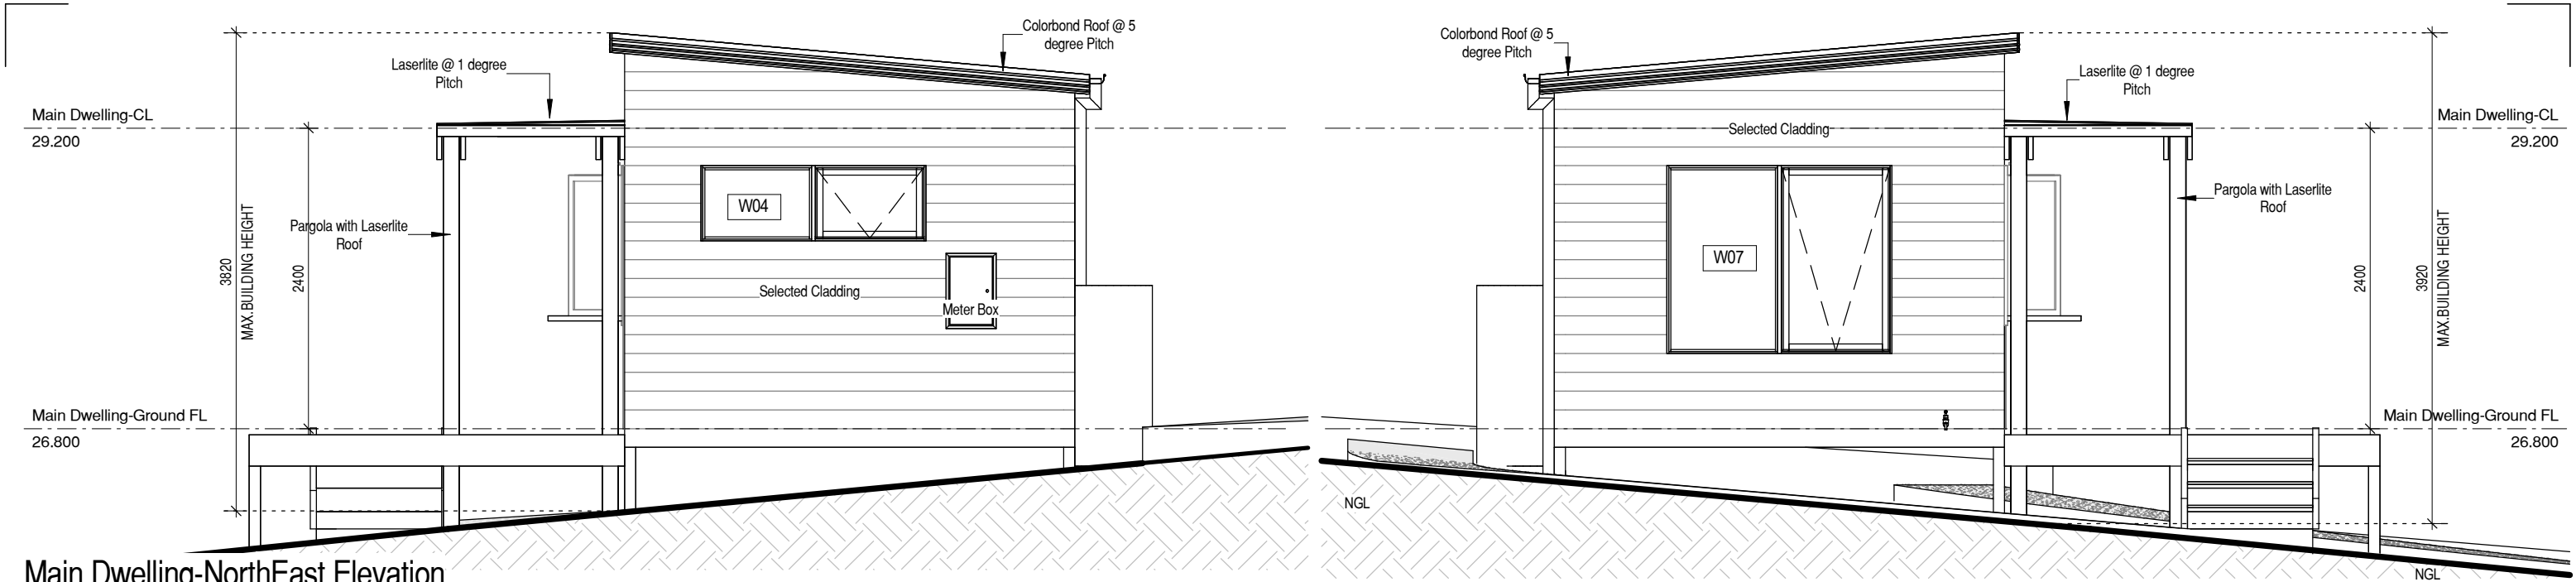


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TITLE
**ROOF PLAN_MAIN
DWELLING**


Scale Check 40mm original size

Scale:	1 : 50	Job No:	H4U_02
Date:	14.11.2025	Project Address	44 ALMA ROAD, ORFORD
Drawn by:	Ranjot Kaur	Sheet No:	03



Main Dwelling-NorthEast Elevation

Main Dwelling-SouthWest Elevation

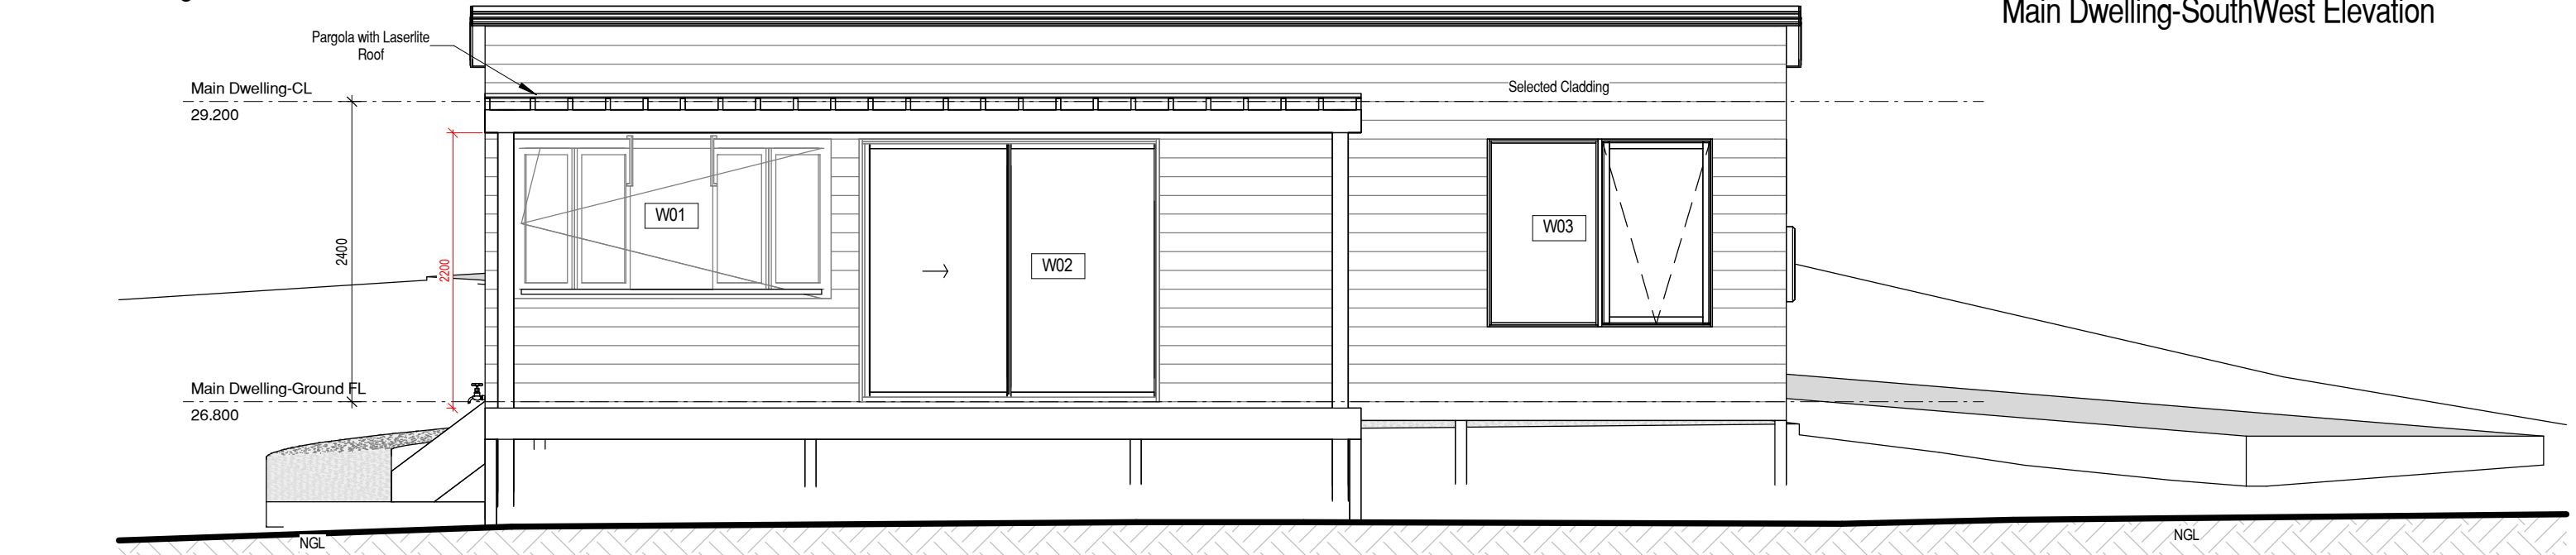

Main Dwelling-SouthEast Elevation

CLADDING / COLOUR SELECTION	
Element	Colour / Type
Roof	TBC
Brick	TBC
Cladding	TBC


NOTE:
The colours shown on this plan may not reflect the colour of the final product. If colour has been listed as TBC this means the colours is indicative only and is subject to final selection

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I the owner/s accept these plans:

SIGNATURE: _____

DATE: _____

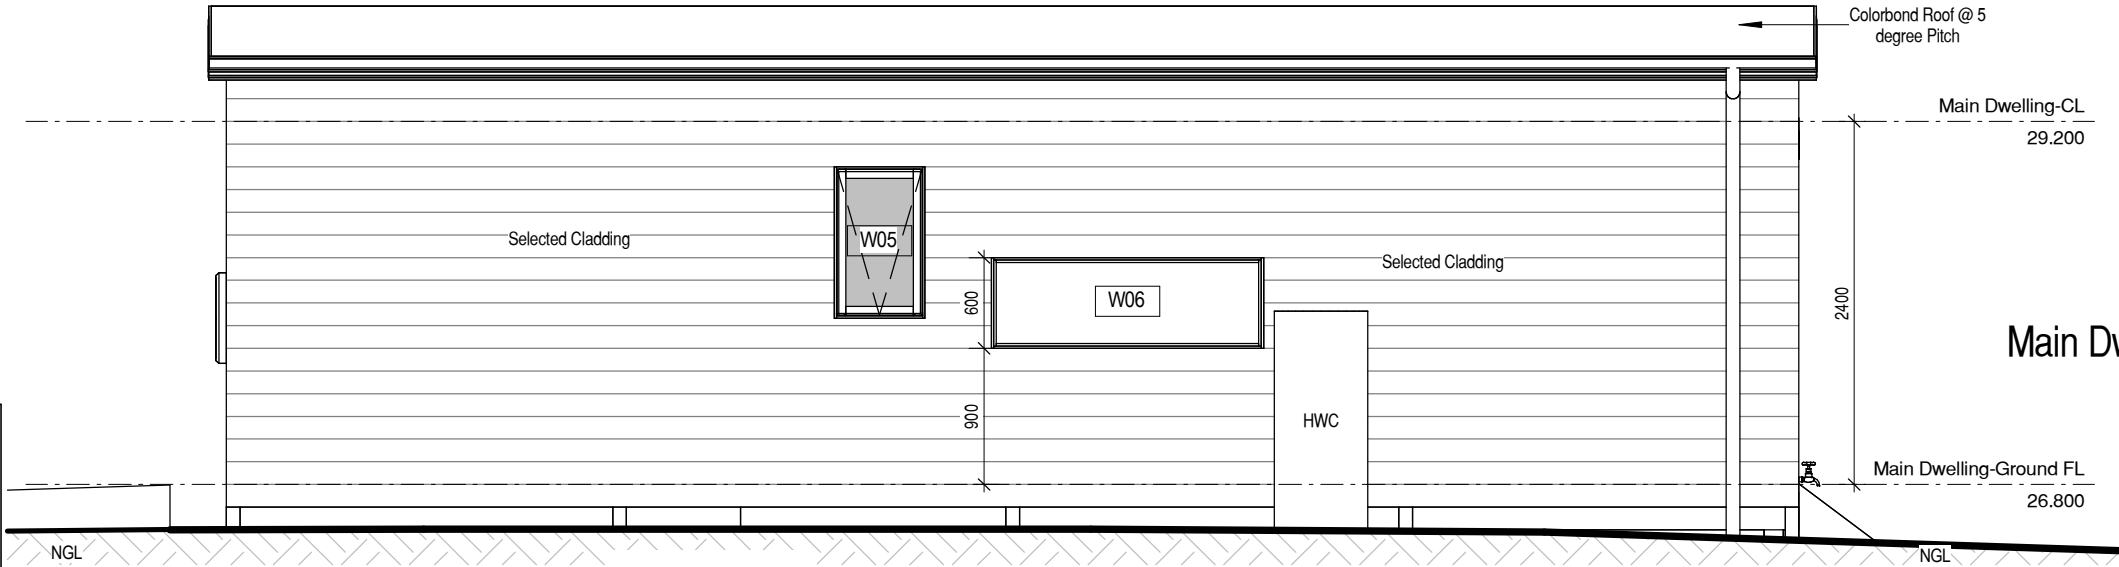

Main Dwelling-NorthWest Elevation

GLAZING NOTE:
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BAL Level: 12.5

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TITLE

ELEVATIONS_MAIN DWELLING

Scale Check 40mm original size

Scale: 1 : 50

Date: 14.11.2025

Drawn by: Ranjot Kaur


Client / Project Name

Project Address

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Job No: **H4U_02**

Sheet No: **04**

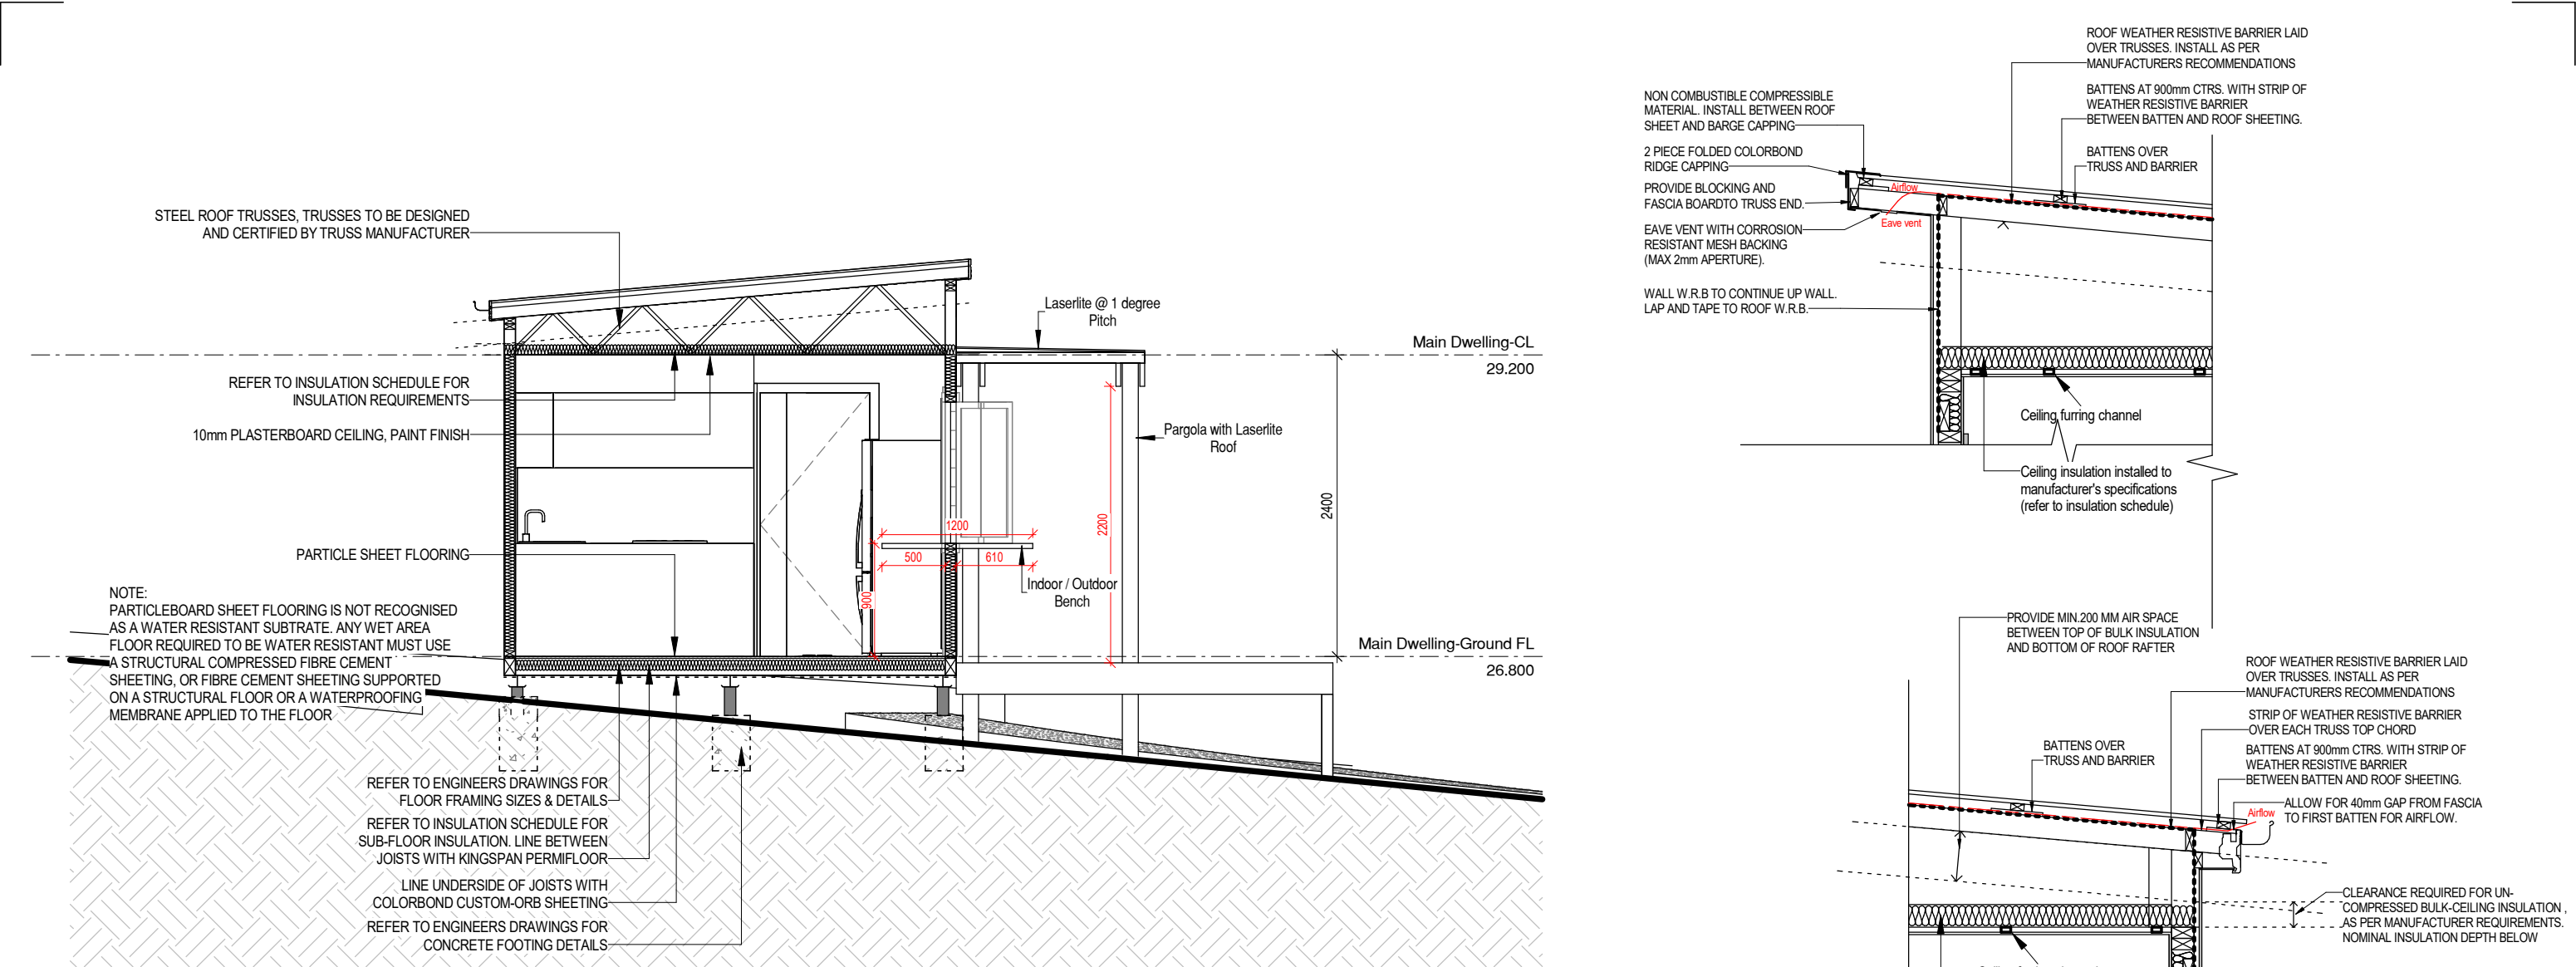

Main Dwelling-Section 1

Scale 1:50

GLAZING NOTE:
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
Rev.	DA PLANS	14.11.2025	RK
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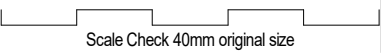
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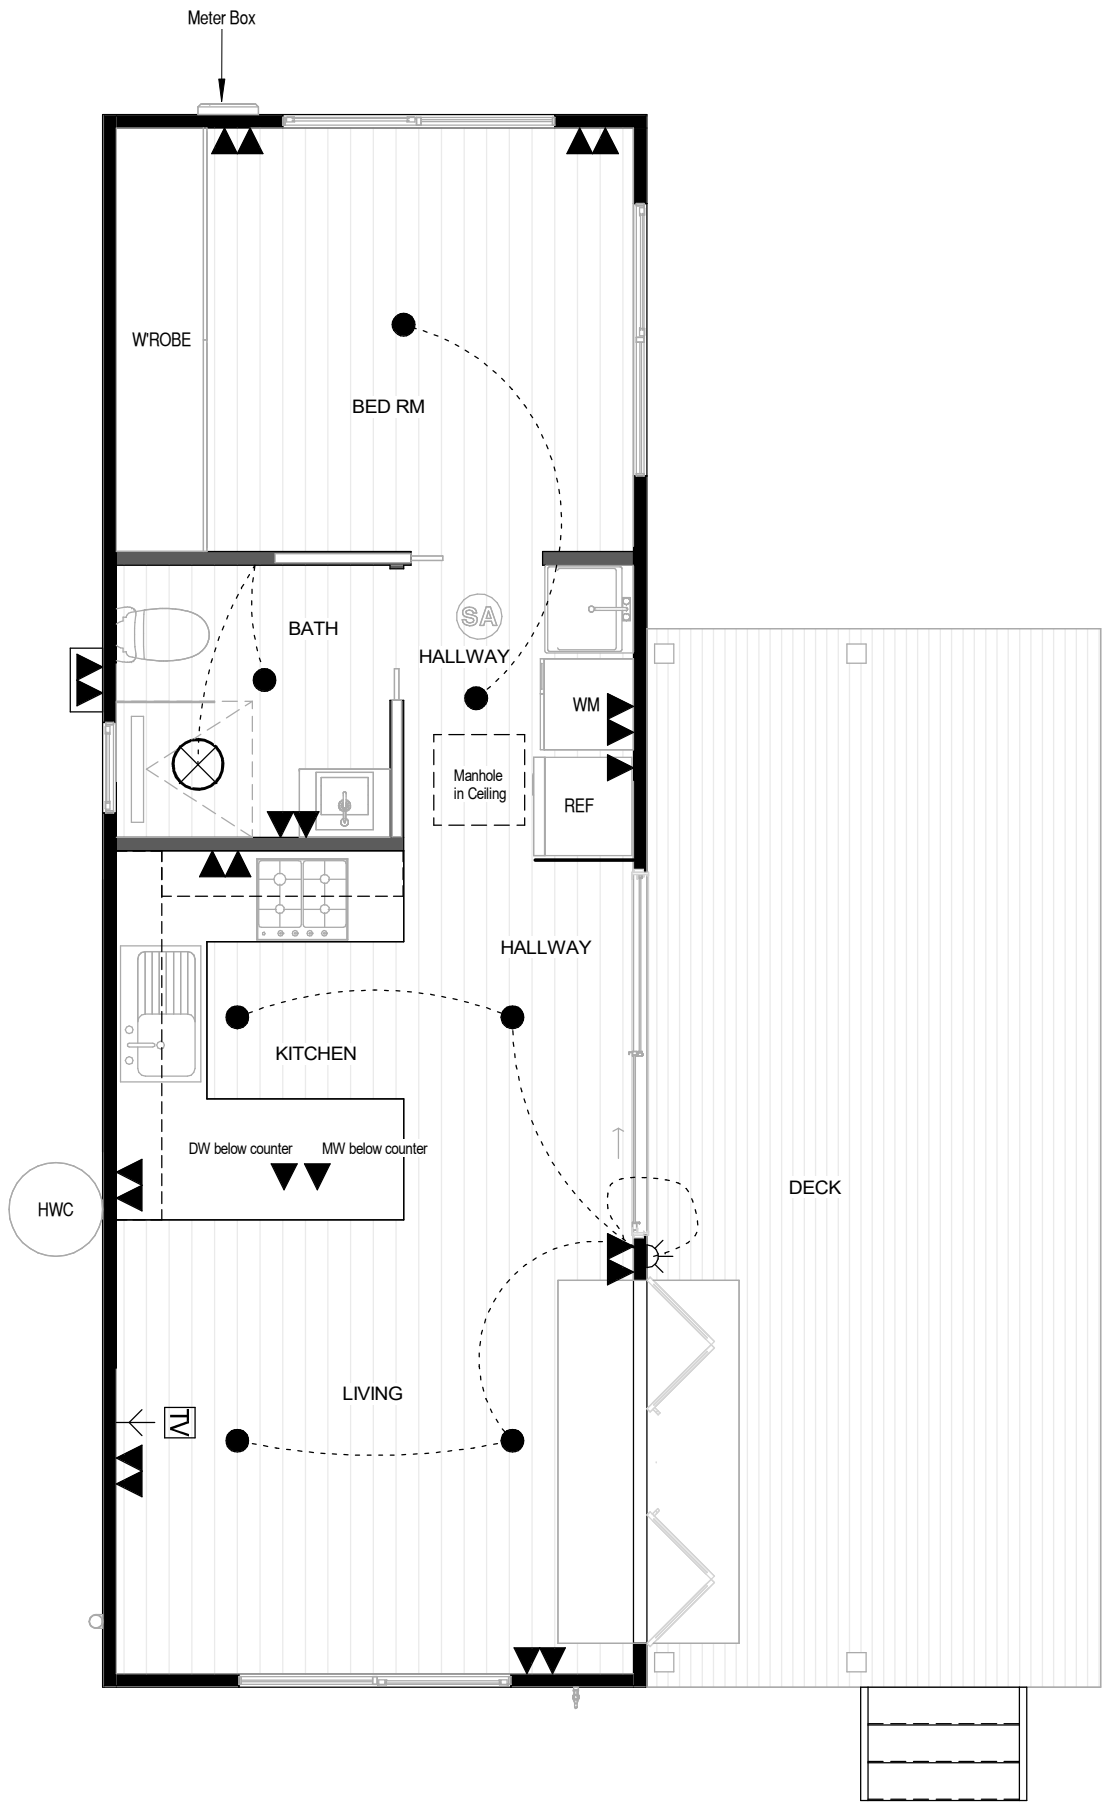
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TITLE

SECTION_MAIN DWELLING



Scale:	As indicated	Job No:	H4U_02
Date:	14.11.2025	Project Address	44 ALMA ROAD, ORFORD
Drawn by:	Ranjot Kaur	Sheet No:	05



ELECTRICAL LEGEND		
		No.s
	Single GPOs	3
	Double GPOs	9
	LED Downlight	7
	Mechanical Exhaust Fan	1
	Smoke Alarm	1
	TV Point	1
	Power Point Weatherproof	1
	Wall Light	1

NOTES:
- Rangehood to be ducted to outside
- External NBN under meterbox [where applicable]
- Where Exhaust fans are provided with no other form of ventilation, fan must be activated simultaneously with light
- Smoke alarm to be connected to the mains power supply and possess a battery back-up and be interconnected; to provide a common alarm throughout the building, and be to AS 3786-2014, and installed to NCC Clause 3.7.5.5.

GLAZING NOTE:
All windows are Double glazed

BAL Level: 12.5

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DA PLANS			
Rev.	Revision Description	Date	Drawn
		14.11.2025	RK



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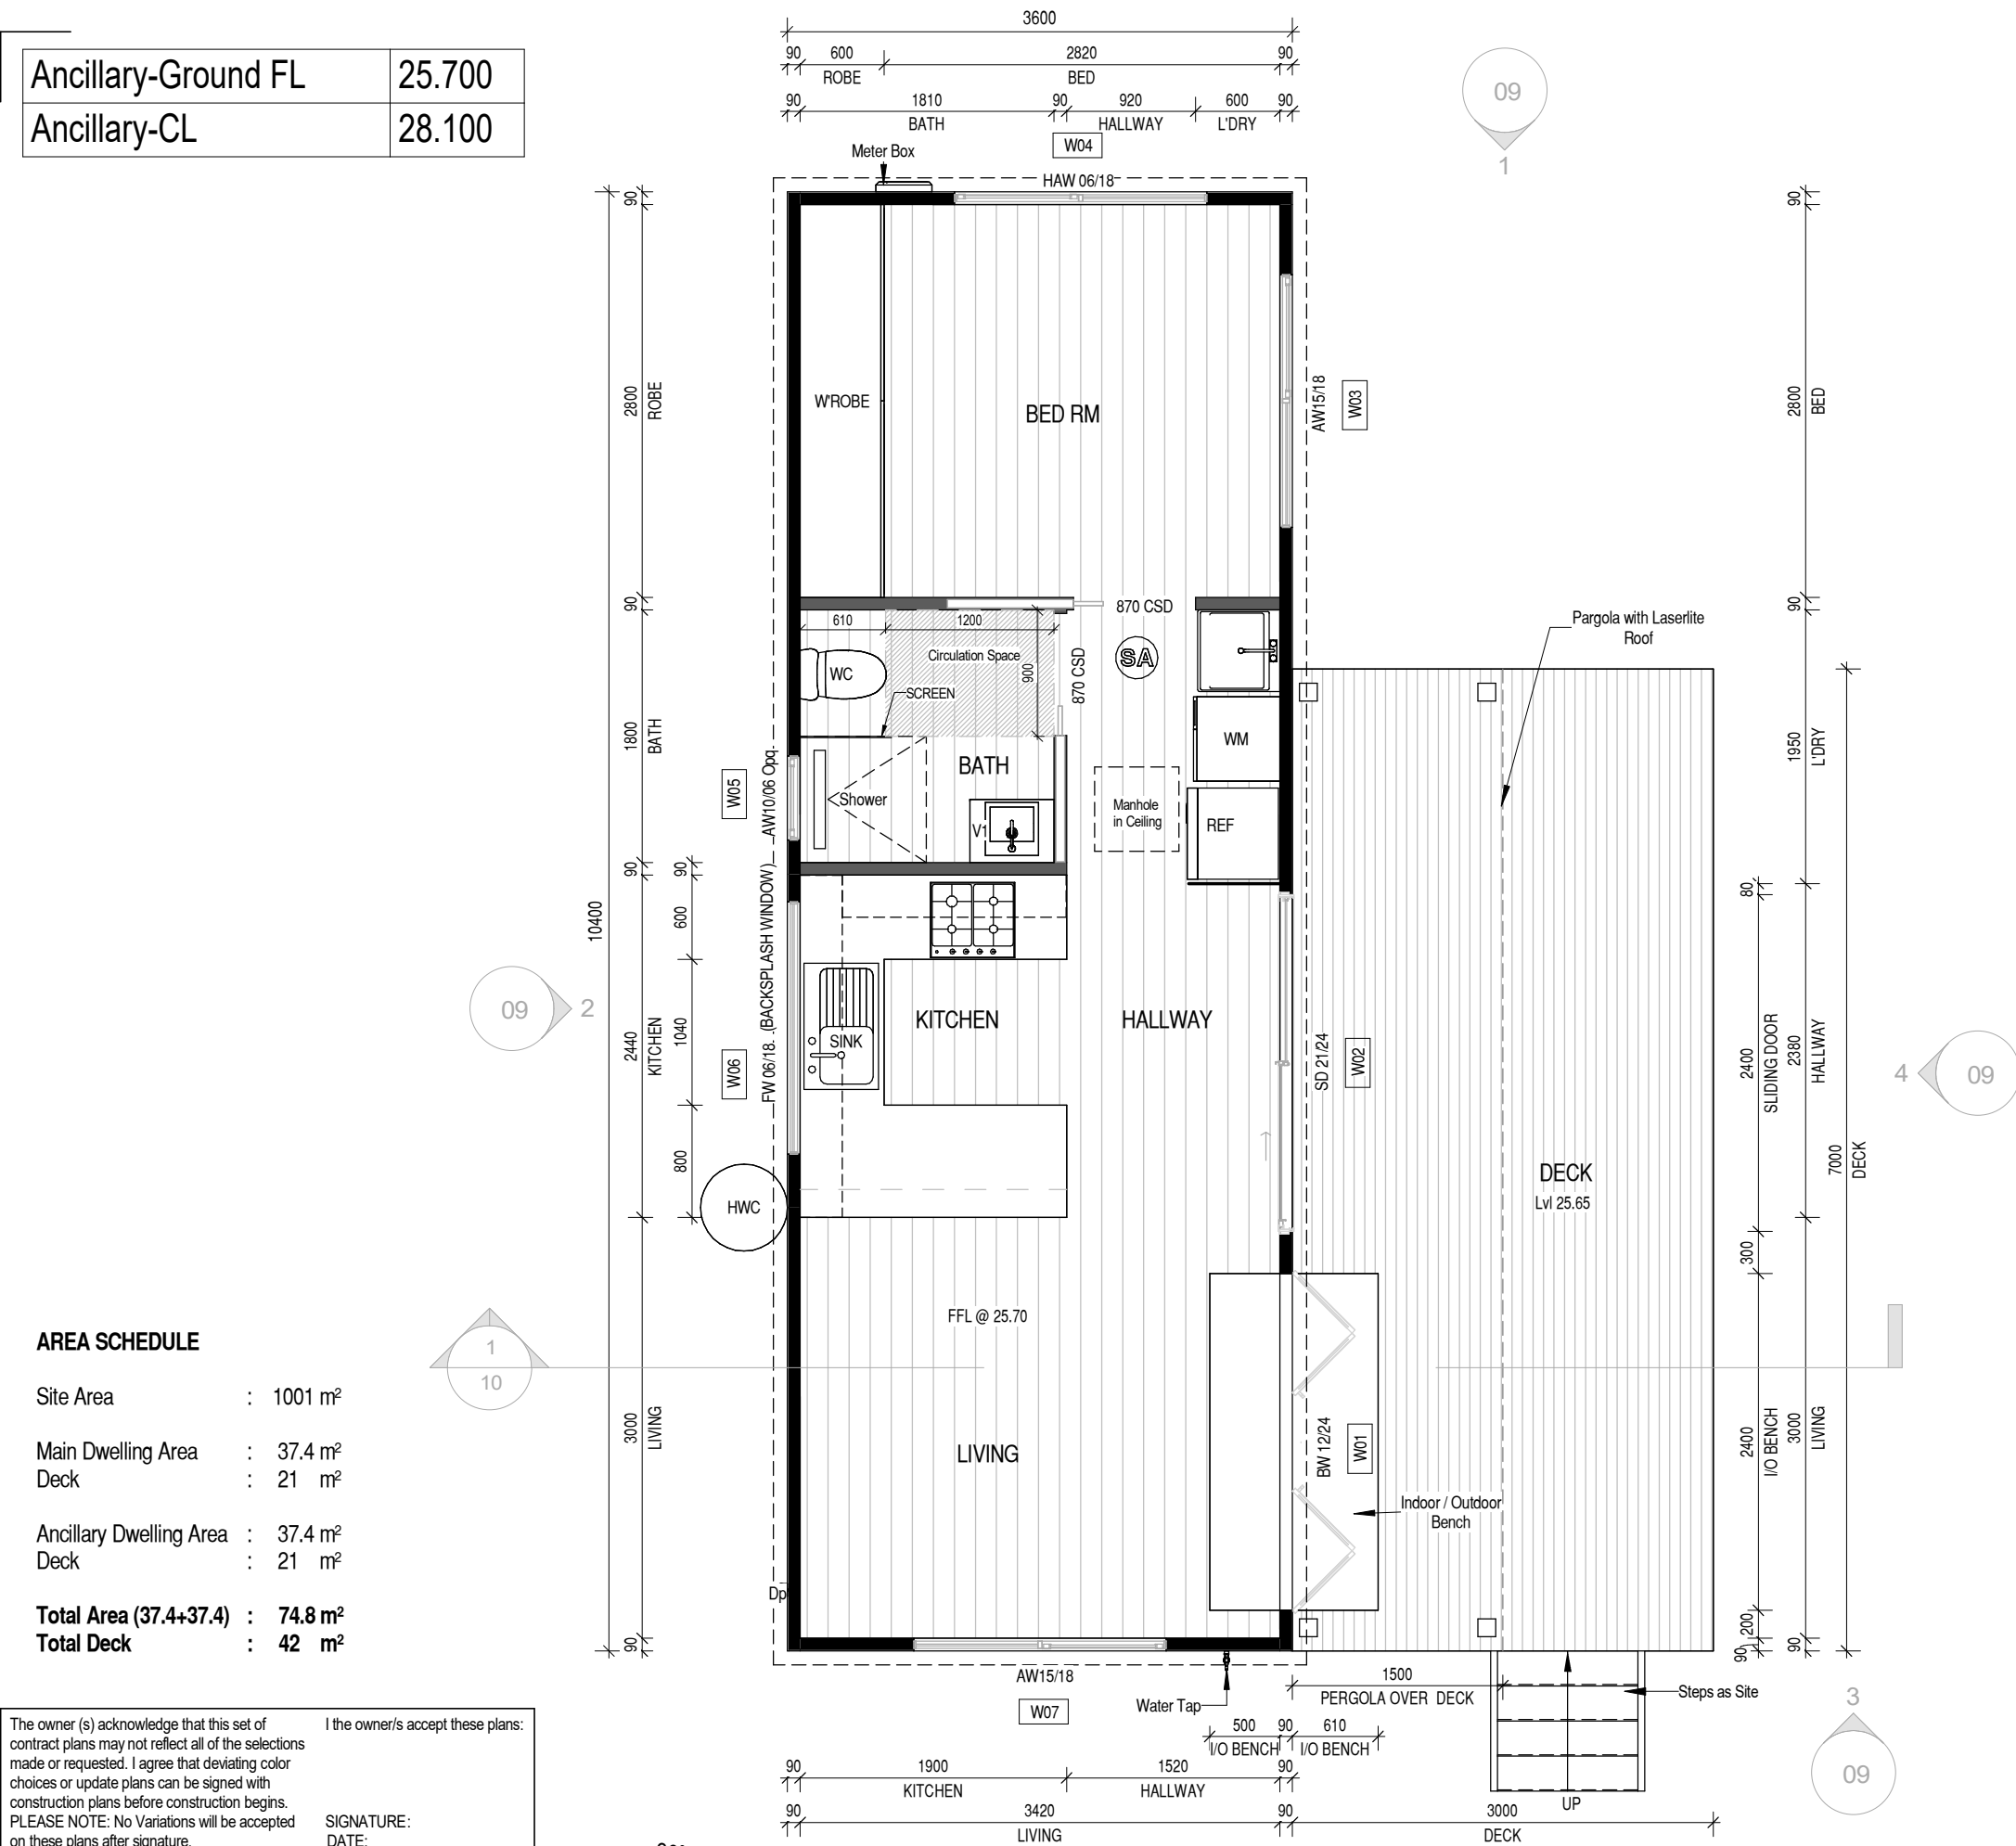
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TITLE
ELECTRICAL PLAN_ MAIN DWELLING

Scale Check 40mm original size

Scale:	As indicated	Client / Project Name	Job No: H4U_02
Date:	14.11.2025	Project Address 44 ALMA ROAD, ORFORD	Sheet No: 06
Drawn by:	Ranjot Kaur		

Ancillary-Ground FL	25.700
Ancillary-CL	28.100



Window Schedule							
Window No.	Type	Size	Glass	Height	Width	Sill Height	Head Height
01	BW	12-24	Clear	1200	2400	900	2100
02	SD	21-24	Clear	2100	2400	0	2100
03	AW	15-18	Clear	1500	1800	600	2100
04	HAW	06-18	Clear	600	1800	1500	2100
05	AW	10-06	Opaque	1000	600	1100	2100
06	FW	06-18	Clear	600	1800	900	1500
07	AW	15-18	Clear	1500	1800	600	2100

LEGEND:
BW = Bi-Fold Window;
AW = Awning window;
FW = Fixed Window;
SD = Sliding Door,
FD = French Door;
TW = Transom Window
SW = Sliding Window;

NOTE:

Windows supplied MUST HAVE Uw, SHGC & Air infiltration performance values EQUAL TO or BETTER THAN those specified above.
* Glass specification may change to comply with BAL requirements.
(Refer to sheet 'BAL NOTES')


Vanity Legend	
VB	450 mm
V1	600 mm
V2	750 mm
V3	900 mm
V4	1200 mm
V5	1500 mm

NOTE:
Steel Frame and Roof System

GLAZING NOTE:
All windows are Double glazed

BAL Level: 12.5

	DA PLANS	14.11.2025	RK
Rev.	Revision Description	Date	Drawn

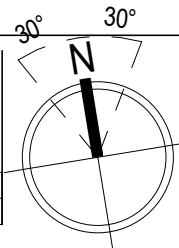

PERYTON HOMES Pty Ltd
177 Pulpit Rock Road, New Norfolk
Hobart TAS 7140

Designer: Ranjot Kaur
Mob. 0450 656 007
Email: ranjot@perytonhomes.com.au
Licence Number: 173530973



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TITLE
FLOOR PLAN Ancillary
Dwelling

Scale Check 40mm original size


Scale:	As indicated	Client / Project Name	Job No: H4U_02
Date:	14.11.2025	Project Address 44 ALMA ROAD, ORFORD	Sheet No: 07
Drawn by:	Ranjot Kaur		

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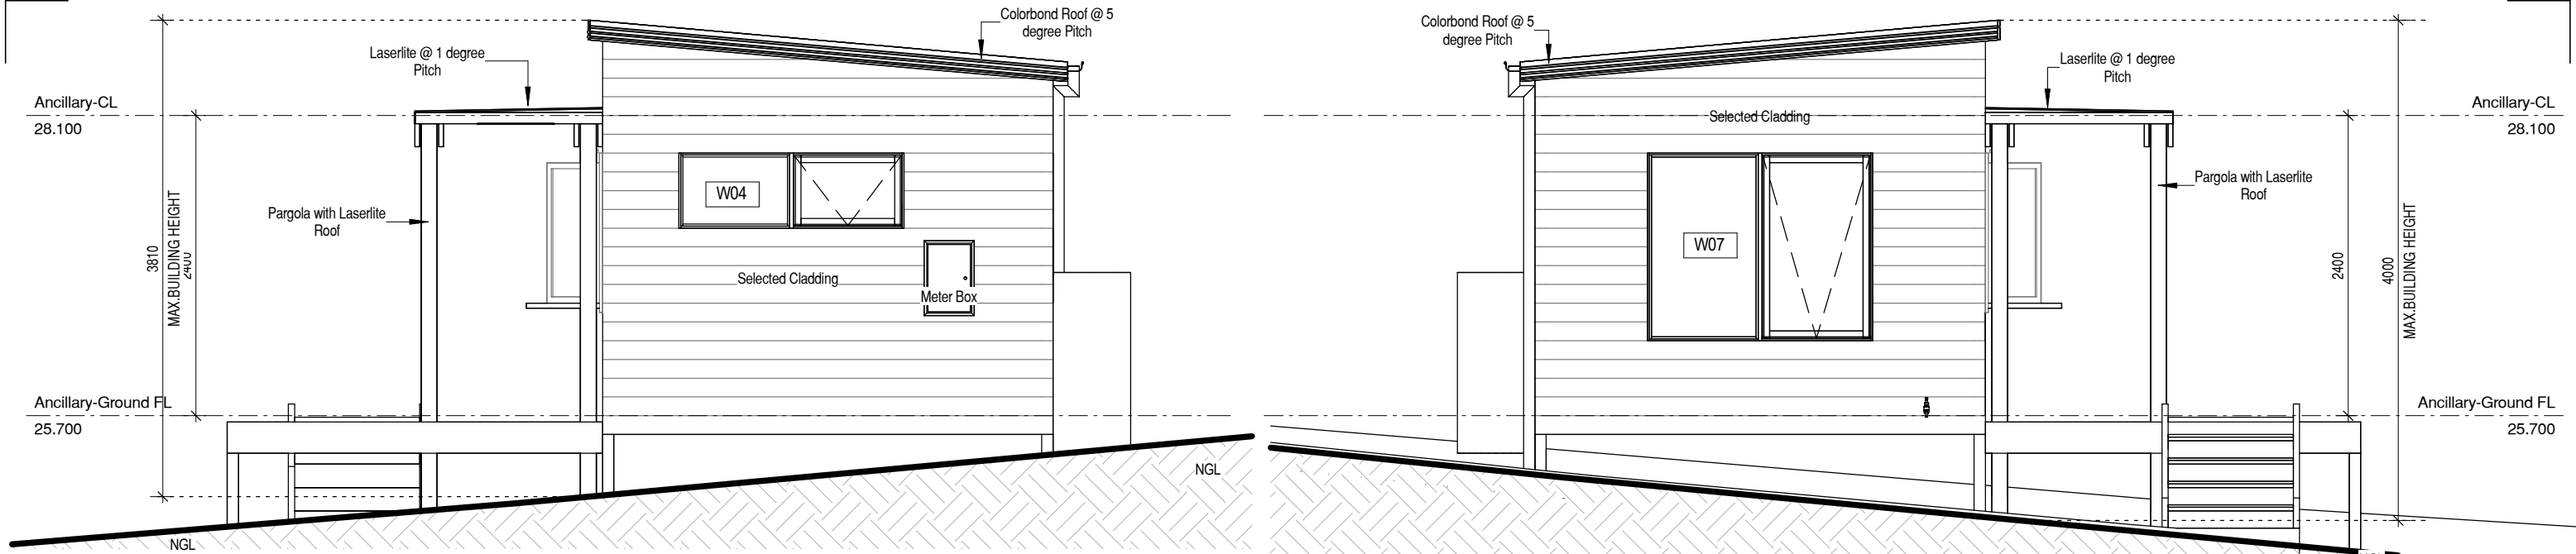
DATE: _____



ROOF CATCHMENT AREA CALCULATION		
Ah	42 m²	Plan area of roof including 115mm Quad gutter (m²)
Ac	43.7 m²	catchment area of a roof - Ah x slope factor (m²)
Gutter Type	A	effective cross-sectional area 6500 mm² (determined from NCC Table 7.4.3b)
DRI	85	Design Rainfall intensity Hobart (determined from NCC Table 7.4.3d)
Acdp	70	Max.catchment area of roof per 90mm downpipe
Downpipes required	1	Ac / Acdp
Downpipes provided	1	
NOTE: Roof catcmnt areas to comply with AS3500.3		

GLAZING NOTE:
All windows are Double glazed

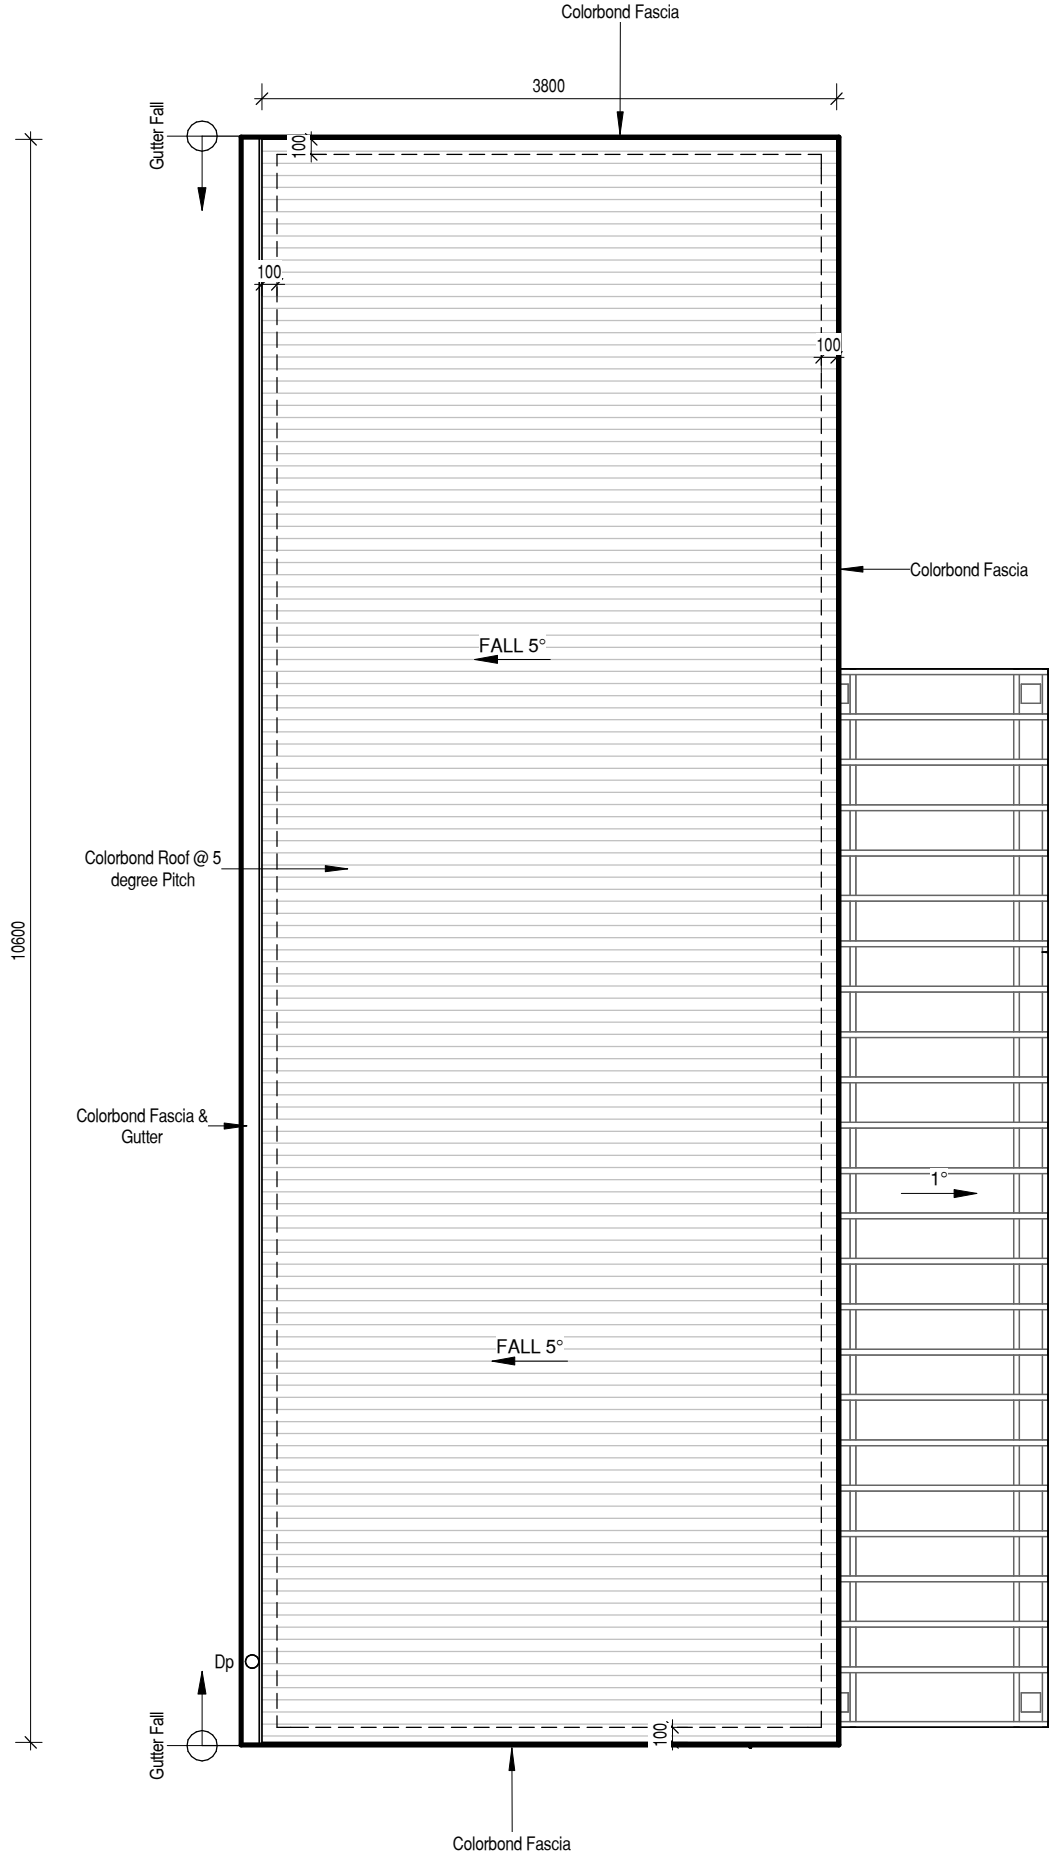BAL Level: 12.5




Ancillary Dwelling-NorthEast Elevation

Ancillary Dwelling-SouthWest Elevation



Ancillary Dwelling-SouthEast Elevation

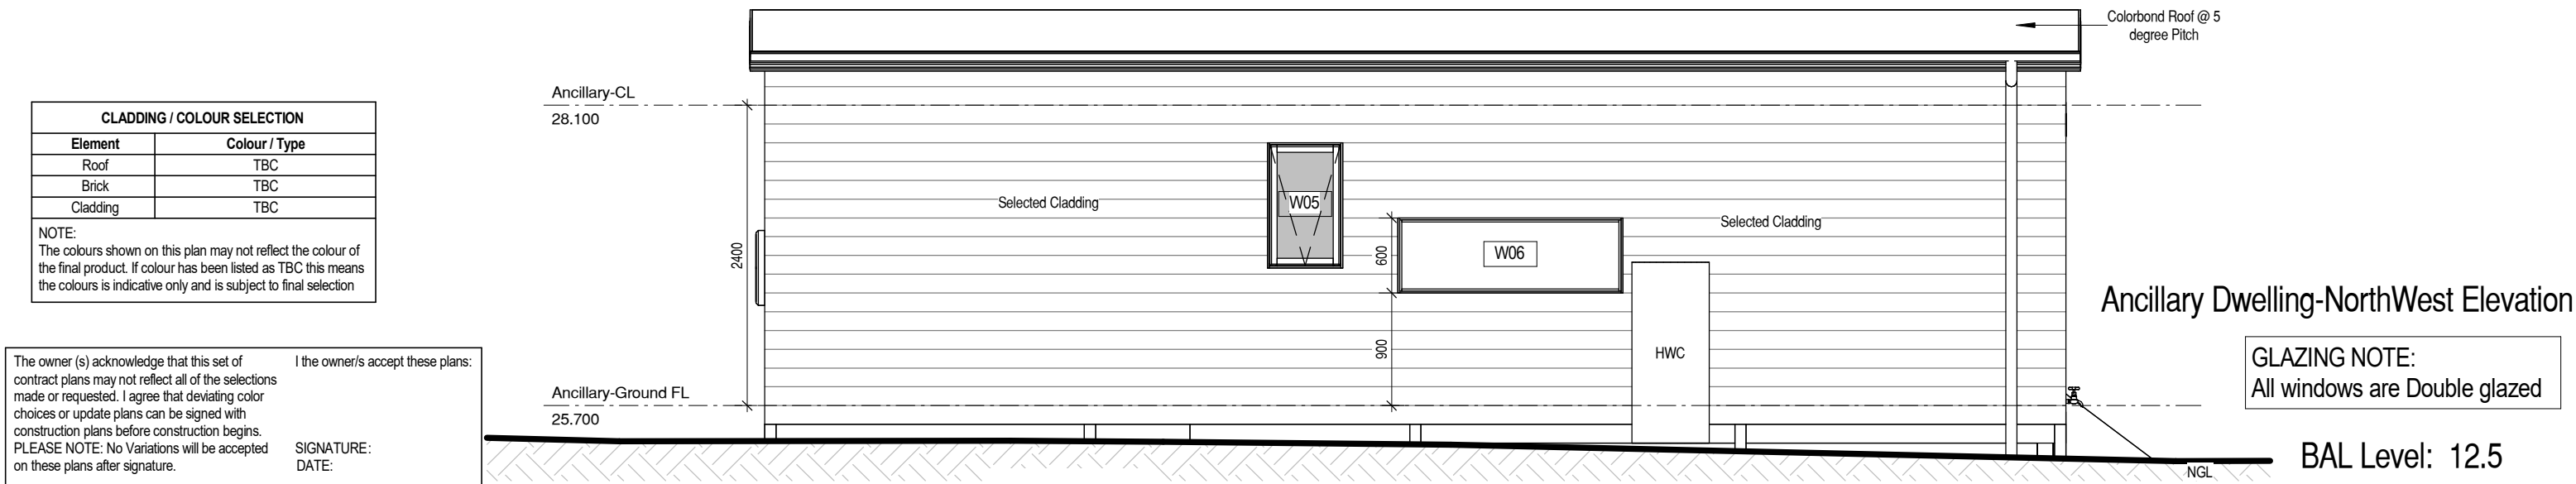

Ancillary Dwelling-NorthWest Elevation

CLADDING / COLOUR SELECTION	
Element	Colour / Type
Roof	TBC
Brick	TBC
Cladding	TBC

NOTE:
The colours shown on this plan may not reflect the colour of the final product. If colour has been listed as TBC this means the colours is indicative only and is subject to final selection

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GLAZING NOTE:
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BAL Level: 12.5

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	Revision Description	Date	Drawn




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Hobart TAS 7140

Designer: Ranjot Kaur
Mob. 0450 656 007
Email: ranjot@perytonhomes.com.au
Licence Number: 173530973




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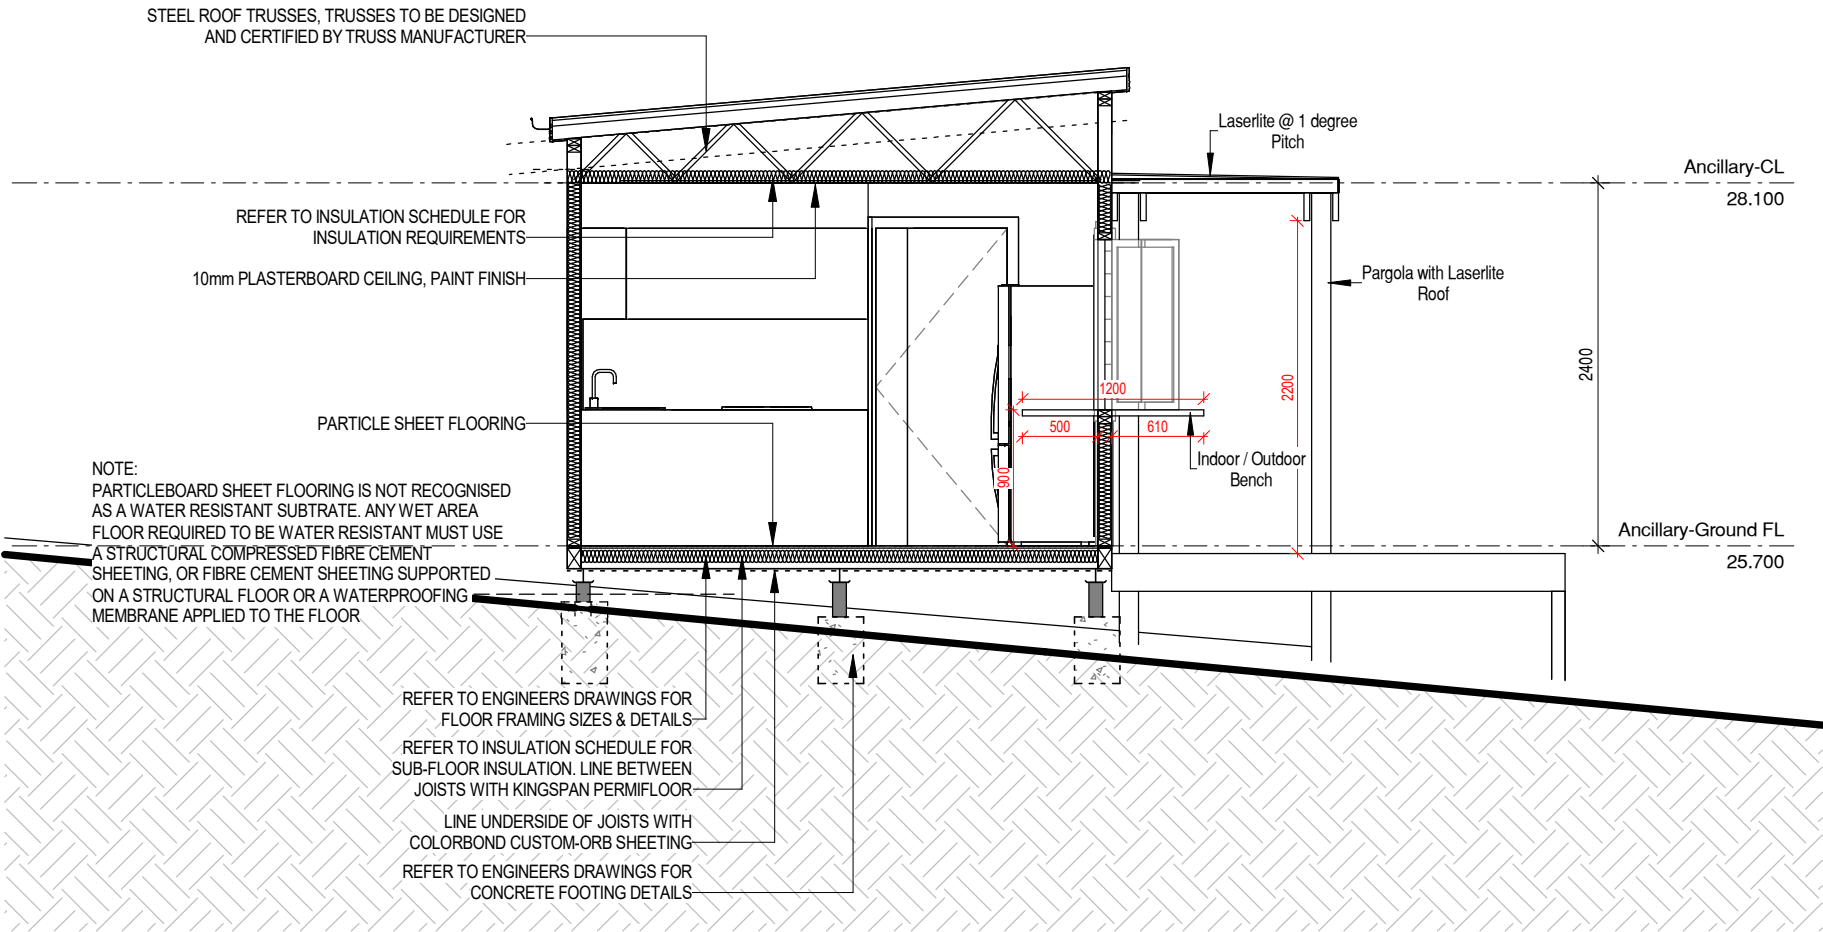
TITLE

ELEVATIONS_ ANCILLARY DWELLING



Scale Check 40mm original size

Scale:	1 : 50	Job No:	H4U_02
Date:	14.11.2025	Project Address	44 ALMA ROAD, ORFORD
Drawn by:	Ranjot Kaur	Sheet No:	09



Ancillary Dwelling-Section 2


Scale 1:50

GLAZING NOTE:
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Section Detail

Scale 1:25

BAL Level: 12.5

DA PLANS	14.11.2025	RK
Rev.	Revision Description	Date Drawn

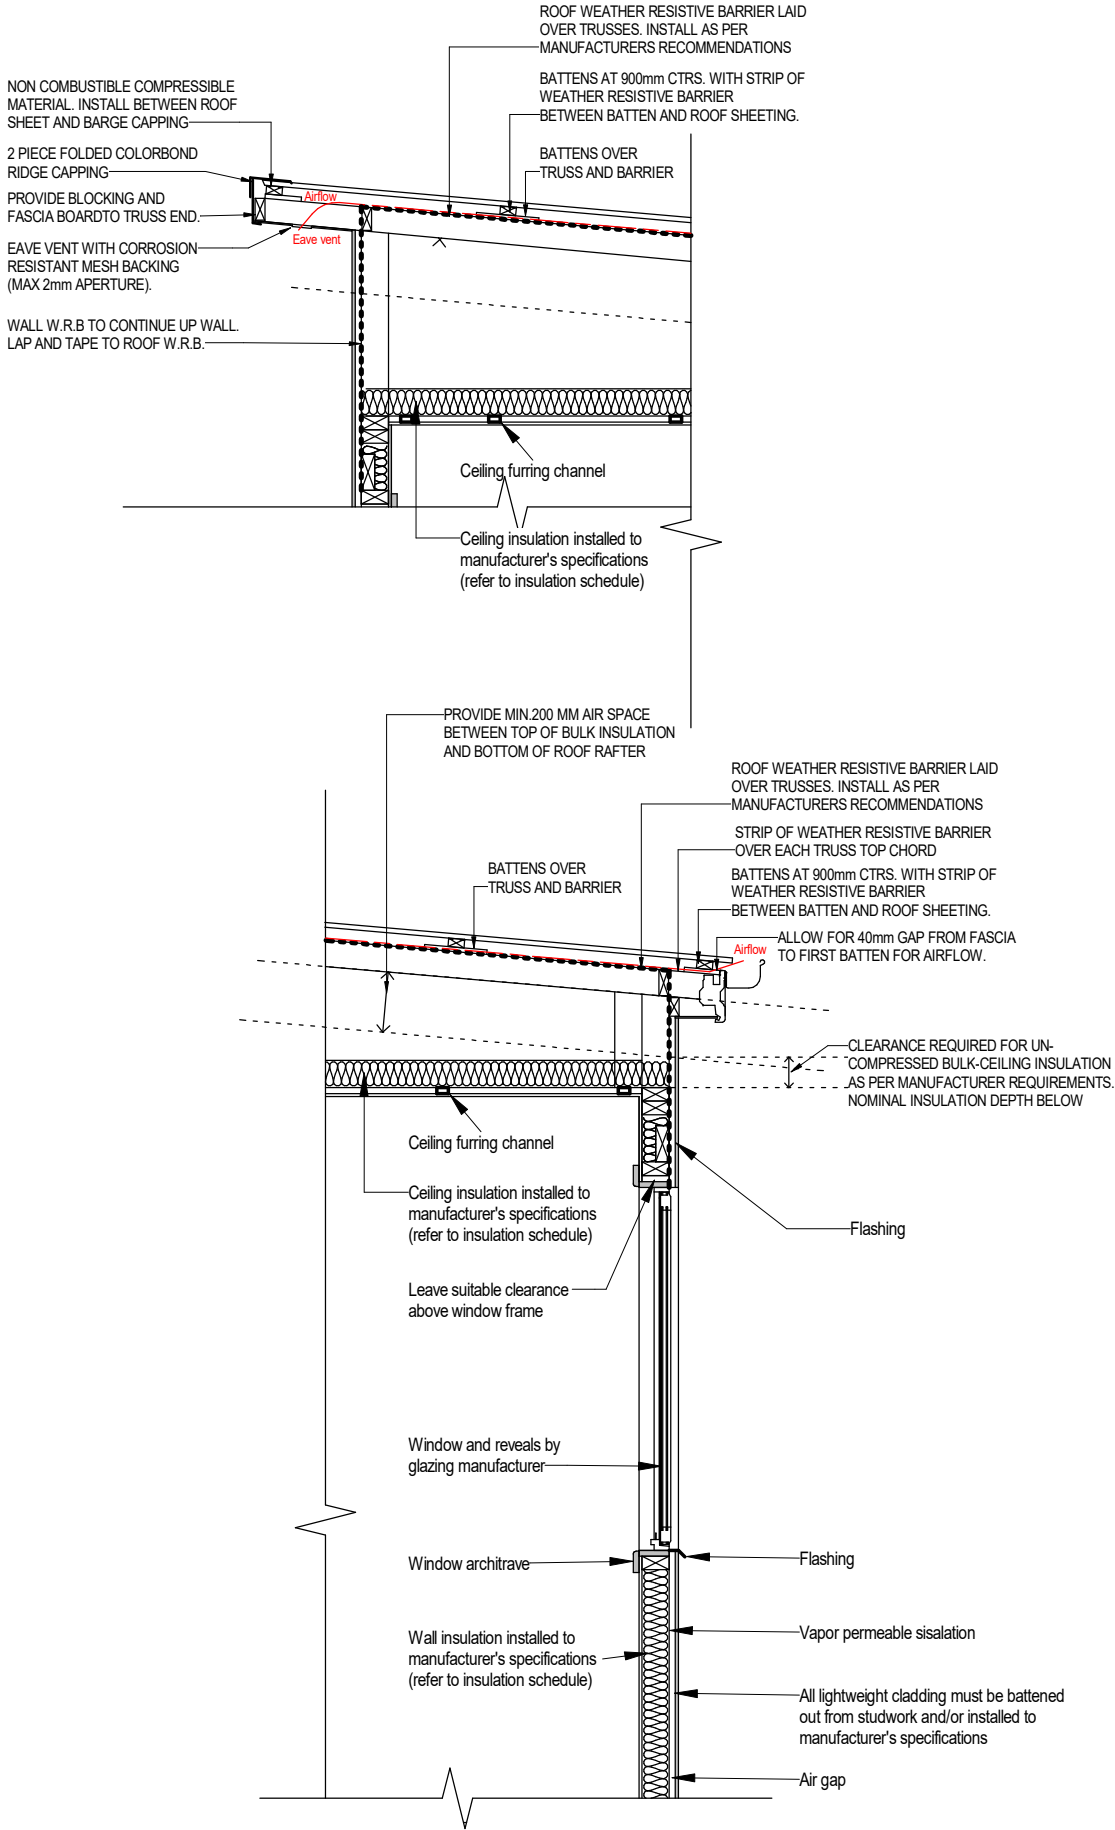

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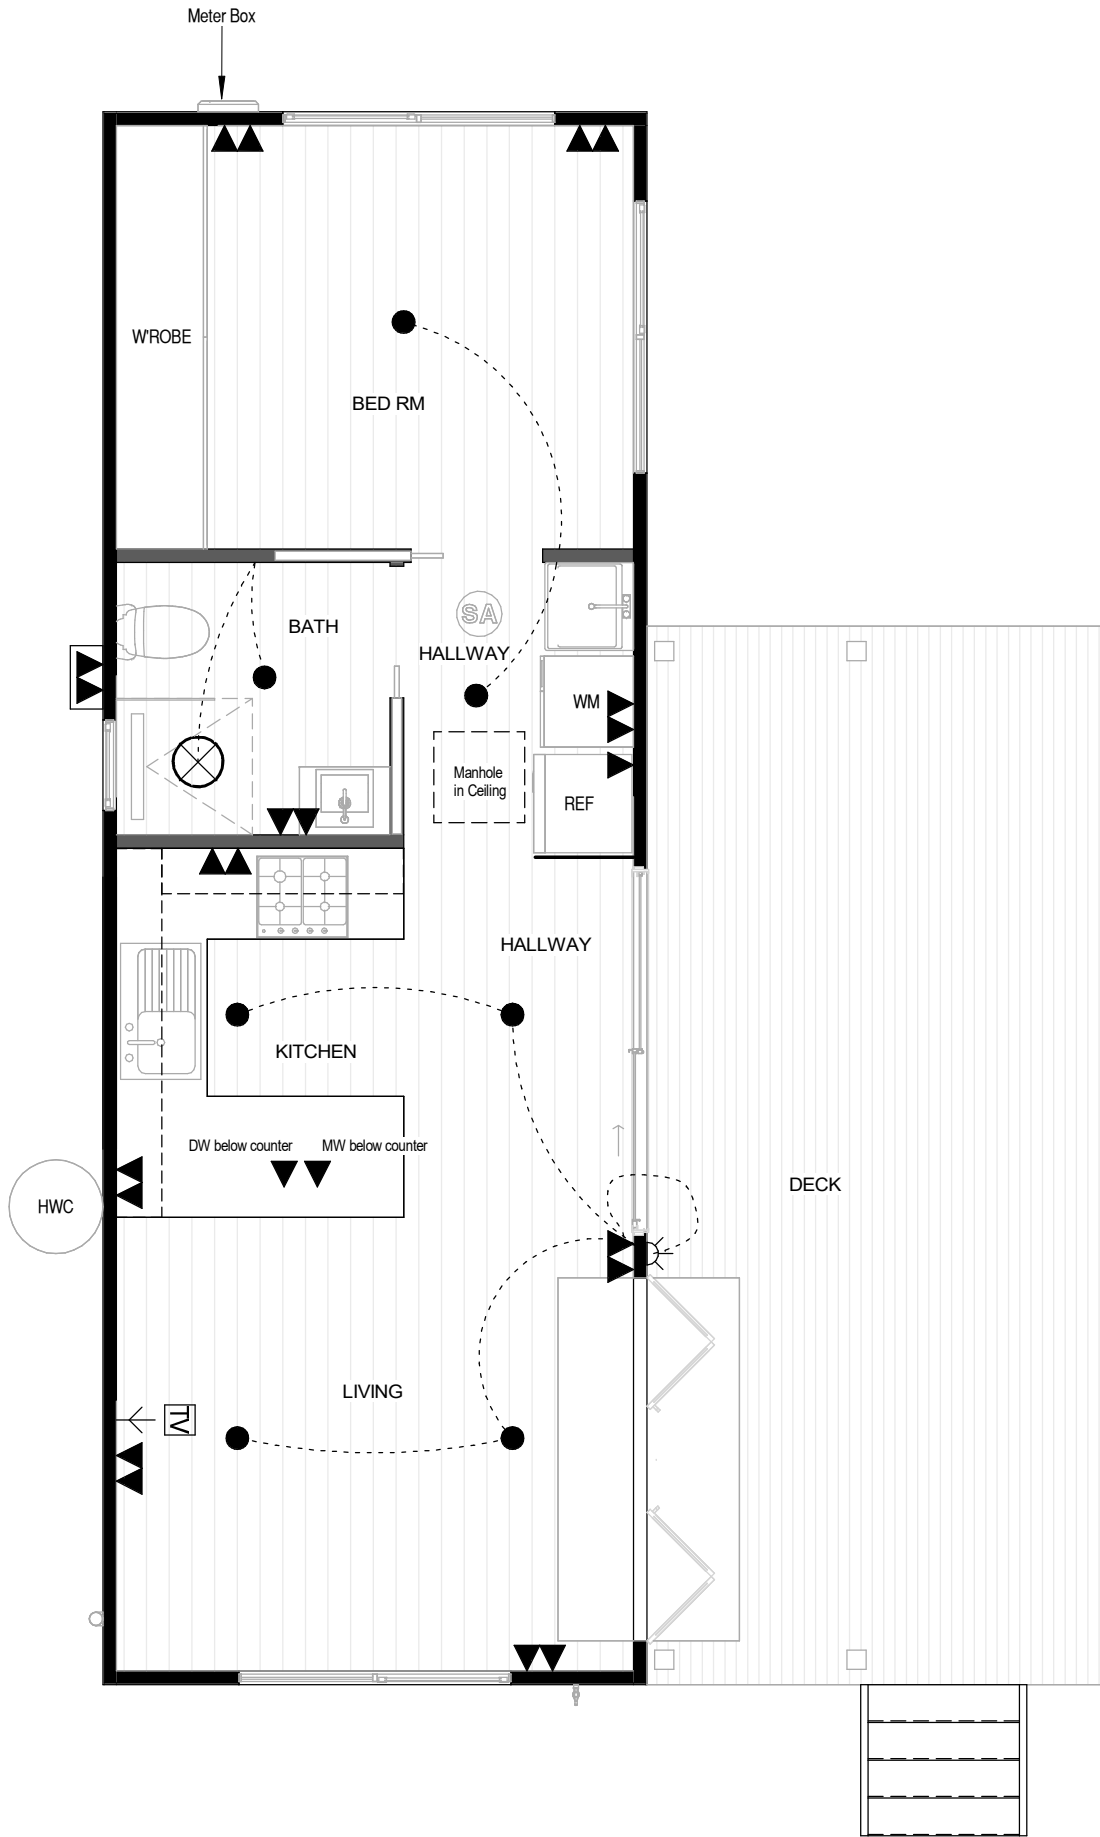
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TITLE

SECTION Ancillary DWELLING

Scale Check 40mm original size

Scale: As indicated	Client / Project Name	Job No: H4U_02
Date: 14.11.2025	Project Address 44 ALMA ROAD, ORFORD	Sheet No: 10
Drawn by: Ranjot Kaur		



ELECTRICAL LEGEND		
		No.s
▼	Single GPOs	3
▼▼	Double GPOs	9
●	LED Downlight	7
⊗	Mechanical Exhaust Fan	1
⊙SA	Smoke Alarm	1
⊞→	TV Point	1
⬮⬮	Power Point Weatherproof	1
↵	Wall Light	1

NOTES:

- Rangehood to be ducted to outside
- External NBN under meterbox [where applicable]
- Where Exhaust fans are provided with no other form of ventilation, fan must be activated simultaneously with light
- Smoke alarm to be connected to the mains power supply and possess a battery back-up and be interconnected; to provide a common alarm throughout the building, and be to AS 3786-2014, and installed to NCC Clause 3.7.5.5.

GLAZING NOTE:
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BAL Level: 12.5

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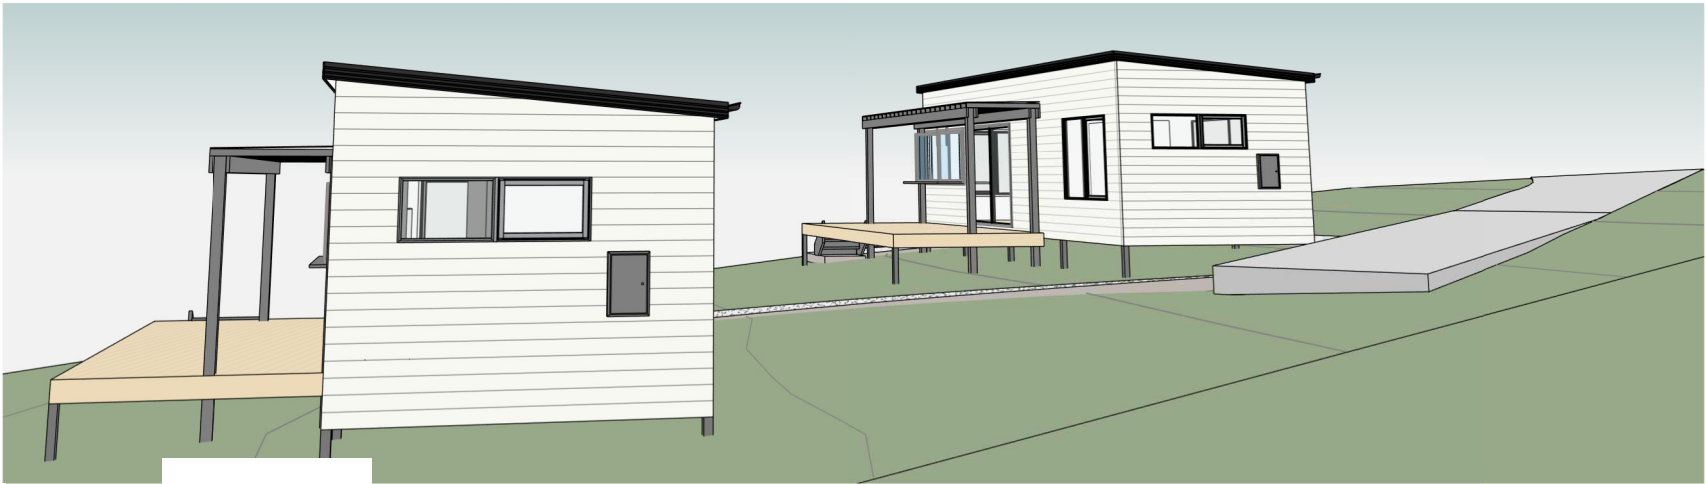
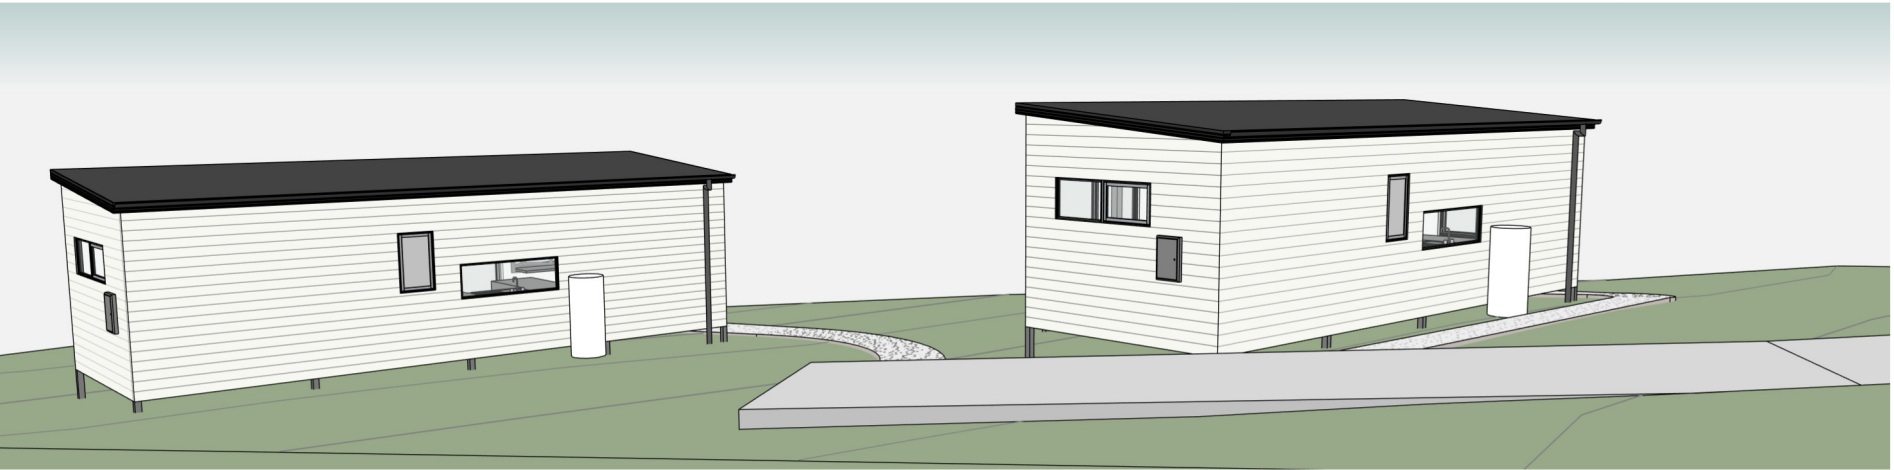
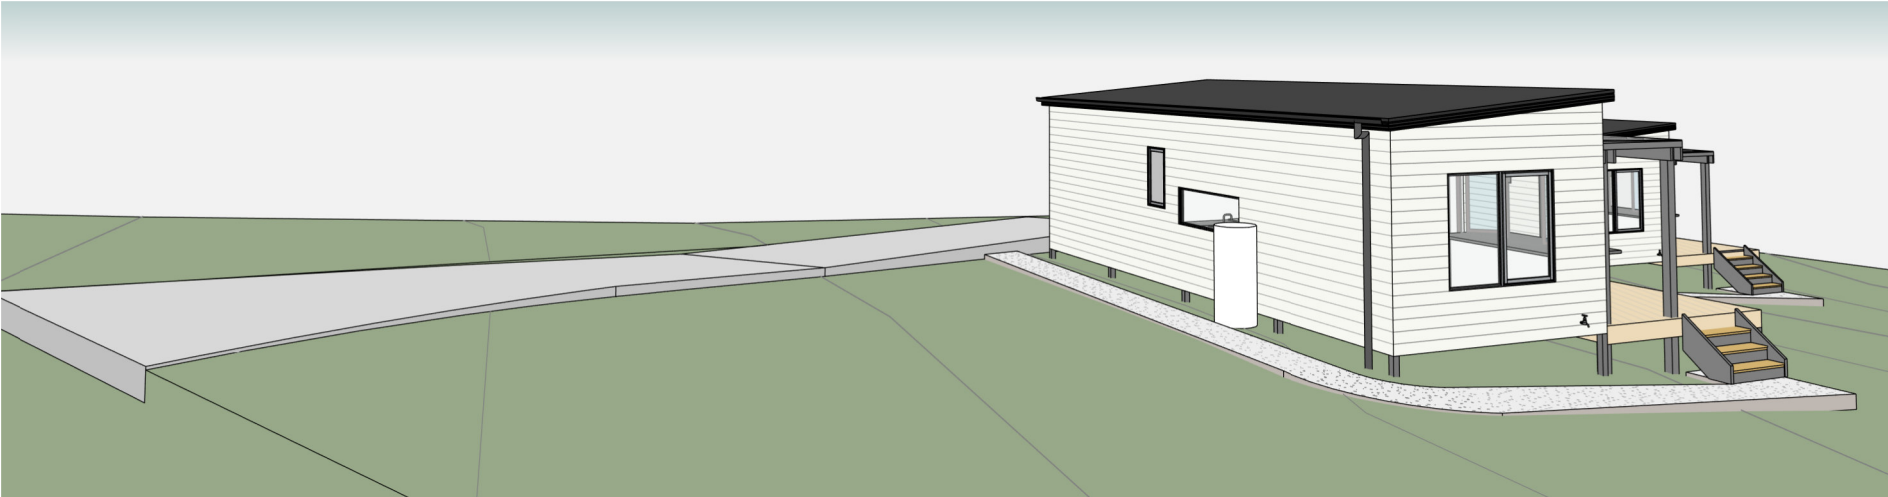
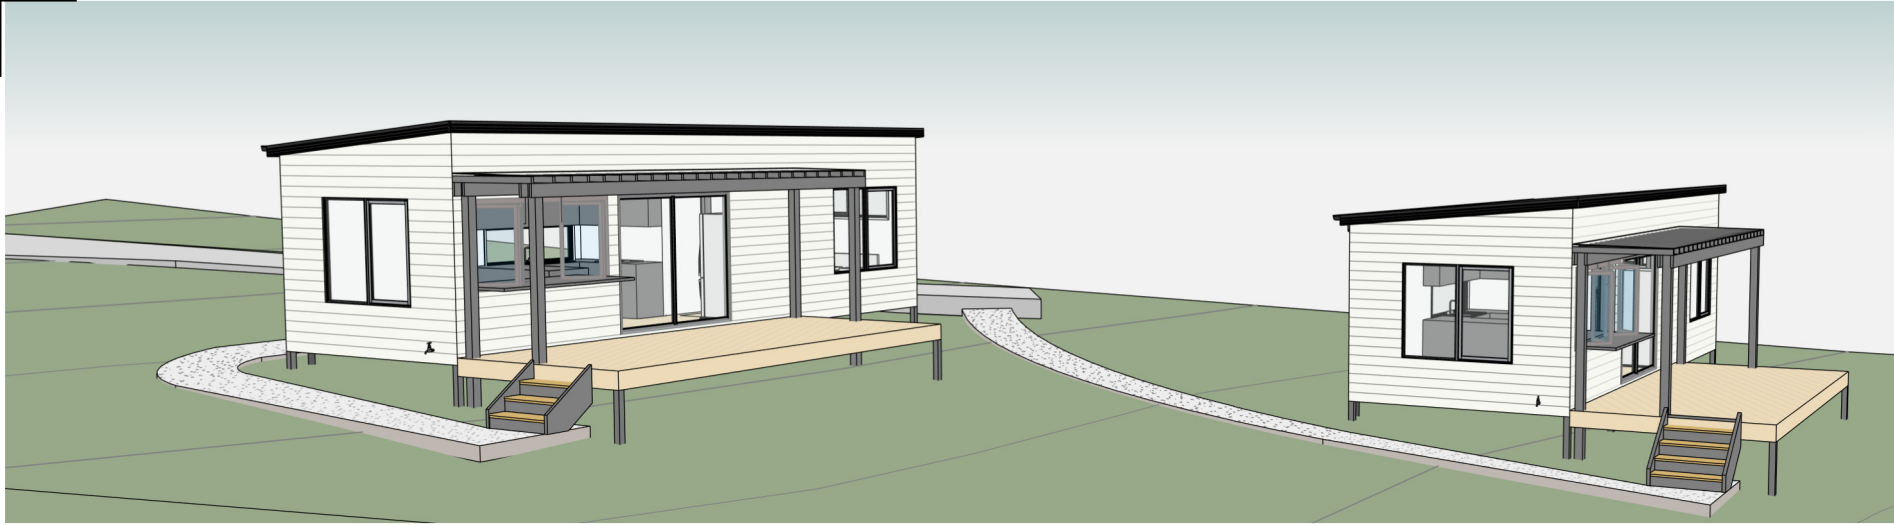
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TITLE

ELECTRICAL PLAN_
ANCILLARY DWELLING

Scale Check 40mm original size

Scale:	As indicated	Client / Project Name	Job No:
Date:	14.11.2025	Project Address	H4U_02
Drawn by:	Ranjot Kaur	44 ALMA ROAD, ORFORD	Sheet No:
			11



GLAZING NOTE:
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BAL Level: 12.5

Rev.	DA PLANS	14.11.2025	RK
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TITLE

3D VIEWS

Scale Check 40mm original size

Scale:

Date: 14.11.2025

Drawn by: Ranjot Kaur

Client / Project Name

Project Address


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Sheet No:

44 ALMA ROAD, ORFORD

H4U_02

12

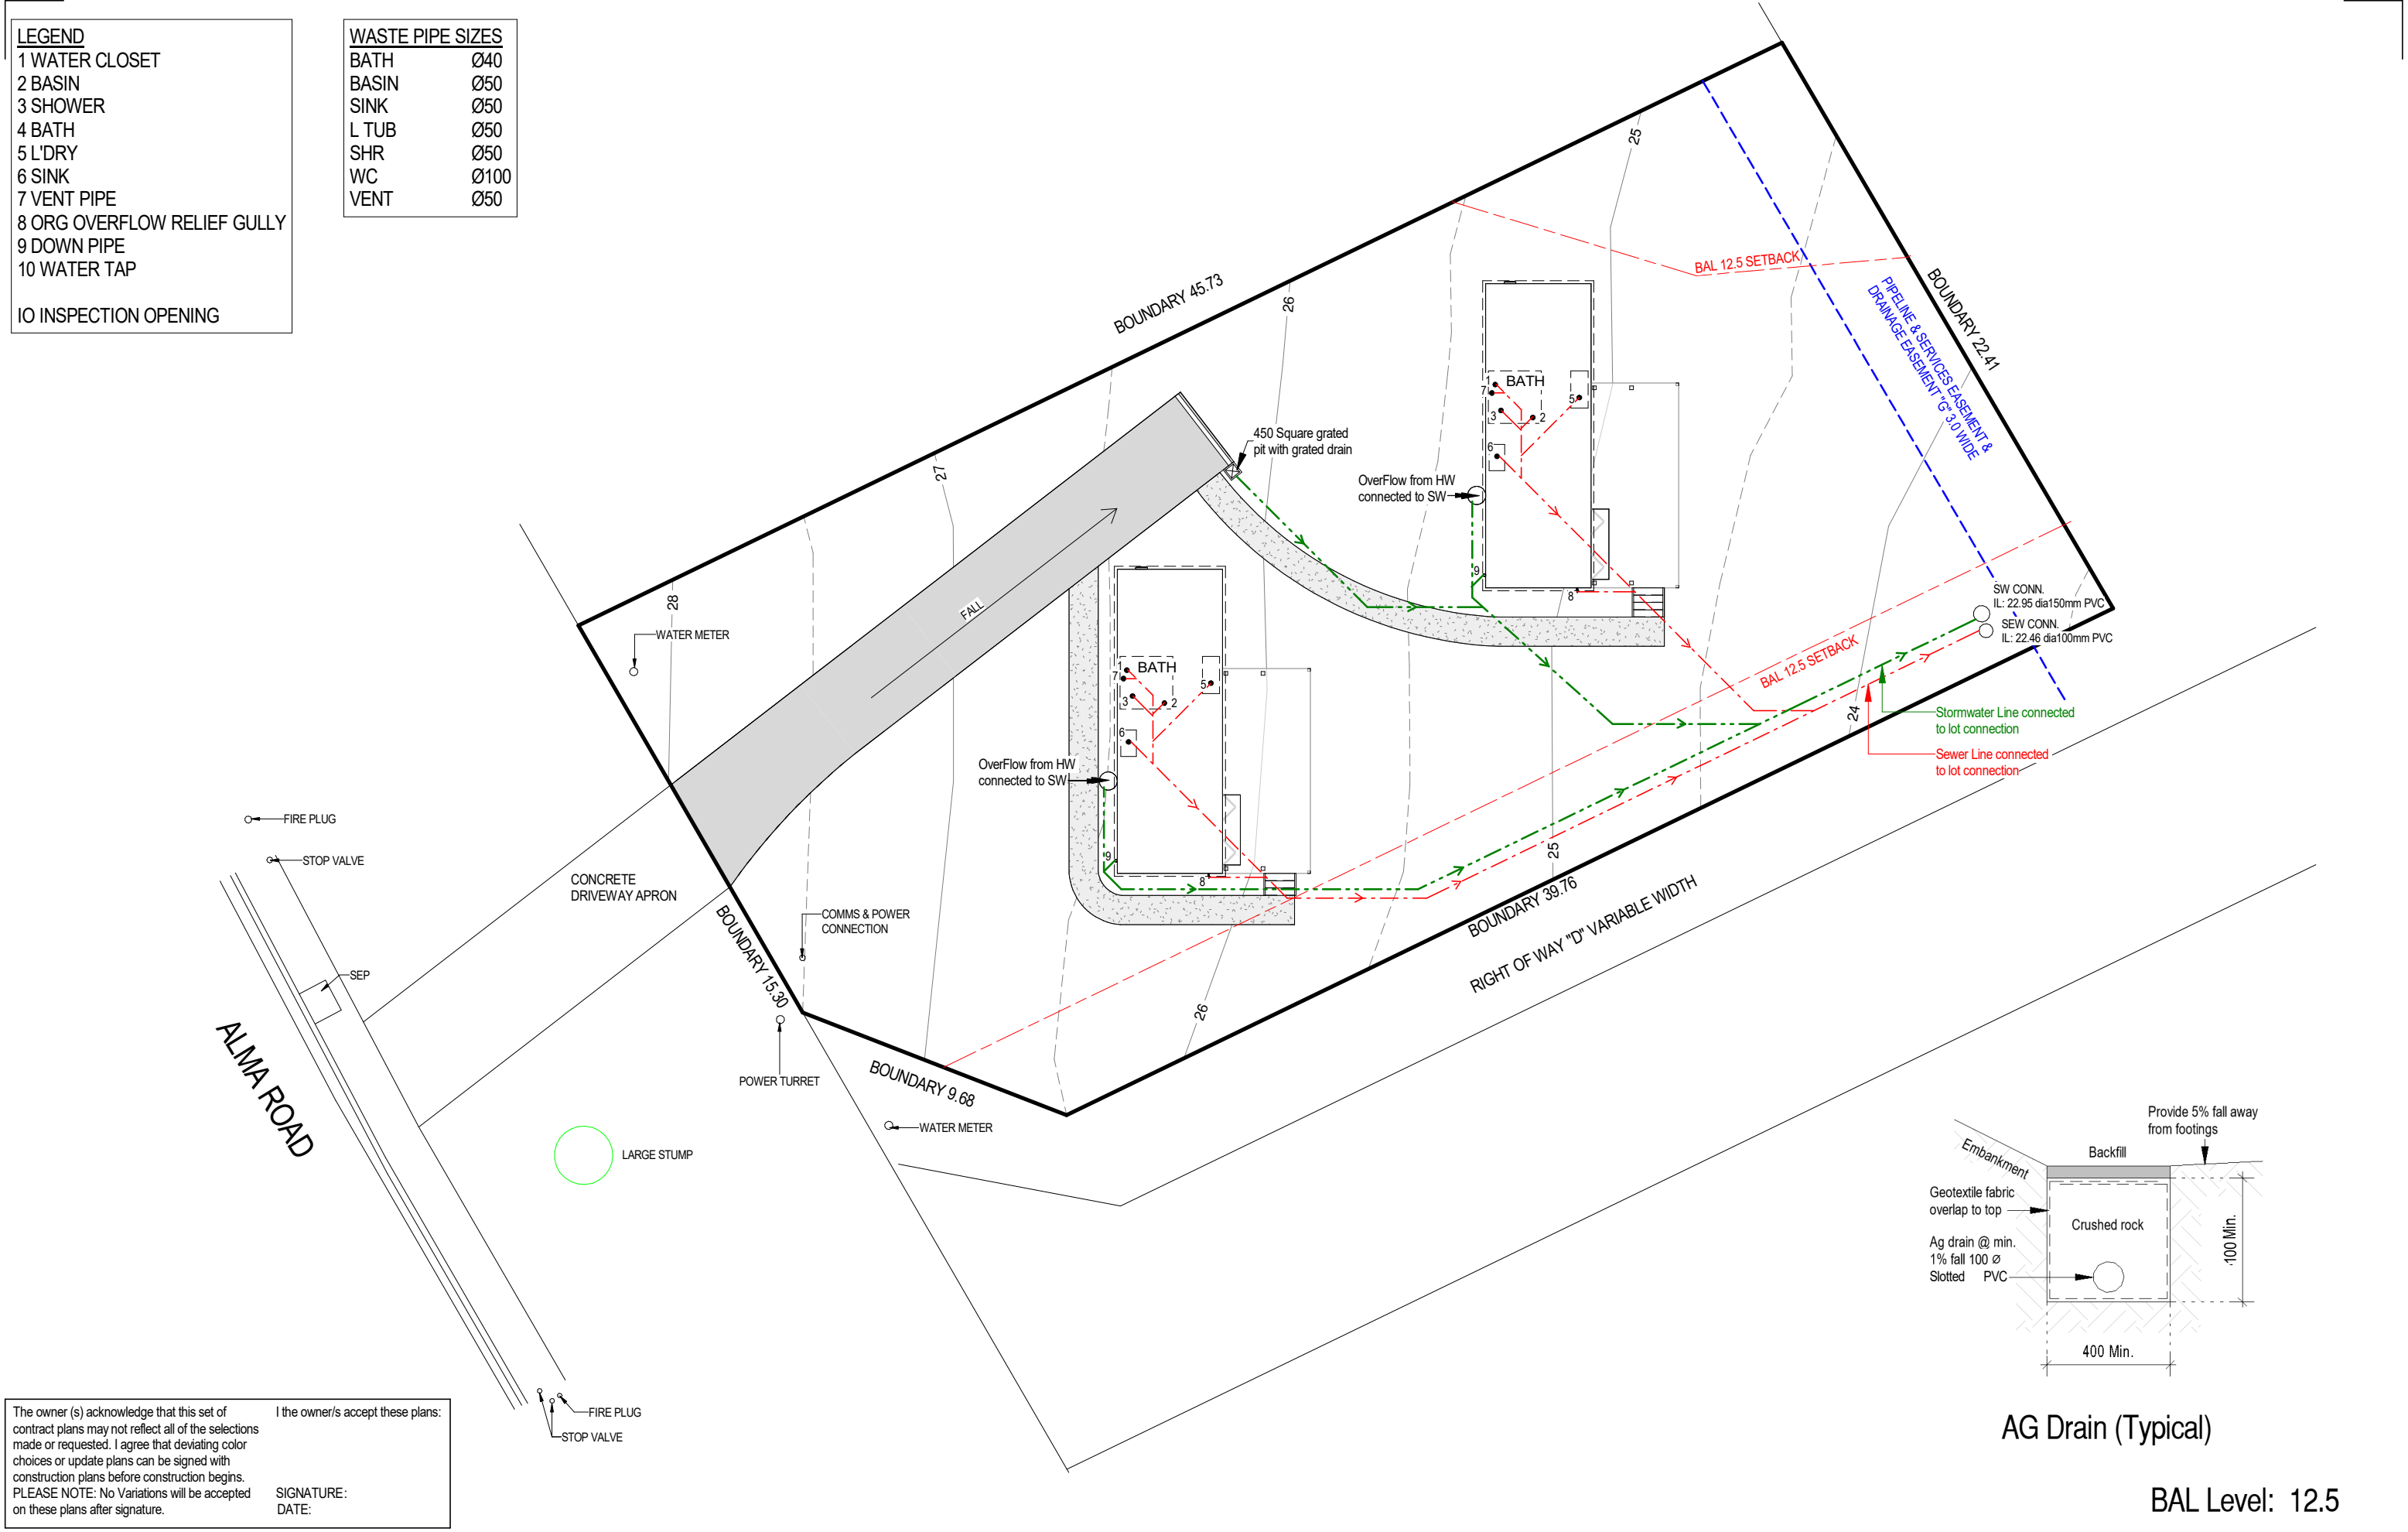

CONSTRUCTION SCHEDULE BAL-12.5

Construction shall be in accordance with Bushfire Attack Level 12.5 BAL-125) specified in AS 7955-2018 Construction of Buildings in Bushfire Prone Areas, Sections 3 and 5.

SUEFLOOR shall be either stab-on-ground or timber on isolated piers with brick perimeter. The standard does not provide construction requirements for either of these subfloor construction methods. Refer Section 5.3.1 for detail.

EXTERNAL WALLS shall be timber framing, externally lined with sarking and clad with brick veneer or Weathertex cladding respectively Weathertex is stated as having a density of 990kg/m^3 Any exposed timber shall bushfire resistant timber (AS 3999-2018 Appendix E1 or Appendix F compliant). Compliant timbers include Tas Oak (as Messmate, Peppermint & Manna Gum) or Southern Blue Gum as long as the density ls 750 kg/m^3 or greater. Refer section 5.4.1 for detail.

JOINTS IN EXTERNAL WALLS are to be covered, sealed, overlapped, backed or butt-jointed to prevent gaps greater than 3mm. Refer section 5.4.2 for detail.

VENTS, WEEPHOLES AND GAPS IN EXTERNAL WALLS greater than 3mm are to be fitted with 2mm minimum aperture, corrosion resistant steel, bronze, or aluminium mesh. Refer section 5.4.3 for detail.

BUSHFIRE SHUTTERS when used, shall protect the whole window/door assembly and shall be fixed to the building and be non-removable with gaps no greater than 3mm between the shutter and the wall, sill, or head. They must be manually openable from either inside or outside. They shall be made of non-combustible material or bushfire resistant timber AS 3959-2018 Appendix F compliant). Perforations must have an area no greater than 20% of the shutter and be uniformly distributed with gaps no greater than 3mm (or no greater than 2mm when the openable portion of the window is not screened).

SCREENS shall be fitted internally or externally to openable portions of windows. Screens shall be aluminium framed with 2mm minimum aperture, corrosion resistant steel, bronze, or aluminium mesh. No gaps between the perimeter of the screen assembly and the building are to be greater than 3mm. Refer section 5.5.2 for detail. Alternatively, compliant bushfire shutters may be installed.

WINDOWS AND GLAZED SLIDING DOORS and their frames, joinery and architraves can be aluminium framed but can also be PVC which is shown to be bushfire resistant or bushfire resistant timber (AS 3959-2018 Appendix E2 or Appendix F compliant). Compliant timbers include Celery Top, Blackwood, Myrtle, Southern Blue Gum, some Tas Oak (as Messmate, Alpine Ash, Mountain Ash, Silvertop Ash, Peppermint & Manna Gum) or Plantation Ash (as Shining Gum) as long as the density is 650 kg/m^3 or greater.

Windows less than 400mm from the ground or less than 400mm above decks, carport roofs, veranda roofs and awnings which have an angle less than 18 degrees shall be a minimum of 4mm Grade A safety glass. When using double glazing this requirement applies to the external face only. Windows above 400mm (when specific glazing is not required by other relevant standards) may use annealed glass. Sliding doors shall be glazed with a minimum of Grade A safety glass. Refer section 5.5.3 for detail. Alternatively, compliant bushfire shutters may be installed. Care should be taken to ensure that the energy assessor for this project is aware of the minimum glazing requirements for this BAL classification so as to avoid conflict with glazing specifications.

SIDE HUNG EXTERNAL DOORS can be either non-combustible or solid timber with a minimum thickness of 35mm or hollow core with a non-combustible kick plate on the outside for the first 400mm above the threshold Glazed doors including French doors and bi-fold must have glazing that complies with the glazing requirements for windows and the frame can be aluminium framed or PVC which is shown to be bushfire resistant or bushfire resistant timber (AS 3959-2018 Appendix E2 or Appendix F compliant). Compliant timbers include Celery Top, Blackwood, Myrtle, Southern Blue Gum, some Tas Oak (as Messmate, Alpine Ash, Mountain Ash, Silvertop Ash, Peppermint & Manna Gum) or Plantation Ash (as Shining Gum) as long as the density is 650 kg/m^3 or greater Refer section 5.5.3 for detail.

DOOR JAMBS AND ARCHITRAVES can be aluminium framed or PVC which is shown to be bushfire resistant or bushfire resistant timbe (AS 3959-2018 Appendix E2 or Appendix F compliant). Compliant timbers include Celery Top, Blackwood, Myrtle, Southern Blue Gum, some Tas Oak (as Messmate, Alpine Ash, Mountain Ash, Silvertop Ash Peppermint & Manna Gum) or Plantation Ash (as Shining Gum) as long as the density is 650kg/m^3 or greater. Doors must be tight-fitting to the door jamb (and to the abutting door where applicable). Weather strips or draught excluders shall be installed to all side-hung external doors.

GARAGE DOORS must be fully non-combustible or have the lower portion of the door which is within 400mm of the ground be non-combustible. Panel lift, tilt or side hung doors shall be fitted with weather strips, draught excluders or guide tracks as appropriate to the door type with gaps no greater than 3mm. Roller doors shall have guide tracks with gaps no greater than 3mm or fitted with a nylon brush that is in contact with the door. Refer section 5.5.6 for detail.

ROOF shall be timber framing, lined with sarking on the outside of the frame and clad with corrugated Colourbond cladding. Any gaps under ribs or roof components such as roof eave, fascia and wall junctions are to be sealed with 2mm aperture corrosion resistant, steel, bronze or aluminium mesh, or filled with mineral wool to prevent openings greater than 3mm. Refer section 5.6.1 , 5.6.2 & 5.6.3 for detail.

VERANDAH, CARPORT OR AWNING ROOFS forming part of the main roof shall meet the requirements of the main roof. Refer section 5.6.4 for detail.

ROOF PENETRATIONS such as skylights, vent pipes and aerials that penetrate the roof shall be sealed to prevent openings greater than 3mm Openable and vented skylights or vent pipes shall be fitted with 2mm aperture corrosion resistant, steel, bronze, or aluminium mesh ember guards. All overhead glazing shall be Grade A safety glass. PVC vent pipes are permitted. Refer section 5.6.5 for detail.

EAVES LINING, FASCIA AND GABLES shall be cement sheet or equivalent non-combustible material and sealed to prevent openings greater than 3mm. Refer section 5.6.6 for detail.

GUTTERS AND DOWNPIPE materials and requirements are not specified in the standard for BAL-12.5 with the exception of box gutters which shall be non-combustible. Gutter and valley leaf guards are not a requirement of the standard but they are strongly recommended. If installed, they must be non-combustible. Refer section 5.6.7 for detail.

VERANDAH AND DECK SUPPORTS AND FRAMING can be timber construction as there are no construction requirements in the standard for BAL-12.5. Decking may be spaced or un-spaced and the sub-floor either enclosed or unenclosed. If the decking is spaced, it is assumed that the spacing shall be 3mm nominal spacing with an allowance of between 0-5mm due to seasonal changes. If the deck sub-floor is enclosed, then all materials less than 400mm from the ground shall be non-combustible. Refer section 5.7.1, 5.7.2 & 5.7.3 for detail.




VERANDAHS, DECKS, STEPS, LANDINGS AND RAMPS and their elements can be timber construction as there are no construction requirements for BAL-12.5 except for elements less than 300mm horizontally and 400mm vertically from glazed elements which must be bushfire resistant timber (AS 3959-2018 Appendix E1 or Appendix F compliant) or equivalent non-combustible material. Compliant timbers include Tas Oak (as Messmate, Peppermint & Manna Cum) or Southern Blue Gum as long as the density of 750kg/m^3 or greater. An acceptable solution would be to line the area with cement sheet with ceramic tiles over. Refer section 5.7.2.4 for detail.

BALUSTRADES AND HANDRAILS can be timber construction as there are no construction requirements in the standard for BAL 12.5. Refer section 5.7.4 for detail.

WATER AND GAS SUPPLY PIPING where it is above ground and exposed shall be metal. Refer section 5.8 for detail

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		SIGNATURE: DATE:	

BAL Level: 12.5

				<div><div>PERYTON HOMES</div></div> <div>PERYTON HOMES Pty Ltd 177 Pulpit Rock Road, New Norfolk Hobart TAS 7140</div> <div>Designer: Ranjot Kaur Mob. 0450 656 007 Email: ranjot@perytonhomes.com.au Licence Number: 173530973</div>	<div><div>HOMES4YOU</div></div> <div>HOMES4YOU 132 Forster Street, Invermay TAS 7248</div>	<div>*GENERAL NOTES: - All works to be completed as per the current National Construction Code (N.C.C.) and relevant Australian Standards - All products and materials must be installed as per the relevant manufacturers specifications - This document is uncontrolled in hard copy format, do not scale from drawings - Builder to confirm all dimensions are correct prior to start of works. CONTROL MEASURE: All persons entering the site must be made aware of potential hazards and take relevant actions to ensure that their work are is maintained as safe to proceed. If you are unable to proceed due to the existence of an unsafe work area, you must notify your site supervisor immediately so that action can be taken to remedy the situation.</div>	TITLE BAL 12.5 NOTES <div><div>Scale Check 40mm original size</div></div>	Scale: 1 : 20 Date: 14.11.2025 Drawn by: Ranjot Kaur	Client / Project Name Project Address 44 ALMA ROAD, ORFORD	Job No: H4U_02 Sheet No: 14	
	DA PLANS	14.11.2025	RK								
Rev.	Revision Description	Date	Drawn								

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H4D2 Part 10.2.1 Wet Areas

Building elements in wet areas within a building must:

- (a) be waterproof or water resistant in accordance with Table 10.2.2; and
- (b) comply with AS 3740.

Table 10.2.2 Waterproofing and water resistance requirements for building elements in wet areas

Vessels or area where the fixture is installed	Floors and horizontal surfaces	Walls	Wall junctions and joints	Wall / floor junctions	Penetrations
Shower area (enclosed and unenclosed)					
With hob	Waterproof floor in shower area (including any hob or step-down)	The walls of the shower area must be waterproof not less than 1800 mm above the floor substrate	Wall junctions and joints within the shower area must be waterproof not less than 40 mm either side of the junction	Wall/floor junctions within the shower area must be waterproof	Waterproof penetrations in shower area.
With step-down					
Without hob or step-down					
Vessels or area where the fixture is installed					
Area outside shower area					
For concrete and compressed fibre-cement sheet flooring	Water resistant floor of the room.	N/A	N/A	a) Waterproof wall / floor junctions b) where a flashing is used, the horizontal leg must be not less than 40 mm	N/A
For timber floors including particleboard, plywood and other timber based flooring materials	Waterproof floor of the room				
Areas adjacent to baths and spas					
For concrete and compressed fibre-cement sheet flooring	Water resistant floor of the room.	(a) Water resistant to a height of not less than 150 mm above the vessel, for the extent of the vessel, where the vessel is within 75 mm of a wall. (b) Water resistant all exposed surfaces below vessel lip.	Water resistant junctions within 150 mm above a vessel/ for the extent of the vessel.	Water proof wall / floor junctions for the extent of the vessel.	Waterproof tap and spout penetrations where they occur in horizontal surfaces.
For timber floors including particleboard, plywood and other timber based flooring materials	Waterproof floor of the room.	(a) Water resistant to a height of not less than 150 mm above the vessel, for the extent of the vessel, where the vessel is within 75 mm of a wall. (b) Water resistant all exposed surfaces below vessel lip.	Water resistant junctions within 150 mm above a vessel/ for the extent of the vessel.	Water proof wall / floor junctions for the extent of the vessel.	Waterproof tap and spout penetrations where they occur in horizontal surfaces.
Inserted baths and spas	(a) Waterproof shelf area, incorporating waterstop under the vessel lip. (b) No requirement under bath.	(a) Waterproof to not less than 150 mm above the lip of the bath or spa; and (b) No requirement under bath.	(a)Waterproof junctions within 150 mm above bath or spa; and (b)No requirement under bath.	N/A	Waterproof tap and spout penetrations where they occur in horizontal surfaces.

The owner (s) acknowledge that this set of contract plans may not reflect all of the selections made or requested. I agree that deviating color choices or update plans can be signed with construction plans before construction begins. PLEASE NOTE: No Variations will be accepted on these plans after signature.



I the owner/s accept these plans:

SIGNATURE: _____
DATE: _____

NOTE: User of this Standard should refer to the current edition of the NCC for any changes to the tables.

Vessels/ or area where the fixture is installed	Floors and horizontal surfaces	Walls	Wall junctions and joints	Wall / floor junctions	Penetrations
Other areas					
Laundries and WCs	Water resistant floor of the room	N/A	N/A	Water resistant wall / floor junctions, and where a flashing is used, the horizontal leg must not be less than 40 mm.	N/A
Walls adjoining other vessels (e.g. sink, basin or laundry tub	N/A	Water resistant to a height of not less than 150 mm above the vessel, for the extent of the vessel, where the vessel is within 75 mm of a wall.	Waterproof wall junctions where a vessel is fixed to a wall.	N/A	Waterproof tap and spout penetrations where they occur in surfaces required to be waterproof or water resistant.
N/A means not applicable. Where a shower is above a bath or spa, use requirements for shower.					

Extent of Waterproofing
Where the shower shown in the Figures is not enclosed, the wet area is to be taken as 1500 mm from the shower connection.

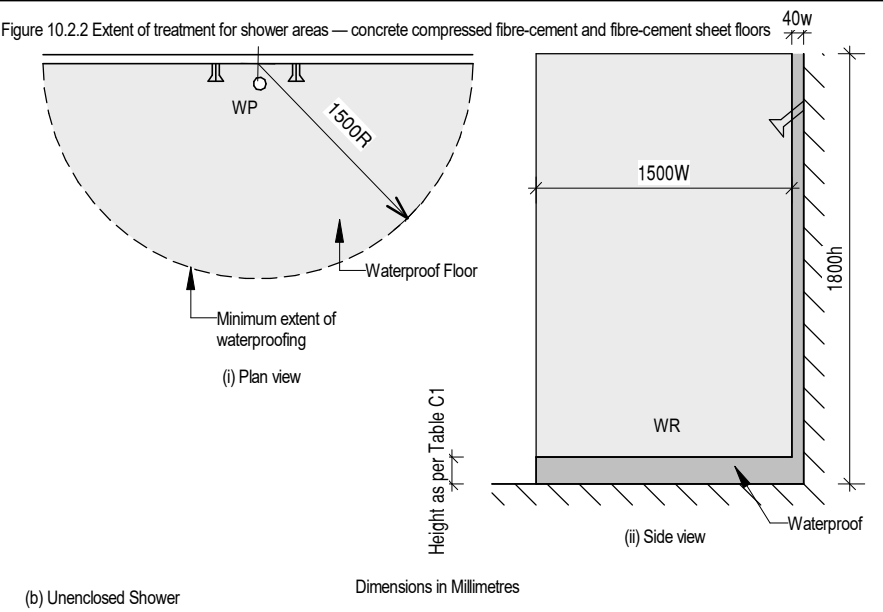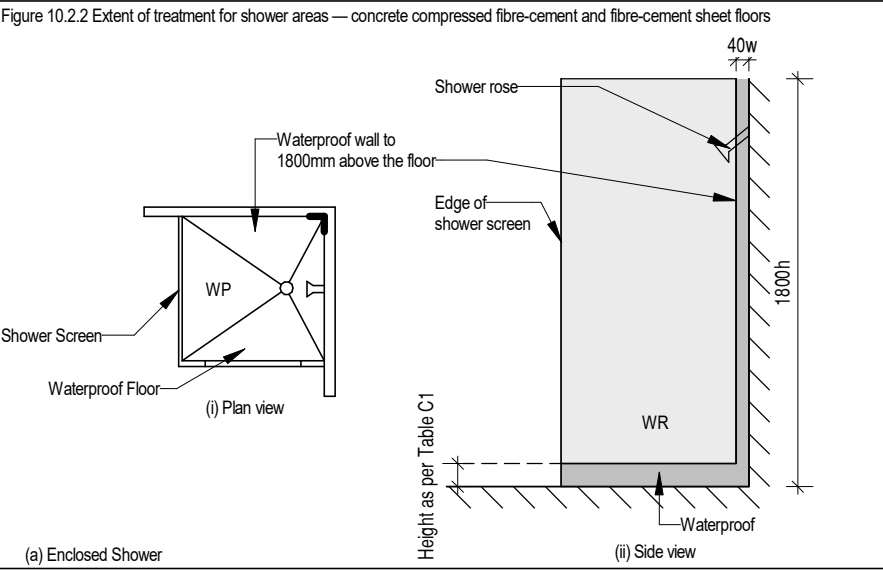

For further wet area notes not shown on this document, refer to AS3740 AS3740 to take precedence of this document

BAL Level: 12.5

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I the owner/s accept these plans:			
SIGNATURE: _____			
DATE: _____			
Rev.	Revision Description	Date	Drawn



PERYTON HOMES Pty Ltd
177 Pulpit Rock Road, New Norfolk
Hobart TAS 7140

Designer: Ranjot Kaur
Mob. 0450 656 007
Email: ranjot@perytonhomes.com.au

*GENERAL NOTES:
- All works to be completed as per the current National Construction Code (N.C.C.) and relevant Australian Standards
- All products and materials must be installed as per the relevant manufacturers specifications
- This document is uncontrolled in hard copy format, do not scale from drawings
- Builder to confirm all dimensions are correct prior to start of works.
CONTROL MEASURE:
All persons entering the site must be made aware of potential hazards and take relevant actions to ensure that their work are maintained as safe to proceed. If you are unable to proceed due to the existence of an unsafe work area, you must notify your site supervisor immediately so that action can be taken to remedy the situation.

TITLE
WET AREA SPECS
Scale Check 40mm original size

Scale: 1 : 1
Date: 14.11.2025
Drawn by: Ranjot Kaur
Client / Project Name
Project Address
44 ALMA ROAD, ORFORD

Job No:
H4U_02
Sheet No:
16