



GLAMORGAN/SPRING BAY COUNCIL
NOTICE OF PROPOSED DEVELOPMENT

Notice is hereby given that an application has been made for planning approval for the following development:

SITE: **18 Nairn Street, Buckland
CT 185631/2**

PROPOSAL: **Residential - Single Dwelling**

Any person may make representation on the application(s) by letter (PO Box 6, Triabunna) or electronic mail (planning@freycinet.tas.gov.au) addressed to the Chief Executive Officer. Representations must be received before midnight on 05 February 2026.

APPLICANT: **Wilson Homes / Lutzia Brown**
DATE: **18/11/2025**
APPLICATION NO: **DA 2025 / 00209**

Application for Planning Approval

Advice:

Use this form for all no permit required, permitted and discretionary planning applications including visitor accommodation, subdivision as well as for planning scheme amendment & minor amendments to permits.

Completing this form in full will help ensure that all necessary information is provided and avoid any delay. The planning scheme in clause 6.0 provides details of other information that may be required. A checklist of application documents is provided on page 4 of this form.

Often, it is beneficial to provide a separate written submission explaining in general terms what is proposed and why and to justify the proposal against any applicable performance criteria.

If you have any queries with the form or what information is required, please contact the office.

Details of Applicant and Owner			
Applicant:			
Contact person: (if different from applicant)			
Address:			
Suburb:		Post Code:	
Email:		Phone: / Mobile:	

Note: All correspondence with the applicant will be via email unless otherwise advised

Owner (if different from applicant)			
Address:			
Suburb:		Post Code:	
Email:		Phone: / Mobile:	

Details of Site <i>(Note: If your application is discretionary, the following will be placed on public exhibition)</i>			
Address of proposal:			
Suburb:		Post Code:	
Size of site: (m ² or Ha)			
Certificate of Title(s):			
Current use of site:			

General Application Details *Complete for All Applications*

Description of proposed use or development:		
Estimated value of works: (design & construction)	\$	
The estimated cost is to include the cost of labour and materials using current industry pricing and is to include GST. You may be required to verify this estimate.		
Is the property on the State Heritage Register? (Circle one)	Yes / No	

For all Non-Residential Applications

Hours of Operation	
Number of Employees	
Describe any delivery of goods to and from the site, including the types of vehicles used and the estimated average weekly frequency	
Describe any hazardous materials to be used or stored on site	
Type & location of any large plant or machinery used (refrigeration, generators)	
Describe any retail and/or storage of goods or equipment in outdoor areas	

Personal Information Protection Statement

The personal information requested will be managed in accordance with the *Personal Information Protection Act 2004*. The personal information is being collected by Glamorgan Spring Bay Council for the purposes of managing, assessing, advising on, and determining the relevant application in accordance with the *Land Use Planning and Approvals Act 1993*(LUPPA) and other related purposes, including for the purpose of data collection.

The information may be shared with contractors and agents of the Council for this purpose, law enforcement agencies, courts and other organisations and it may also be made publicly available on the Council's website and available for any person to inspect in accordance with LUPAA. If you do not provide the information sought, Council will be unable to accept and/or process your application.

Applicant Declaration

I/we hereby apply for planning approval to carry out the use or development described in this application and the accompanying documents and declare that:

- The information in this application is true and correct.
- I/we authorise Council employees or consultants to enter the site to assess the application.
- I/we have obtained all copy licenses and permission from the copyright owner for the publication, communication and reproduction of the application and reports, plans and materials provided as part of the application and for the purposes of managing, assessing, advising on, and determining the application.

I/we authorise the Council to:

- Make available the application and all information, reports, plans, and materials provided with or as part of the application in electronic form on the Council's website and in hard copy at the Council's office and other locations for public exhibition if and as required;
- Make such copies of the application and all information, reports, plans and materials provided with or as part of the application which are, in the Council's opinion, necessary to facilitate a consideration of the application;
- Publish and or reproduce the application and all information, reports, plans and materials provided with or as part of the application in Council agendas, for representors, referral agencies and other persons interested in the application; and
- provide a copy of any documents relating to this application to any person for the purpose of assessment or public consultation and agree to arrange for the permission of the copyright owner of any part of this application to be obtained.

You indemnify the Council for any claim or action taken against the Council for breach of copyright in respect of the application and all information, report, plan, and material provided with or as part of the application.

I/We declare that the Owner has been notified of the intention to make this application in accordance with section 52(1) of the *Land Use Planning and Approvals Act 1993*.

Applicant Signature:	<i>Lutzia Brown</i>	Date:	
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Owners Consent required if application is on or affects Council or Crown owned or administered land

I declare that I have given permission for the making of this application for use and/or development.

Council General Manager or delegate Signature:		Date:	
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If land affected by this application is owned or administered by the Crown or Council, then the written permission of the relevant Minister (or their delegate) and/or the General Manager must be provided. For Crown land, a copy of the instrument of delegation must be provided.

It is the applicant's responsibility to obtain any owners consent prior to lodgement. Written requests for Council consent are via the General Manager. Request for Ministerial consent is to be directed to the relevant department.

Checklist of application documents:

Taken from Section 6 of the Planning Scheme

An application must include:

- ☐ a signed application form;
- ☐ any written permission and declaration of notification required under s.52 of the Act and, if any document is signed by the delegate, a copy of the delegation;
- ☐ details of the location of the proposed use or development;
- ☐ a copy of the current certificate of title for all land to which the permit sought is to relate, including the title plan; and
- ☐ a full description of the proposed use or development.

In addition to the information that is required by clause 6.1.2, a planning authority may, in order to enable it to consider an application, require such further or additional information as the planning authority considers necessary to satisfy it that the proposed use or development will comply with any relevant standards and purpose statements in the zone, codes or a specific area plan, applicable to the use or development including:

- ☐ any schedule of easements if listed in the folio of the title and appear on the plan, where applicable;
- ☐ a site analysis and site plan at a scale acceptable to the planning authority showing, where applicable:
 - (i) the existing and proposed use(s) on the site;
 - (ii) the boundaries and dimensions of the site;
 - (iii) topography including contours showing AHD levels and major site features;
 - (iv) natural drainage lines, watercourses and wetlands on or adjacent to the site;
 - (v) soil type;
 - (vi) vegetation types and distribution including any known threatened species, and trees and vegetation to be removed;
 - (vii) the location and capacity and connection point of any existing services and proposed services;
 - (viii) the location of easements on the site or connected to the site;
 - (ix) existing pedestrian and vehicle access to the site;
 - (x) the location of existing and proposed buildings on the site;
 - (xi) the location of existing adjoining properties, adjacent buildings and their uses;
 - (xii) any natural hazards that may affect use or development on the site;
 - (xiii) proposed roads, driveways, parking areas and footpaths within the site;
 - (xiv) any proposed open space, common space, or facilities on the site; and
 - (xv) proposed subdivision lot boundaries;
- ☐ where it is proposed to erect buildings, a detailed layout plan of the proposed buildings with dimensions at a scale of 1:100 or 1:200 as required by the planning authority showing, where applicable:
 - (xvi) the internal layout of each building on the site;
 - (xvii) the private open space for each dwelling;
 - (xviii) external storage spaces;
 - (xix) parking space location and layout;
 - (xx) major elevations of every building to be erected;
 - (xxi) the relationship of the elevations to existing ground level, showing any proposed cut or fill;
 - (xxii) shadow diagrams of the proposed buildings and adjacent structures demonstrating the extent of shading of adjacent private open spaces and external windows of buildings on adjacent sites; and
 - (xxiii) materials and colours to be used on roofs and external walls.

SEARCH OF TORRENS TITLE

VOLUME 185631	FOLIO 2
EDITION 2	DATE OF ISSUE 09-Sep-2025

SEARCH DATE : 11-Nov-2025

SEARCH TIME : 09.39 AM

DESCRIPTION OF LAND

Town of BUCKLAND

Lot 2 on Sealed Plan [185631](#)

Derivation : Part of 1A-2R-OP (Sec. M) Gtd. to William Rout

Prior CT [123934/1](#)SCHEDULE 1

[N275401](#) TRANSFER to Registered
09-Sep-2025 at 12.01 PM

SCHEDULE 2

Reservations and conditions in the Crown Grant if any
SP[185631](#) FENCING PROVISION in Schedule of Easements

UNREGISTERED DEALINGS AND NOTATIONS

No unregistered dealings or other notations

<p>OWNER PETER NORMAN PORCH</p> <p>FOLIO REFERENCE CT 123934-1</p> <p>GRANTEE WHOLE OF LOTS 1 AND 2, 1-2-0, WILLIAM ROUT</p>	<p>PLAN OF SURVEY BY SURVEYOR A. S. HAMILTON</p> <p>LOCATION TOWN OF BUCKLAND SECTION M</p> <p>SCALE 1: 750 LENGTHS IN METRES</p>	<p>Registered Number SP 185631</p> <p>APPROVED EFFECTIVE FROM 23 NOV 2023</p> <p><i>Renn</i> Recorder of Titles</p>
<p>ALL EXISTING SURVEY NUMBERS TO BE CROSS REFERENCED ON THIS PLAN</p>		

<p><i>[Signature]</i> REGISTERED LAND SURVEYOR</p> <p>21-8-23 DATE</p>	<p>AMENDED PLAN</p> <p><i>[Signature]</i> COUNCIL DELEGATE</p> <p>24/08/23 DATE</p>
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<p align="center">SCHEDULE OF EASEMENTS</p> <p>NOTE: THE SCHEDULE MUST BE SIGNED BY THE OWNERS & MORTGAGEES OF THE LAND AFFECTED. SIGNATURES MUST BE ATTESTED.</p>	<p align="center">Registered Number</p> <p align="center" style="font-size: 2em;">SP 185631</p>
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PAGE 1 OF 1 PAGE/S

EASEMENTS AND PROFITS

Each lot on the plan is together with:-

- (1) such rights of drainage over the drainage easements shown on the plan (if any) as may be necessary to drain the stormwater and other surplus water from such lot; and
- (2) any easements or profits a prendre described hereunder.

Each lot on the plan is subject to:-

- (1) such rights of drainage over the drainage easements shown on the plan (if any) as passing through such lot as may be necessary to drain the stormwater and other surplus water from any other lot on the plan; and
- (2) any easements or profits a prendre described hereunder.

The direction of the flow of water through the drainage easements shown on the plan is indicated by arrows.

Fencing Provision In respect of each Lot on the Plan

The Owner Peter Norman Porch shall not be required to fence.

Signed by the Registered Proprietor of land

contained in Certificate of Title Volume ~~20784~~ Folio 1



Peter Norman Porch

123934

*574
17/11/25

In the presence of: (signed)

Name

Address

Occupation

Dianne Margaret Clark


92 Linden Rd Pinrose Sands, TAS 7173

Administration

*574 17/11/25

*574 17/11/25
Sebastian Thomas-
Subdivider Langer

(USE ANNEXURE PAGES FOR CONTINUATION)
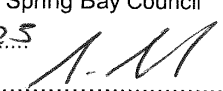
<p>SUBDIVIDER: P N Porch</p> <p>FOLIO REF: CT 123934-1</p> <p>SOLICITOR & REFERENCE: TIERNEY LAW</p>	<p>PLAN SEALED BY: Glamorgan Spring Bay Council</p> <p>DATE: 17/07/2025</p> <p>SA2022/48</p> <p>REF NO.</p> <p align="right">  Council Delegate </p>
<p>NOTE: The Council Delegate must sign the Certificate for the purposes of identification.</p>	

DA
TASMANIAN PLANNING SCHEME

SHEET INDEX

1	COVER SHEET
2	SITE PLAN 1:200
3	SITE PLAN 1:250
4	SOIL & WATER MANAGEMENT PLAN
5	GROUND FLOOR PLAN
6	ELEVATIONS / SECTION
7	ELEVATIONS
8	WINDOW & DOOR SCHEDULES
9	CALCULATIONS
10	DETAILS (CLADDING)
11	ROOF DRAINAGE PLAN
12	FLOOR COVERINGS
13	KITCHEN DETAILS
14	BATHROOM DETAILS
15	LAUNDRY DETAILS
16	3D VIEWS
17	GENERAL NOTES
18	WET AREA & ENERGY EFFICIENCY NOTES
19	BUILDING ACT BUSHFIRE HAZARD AREAS
20	BAL 12.5 NOTES
21	BAL 12.5 - BAL 40 ROOF DETAILS

TOTAL FLOOR AREAS

MAIN DWELLING, GROUND FLOOR		
LIVING		106.87
PORCH		2.10
		108.98 m²

ON SITE WASTEWATER
TREATMENT REQUIRED. REFER
TO REPORT PREPARED BY
GES (TBC)

ON SITE STORMWATER
MANAGEMENT.
REFER TO REPORT PREPARED BY
GES/FLUSSIG (TBC)

AS & NCC COMPLIANCE

- ALL CONSTRUCTION TO BE IN ACCORDANCE WITH NCC 2022 AND APPLICABLE AUSTRALIAN STANDARDS AT TIME OF APPROVAL.
- SLAB IN ACCORDANCE WITH AS 2870. REFER TO ENGINEERS DETAILS FOR ALL SLAB DETAILS.
 - BRICK CONTROL JOINTS PROVIDED IN ACCORDANCE WITH NCC 2022.
 - ALL STEEL FRAMING TO BE DESIGNED TO AS 4100-2020 OR AS/NZS 4600-2018.
 - INSULATION TO BE INSTALLED IN ACCORDANCE WITH NCC 2022 AND ALL APPLICABLE AUSTRALIAN STANDARDS.
 - TERMITE PROTECTION IN ACCORDANCE WITH AS 3660 AND NCC 2022.
 - GLAZING IN ACCORDANCE WITH AS 1288 AND NCC 2022.
 - SMOKE ALARMS IN ACCORDANCE WITH AS 3786 AND NCC 2022.
 - INTERNAL WATERPROOFING IN ACCORDANCE WITH NCC 2022 HOUSING PROVISIONS PART 10.2.
 - EXTERNAL WATERPROOFING IN ACCORDANCE WITH AS 3740 AND AS 4654.
 - WET AREA FLOORS TO FALL TO FLOOR WASTES AT MIN. 1:80 AND MAX. 1:50 GRADE (IF APPLICABLE).
 - CONDENSATION MANAGEMENT IN ACCORDANCE WITH NCC 2019.
 - BUILDING SEALING IN ACCORDANCE WITH NCC 2022.
 - SERVICES IN ACCORDANCE WITH NCC 2022.
 - EARTHWORKS IN ACCORDANCE WITH AS 3798-2007.
 - EXTERNAL WALL WRAP (SARKING) IN ACCORDANCE WITH NCC 2022 (IF APPLICABLE).
 - EXHAUST FANS DUCTED TO OUTSIDE AIR (IF APPLICABLE).


SITE SPECIFIC CONTROLS

CONTROL	DETAILS
ACID SULPHATE SOIL	NO
BIODIVERSITY	NO
BUILDING ENVELOPE	NO
BUSHFIRE	BAL-12.5
CLIMATE ZONE (NCC)	ZONE 7 - COOL TEMPERATE
DESIGN WIND CLASSIFICATION	N3 (EXPOSED TBC)
ESTATE/DEVELOPER GUIDELINES	NO
FLOOD OVERLAY	NO
HERITAGE	NO
LANDSLIP HAZARD	NO
MINIMUM FLOOR LEVEL	NO
NATURAL ASSET CODE	NO
NOISE ATTENUATION	NO
SALINE SOIL	NO
SHIELDING FACTOR	PS - PARTIAL SHIELDING
SITE CLASSIFICATION	A
SPECIFIC AREA PLAN OVERLAY	NO
TERRAIN CATEGORY	TC2
TOPOGRAPHIC CLASSIFICATION	T3
WATERWAY & COASTAL OVERLAY	NO
WIND REGION	A - NORMAL
WITHIN 1km CALM SALT WATER	NO
WITHIN 50km BREAKING SURF	20.00km
ZONING	VILLAGE
CROWN LAND	

BUILDING CONTROLS & COMPLIANCE

CONTROL	REQUIRED	PROPOSED
SETBACKS		
FRONT	MIN. 4,500mm	10,542mm
SIDE A	MIN. 3,000mm	1,590mm
SIDE B	MIN. 3,000mm	4,900mm
REAR	MIN. 3,000mm	42,003mm
BULK & SCALE		
SITE AREA	1,271m²	
SITE COVERAGE	MAX. 50%	8.57%
LANDSCAPE		
NO APPLICABLE CONTROLS		
EARTHWORKS		
CUT DEPTH	MAX. 2,000mm	14mm
FILL DEPTH	MAX. 800mm	341mm
ACCESS & AMENITY		
PARKING SPACES	MIN. 2 SPACES	2 SPACES


3D PERSPECTIVE

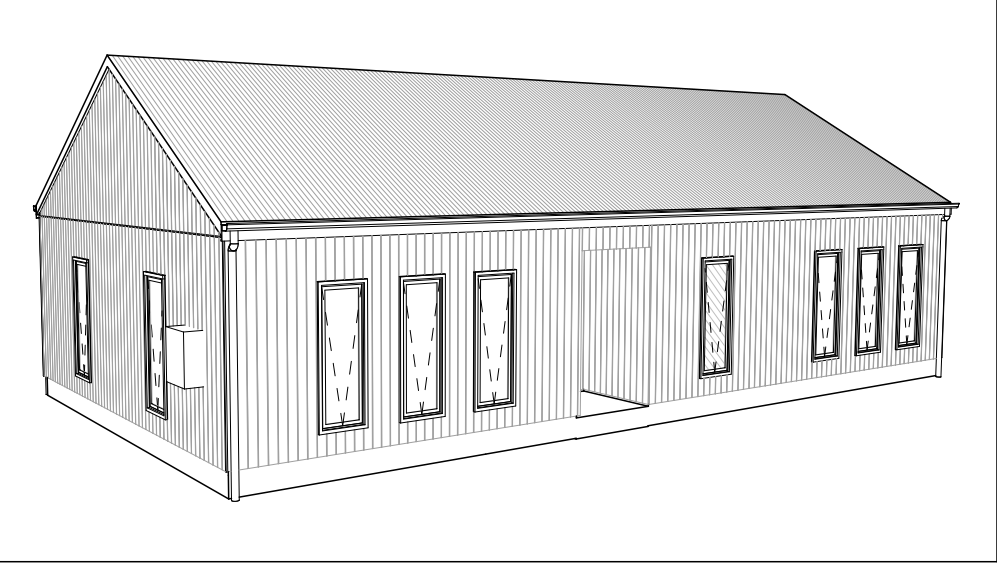

NOTE TO OWNER

THESE PLANS MAY FEATURE WORKS THAT ARE EXCLUDED FROM THE SCOPE OF WORKS WITH THE BUILDER, BUT THEY HAVE BEEN INCLUDED IN THESE DRAWINGS TO ASSIST IN THE OVERALL PLANNING AND ASSESSMENT OF THE BUILDING PROJECT. EXAMPLES OF SOME REGULARLY EXCLUDED WORKS INCLUDE DRIVEWAYS, RETAINING WALLS, SOLAR PANEL SPACING AND SITE DRAINAGE. PLEASE REFER TO YOUR SCOPE OF WORKS AND COLOUR SELECTIONS DOCUMENTATION FOR DETAILS OF INCLUDED WORKS. SOME DETAILS ARE INDICATIVE ONLY FOR EXAMPLE FLOORING, TILING, BRICKWORK AND CLADDING (EXPANSION JOINTS, ORIENTATION AND LAYOUT) AND ARE SUBJECT TO CHANGE.

LOCATION MAP

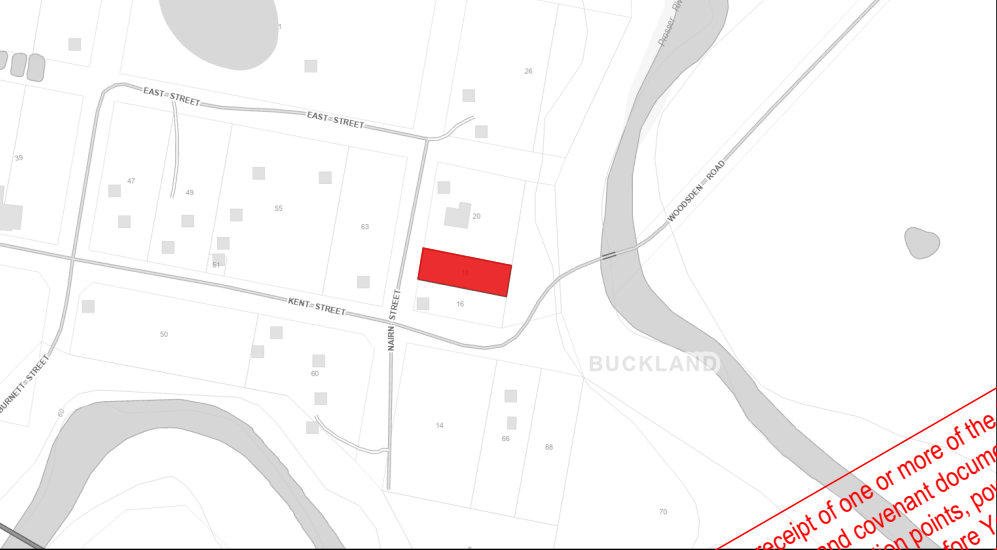

This Plan has been prepared prior to the receipt of one or more of the following documents:-
Certificate of Title inclusive of lot specific zoning, easement and covenant documents, BAL report and rating, approved subdivision plans providing crossover locations and service connection points, power and communications connection point information, Geotechnical Site Investigation, Contour Survey, Dial Before You Dig Information, Planning Approval.

BUILDING INFORMATION

GROUND FLOOR TOP OF WALL HEIGHT(S)	2595mm
NOTE: CEILING HEIGHT 45mm LOWER THAN TOP OF WALL	
ROOF PITCH (U.N.O.)	30.0°
ELECTRICITY SUPPLY	SINGLE PHASE
GAS SUPPLY	NONE
ROOF MATERIAL	SHEET METAL
ROOF COLOUR	DARK
WALL MATERIAL	BRICK VENEER CLADDING
SLAB CLASSIFICATION	TBC

INSULATION

ROOF	MIN. 50mm FOIL FACED BLANKET UNDER ROOFING
CEILING	R4.1 BATTS (EXCL. GARAGE, ALFRESCO & PATIO)
EXT. WALLS	R2.0 BATTS (EXCL. GARAGE) WALL WRAP TO ENTIRE HOUSE
INT. WALLS	R2.0 BATTS ADJACENT TO GARAGE AND AS PER PLAN
FLOOR	BIAX SLAB R0.60

NCC 2022 LIVABLE HOUSING COMPLIANCE

- ACCESSIBLE SANITARY COMPARTMENT: BATH
ACCESSIBLE SHOWER LOCATION: BATH
- GENERAL NOTES:**
- THRESHOLD OF ACCESSIBLE SHOWER ENTRY TO BE MAX. 5MM
 - 1 EXTERIOR DOOR NOMINATED AS 870 OR GREATER TO ACHIEVE MIN 820MM CLEAR OPENING
 - REFER TO APPLICABLE WET AREA PLANS AND INTERIOR ELEVATIONS OR LOCATIONS OF REQUIRED WALL REINFORCEMENT FOR FUTURE GRAB RAIL INSTALLATION.

BUSHFIRE REQUIREMENTS - BAL-12.5

THE BUILDER USES MATERIALS THAT COMPLY WITH AS 3959-2018 OR HAVE BEEN TESTED TO AS 1530.8.1 IN ACCORDANCE WITH AS 3959-2018 (CLAUSE 3.8).

ROOF:

- PROVIDE FOIL FACED BLANKET INSULATION TO ALL COLORBOND SHEET ROOFING.
- PROVIDE SARKING TO ALL TILED ROOFING INCLUDING PRESSTITE TO VALLEYS.
- PROVIDE BAL-12.5 RATED DEKTITE TO ALL AIR VENTS ON ROOF.
- PROVIDE BAL-12.5 RATED ALUMINIUM MESH TO ALL SOFFIT AND EAVE VENTS.
- PROVIDE BAL-12.5 RATED ALUMINIUM MESH TO ALL EXHAUST VENTS.

WALLS, POSTS AND BEAMS:

- PROVIDE SPARK ARRESTORS TO ALL EXTERNAL BRICKWORK.
- EXTERNAL TIMBER POSTS WITHIN 400mm OF ADJACENT FINISHED FLOOR LEVEL TO BE BUSHFIRE-RESISTING TIMBER UNLESS MOUNTED ON STIRRUPS TO PROVIDE MIN. 75mm CLEARANCE ABOVE ADJACENT FINISHED FLOOR LEVEL.

WINDOWS AND DOORS:

- PROVIDE FLYSCREENS WITH CORROSION RESISTANT MESH TO ALL OPERABLE WINDOW SASHES (NO REQUIREMENT TO SCREEN BI-FOLD / FRENCH / SLIDING / STACKER DOORS).
- PROVIDE BAL-12.5 RATED ALUMINIUM WINDOWS AND EXTERNAL GLASS SLIDING / STACKER DOORS.
- SPECIFIED ALUMINIUM FRENCH DOORS HAVE BEEN TESTED TO AS 1530.8.1 WITHOUT SCREENS.
- SPECIFIED ALUMINIUM WINDOWS HAVE BEEN TESTED TO AS 1530.8.1 WITHOUT SCREENS TO FIXED PANELS.
- PROVIDE ALUMINIUM DOOR JAMBS TO ALL EXTERNAL TIMBER DOORS.
- PROVIDE SAFETY SCREENS WITH CORROSION RESISTANT MESH TO EXTERNAL TIMBER HUNG DOORS (IF REQUIRED).
- PROVIDE SEAL TO ALL GARAGE PANELIFT / ROLLER DOORS.


OTHER:

- PROVIDE COPPER WATER PIPES FROM WATER TANK TO HOUSE.

PRELIMINARY PLAN SET

5	PRELIMINARY PLAN SET - AMEND DRIVEWAY NOTE	ALL	2025.12.11	PL1	-
4	PRELIMINARY PLAN SET - COLOUR UPDATE	ALL	2025.12.09	TDI	-
3	PRELIMINARY PLAN SET - INITIAL ISSUE	ALL	2025.11.02	TDI	-
No.	AMENDMENT	SHEET	DATE	DRAWN	CHECK

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	SPECIFICATION:		REVISION	DRAWN		CLIENT:		HOUSE DESIGN:		HOUSE CODE:		DO NOT SCALE DRAWINGS. USE FIGURED DIMENSIONS ONLY. CHECK AND VERIFY DIMENSIONS AND LEVELS PRIOR TO THE COMMENCEMENT OF ANY WORK. ALL DISCREPANCIES TO BE REPORTED TO THE DRAFTING OFFICE.
	BARN HOUSE	1	DRAFT SALE PLAN - CT1	HMI	06/10/2025			BARN HOUSE 10B		H-WBH10B10SA		
	COPYRIGHT:	2	CT1 - AMENDMENT	HMI	06/10/2025	ADDRESS:		FACADE DESIGN:		FACADE CODE:		
	© 2025	3	PRELIM PLANS - INITIAL ISSUE	TDI	02/11/2025	18 NAIRN ST, BUCKLAND TAS 7190		BARN		F-WBH10B10BARN A		
		4	PRELIM PLANS - COLOUR UPDATE	TDI	09/12/2025	LOT / SECTION / CT:	COUNCIL:	SHEET TITLE:	SHEET No.:	SCALES:		
		5	PRELIM PLANS - AMENDMENTS	PL1	11/12/2025	185631 / - / 2	GLAMORGAN SPRING BAY	COVER SHEET	1 / 21		714463	

REFER TO SHEET 1 (COVER SHEET) FOR ALL BUILDING INFORMATION REGARDING:




- SUSTAINABILITY REQUIREMENTS
- SITE CLASSIFICATION
- GENERAL BUILDING INFORMATION

APPROX. CUT/FILL		
CUT	0.05m³	0.11t
FILL	22.81m³	51.32t
DIFFERENCE	22.76m³	51.21t
51 TONNES OF IMPORT FILL		

LOT SIZE:	1271m²
HOUSE (COVERED AREA):	108.98m²
SITE COVERAGE:	8.57%

BAL-12.5 BUSHFIRE REQUIREMENTS
SEE SHEET 1 (COVER SHEET) FOR DETAILS

PLANS ARE PRELIMINARY ONLY
PENDING ENGINEER'S DESIGN

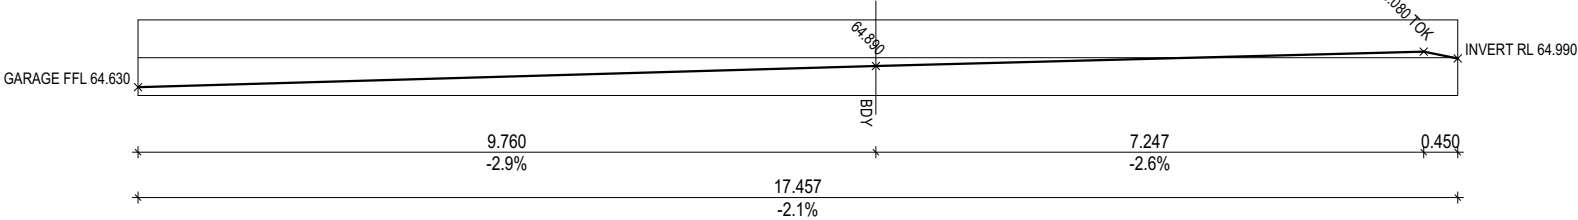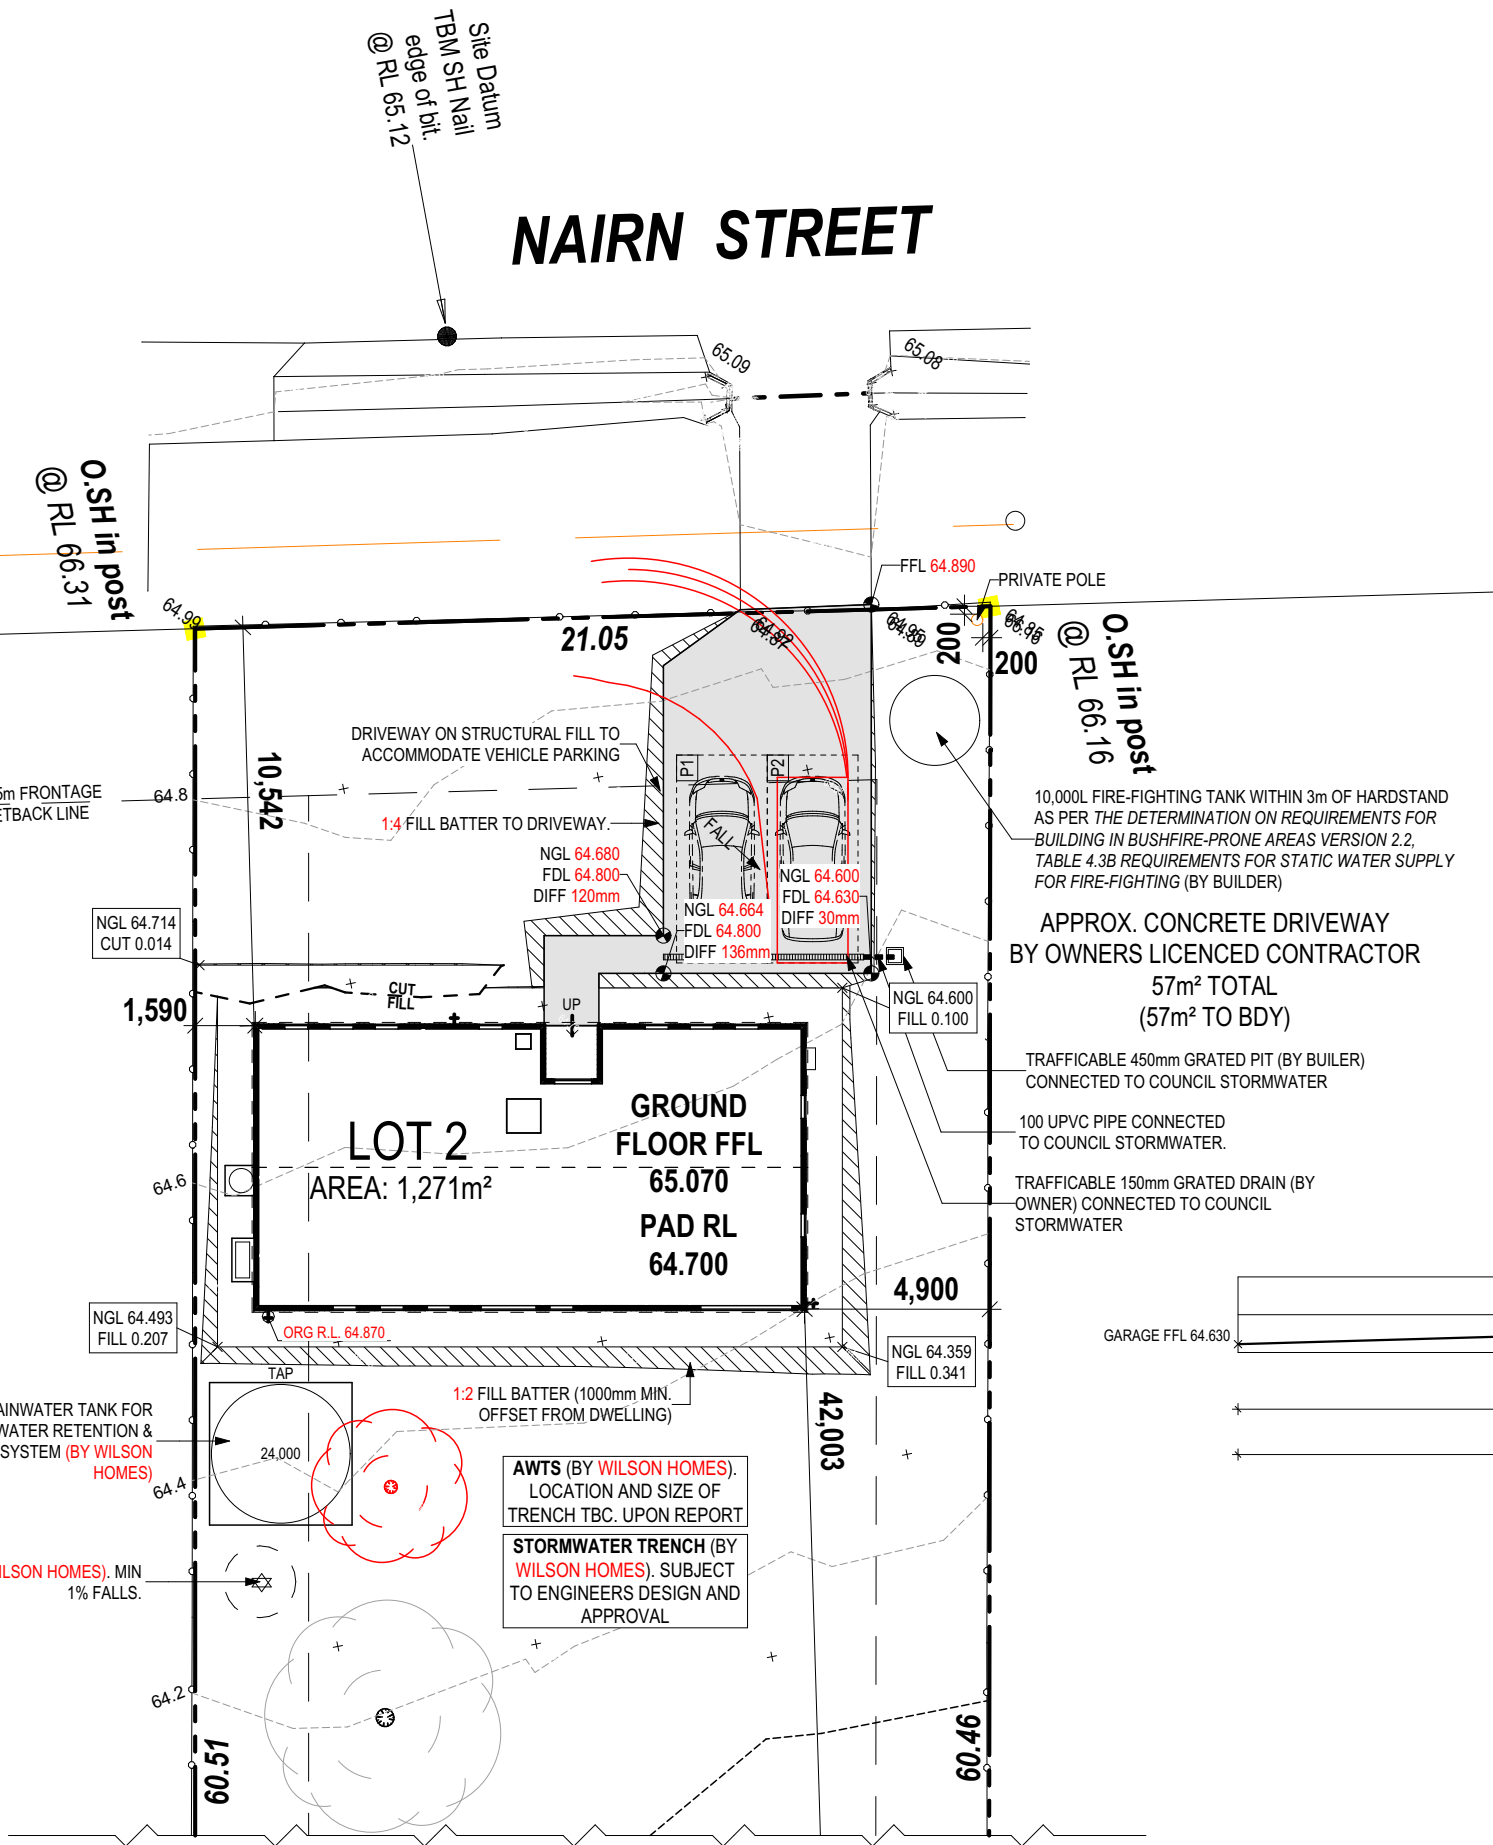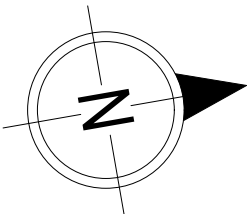

SUBJECT TO NCC 2022
(1 MAY 2023)
WATERPROOFING & PLUMBING

PLAN ACCEPTANCE BY OWNER

SIGNATURE: DATE:

SIGNATURE: DATE:

PLEASE NOTE THAT VARIATIONS WILL NOT BE ACCEPTED
AFTER THIS PLAN ACCEPTANCE HAS BEEN SIGNED

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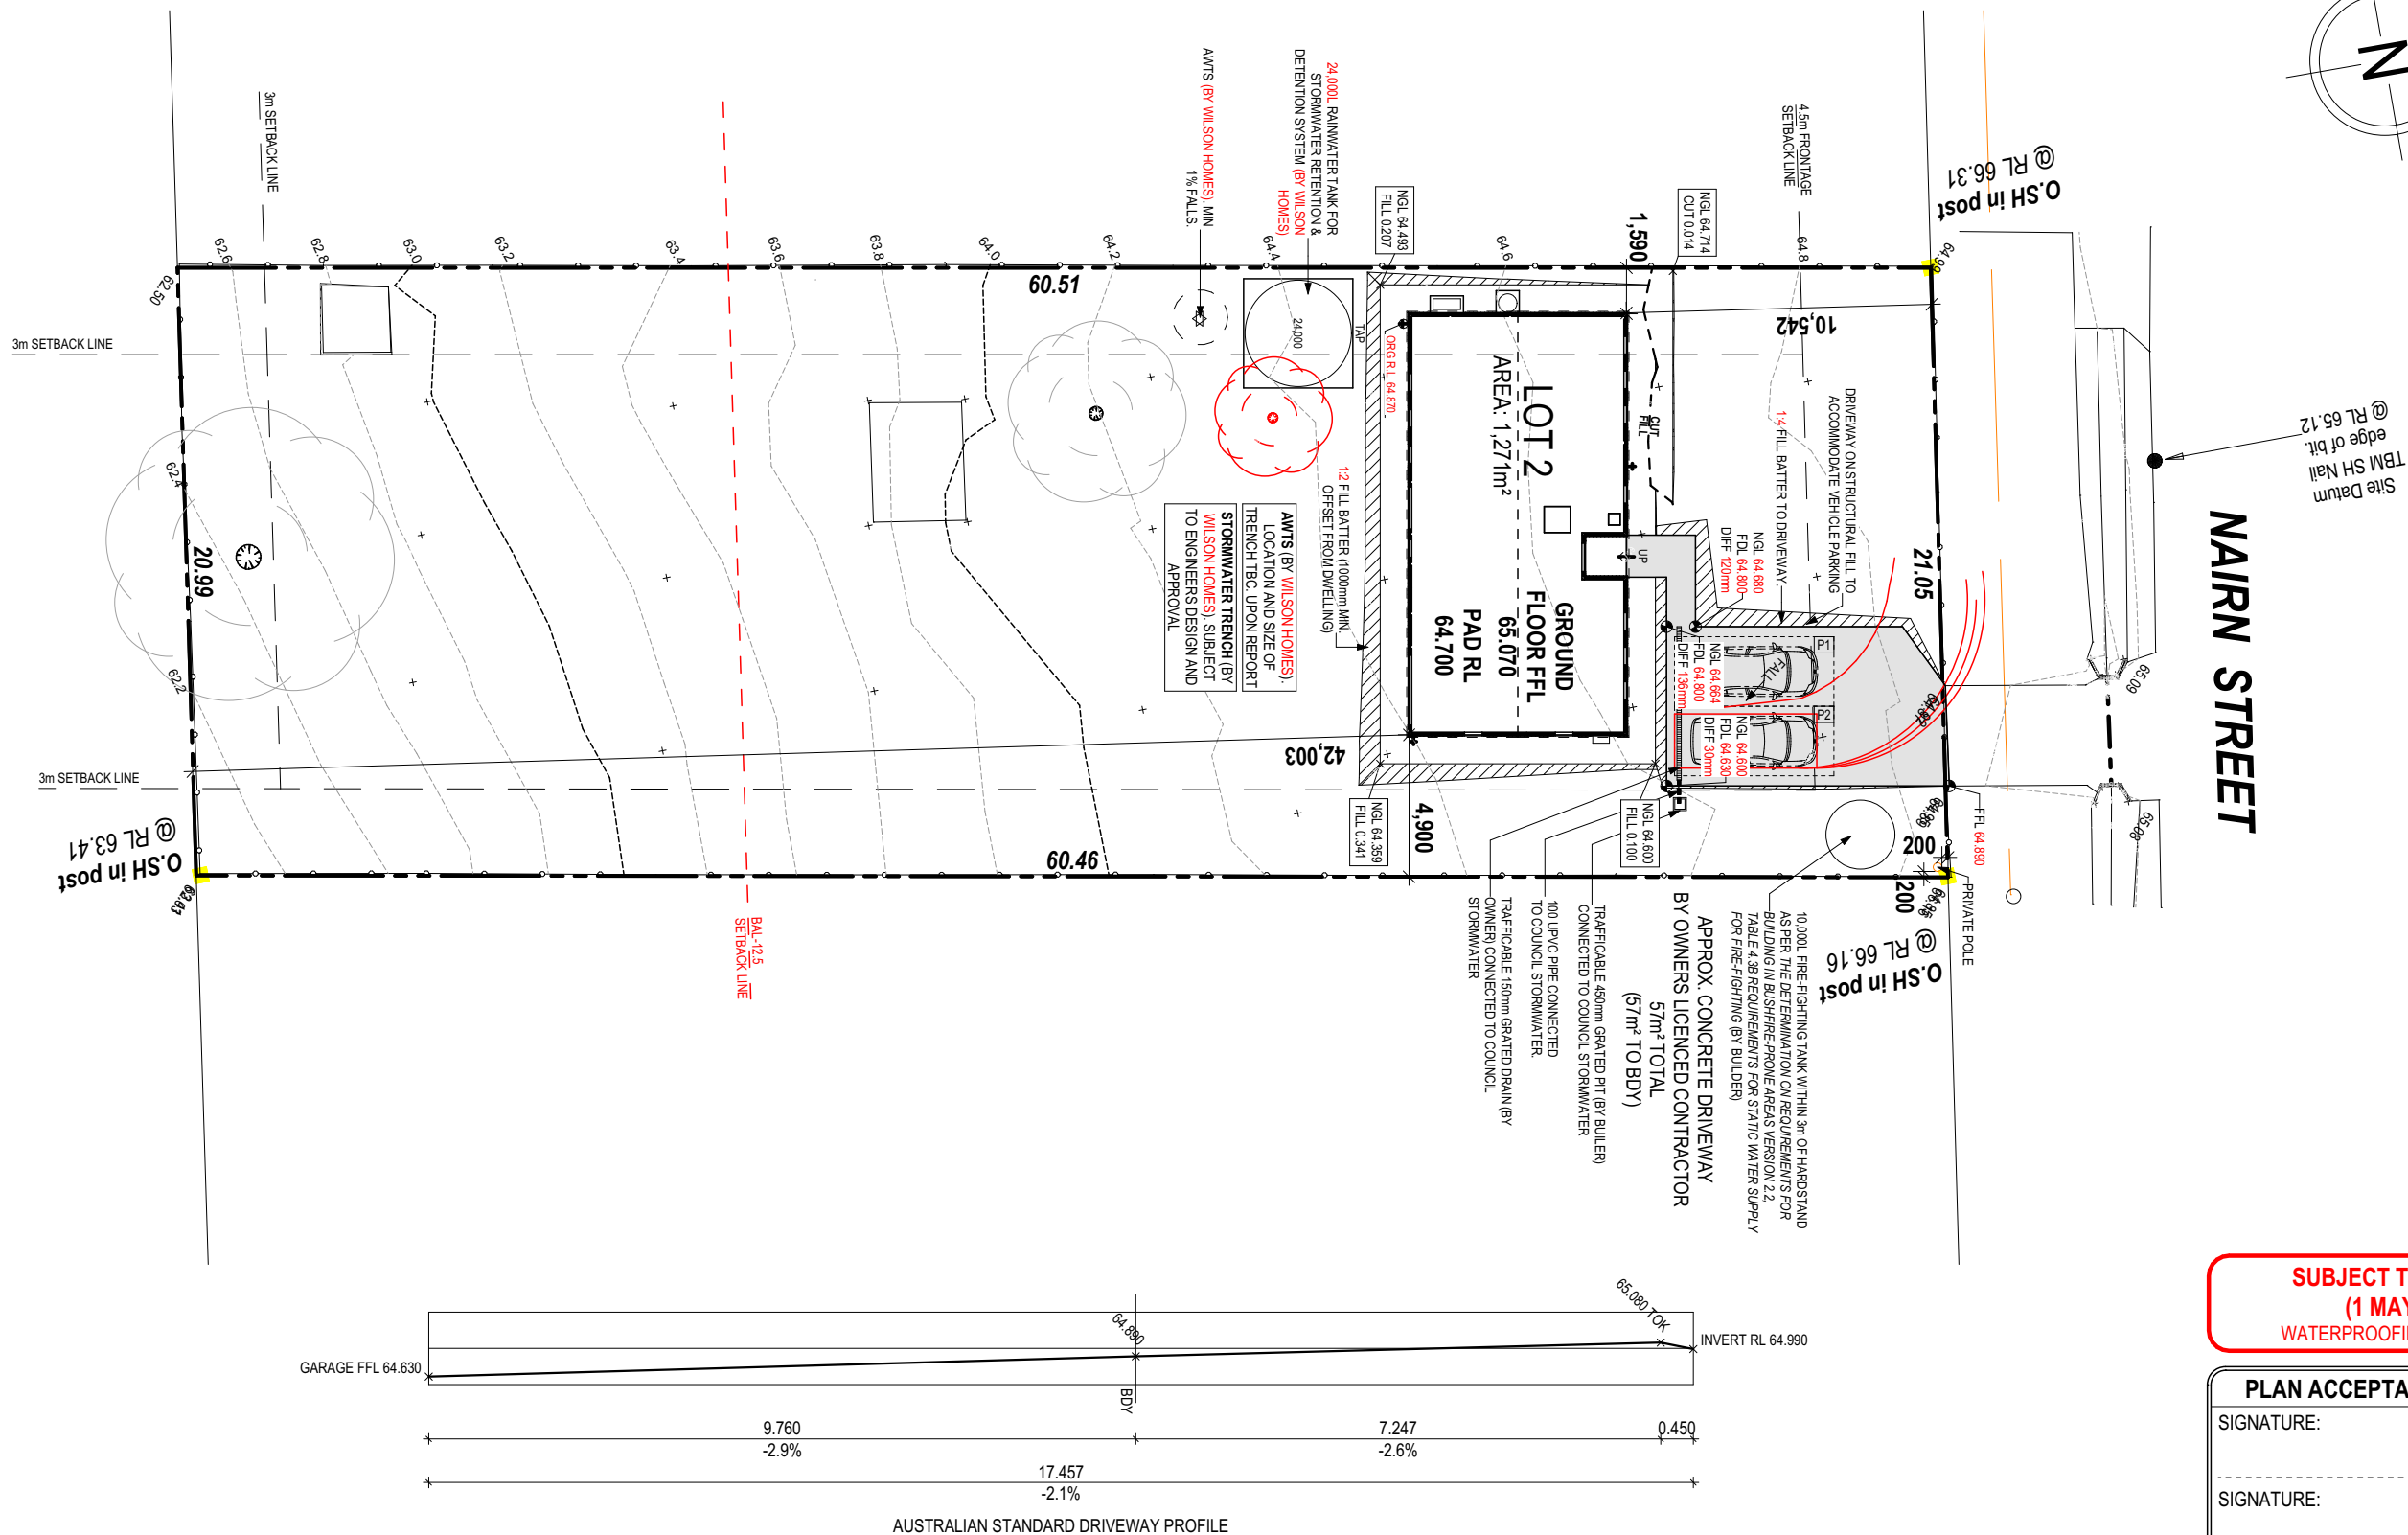
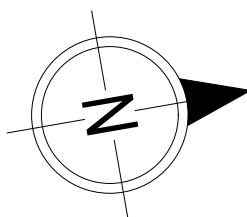


SPECIFICATION: BARN HOUSE COPYRIGHT: © 2025	REVISION		DRAWN		CLIENT: ADDRESS: 18 NAIRN ST, BUCKLAND TAS 7190 LOT / SECTION / CT: 185631 / - / 2 COUNCIL: GLAMORGAN SPRING BAY	HOUSE DESIGN: BARN HOUSE 10B FACADE DESIGN: BARN SHEET TITLE: SITE PLAN 1:200	HOUSE CODE: H-WBH10B10SA FACADE CODE: F-WBH10B10BARNAB SHEET No.: 2 / 21 SCALES: 1:200	DO NOT SCALE DRAWINGS. USE FIGURED DIMENSIONS ONLY. CHECK AND VERIFY DIMENSIONS AND LEVELS PRIOR TO THE COMMENCEMENT OF ANY WORK. ALL DISCREPANCIES TO BE REPORTED TO THE DRAFTING OFFICE. 714463
	1	DRAFT SALE PLAN - CT1	HMI	06/10/2025				
	2	CT1 - AMENDMENT	HMI	06/10/2025				
	3	PRELIM PLANS - INITIAL ISSUE	TDI	02/11/2025				
	4	PRELIM PLANS - COLOUR UPDATE	TDI	09/12/2025				
	5	PRELIM PLANS - AMENDMENTS	PL1	11/12/2025				

APPROX. CUT/FILL		
CUT	0.05m ³	0.11
FILL	22.81m ³	51.32
DIFFERENCE	22.76m ³	51.21
51 TONNES OF IMPORT FILL		

BAL-12.5 BUSHFIRE REQUIREMENTS
SEE SHEET 1 (COVER SHEET) FOR DETAILS

**PLANS ARE PRELIMINARY ONLY
PENDING ENGINEER'S DESIGN**



**SUBJECT TO NCC 2022
(1 MAY 2023)**
WATERPROOFING & PLUMBING

PLAN ACCEPTANCE BY OWNER

SIGNATURE: _____ DATE _____

SIGNATURE: _____ DATE _____

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BARN HOUSE	1	DRAFT SALE PLAN - CT1		HMI	06/10/2025			BARN HOUSE 10B		H-WBH10B10SA		
COPYRIGHT:	2	CT1 - AMENDMENT		HMI	06/10/2025	ADDRESS:		FACADE DESIGN:		FACADE CODE:		
© 2025	3	PRELIM PLANS - INITIAL ISSUE		TDI	02/11/2025	18 NAIRN ST, BUCKLAND TAS 7190		BARN		F-WBH10B10BARN		
	4	PRELIM PLANS - COLOUR UPDATE		TDI	09/12/2025	LOT / SECTION / CT:		SHEET TITLE:		SHEET No.:		
	5	PRELIM PLANS - AMENDMENTS		PL1	11/12/2025	185631 / - / 2		GLAMORGAN SPRING BAY		SITE PLAN 1:250		714463
										1:250		





OWNER TO STABILISE THE SITE ON COMPLETION OF THE BUILD WITH TURF LAWNS, GRASS SEEDS, NATIVE GROUND COVERS AND/ OR MULCH SPREAD TO A DEPTH OF 75-100mm

THE FOLLOWING IS A STANDARD APPROACH. SEDIMENT AND EROSION CONTROL MEASURES WILL BE REVIEWED PRIOR TO COMMENCING WORK AND INSTALLED BASED ON THE OUTCOME OF THAT REVIEW.

NOTES:

1. ALL EROSION AND SEDIMENT CONTROL STRUCTURES TO BE INSPECTED EACH WORKING DAY AND MAINTAINED IN GOOD WORKING ORDER.
2. ALL GROUND COVER VEGETATION OUTSIDE THE IMMEDIATE BUILDING AREA TO BE PRESERVED DURING THE BUILDING PHASE.
3. ALL EROSION AND SEDIMENT CONTROL MEASURES TO BE INSTALLED PRIOR TO COMMENCEMENT OF MAJOR EARTHWORKS.
4. STOCKPILES OF CLAYEY MATERIAL TO BE COVERED WITH AN IMPERVIOUS SHEET.
5. ROOF WATER DOWNPIPES TO BE CONNECTED TO THE PERMANENT UNDERGROUND STORMWATER DRAINAGE SYSTEM AS SOON AS PRACTICAL AFTER THE ROOF IS LAID.

6. DIVERSION DRAINS ARE TO BE CONNECTED TO A LEGAL DISCHARGE POINT (COUNCIL STORMWATER SYSTEM, WATERCOURSE OR ROAD DRAIN).
7. SEDIMENT RETENTION TRAPS INSTALLED AROUND THE INLETS TO THE STORMWATER SYSTEM TO PREVENT SEDIMENT & OTHER DEBRIS BLOCKING THE DRAINS.

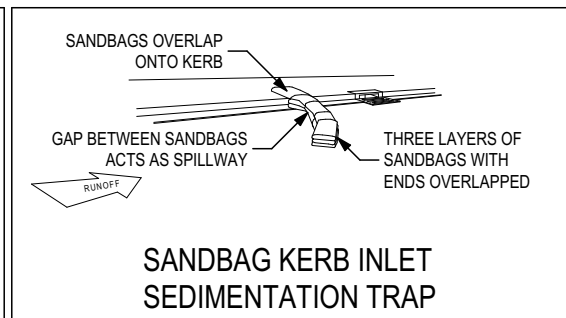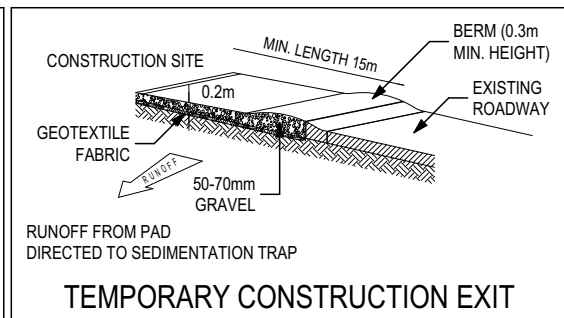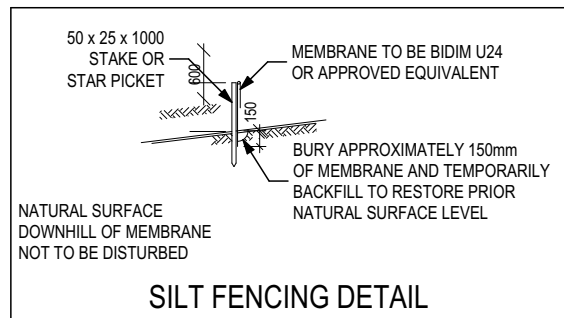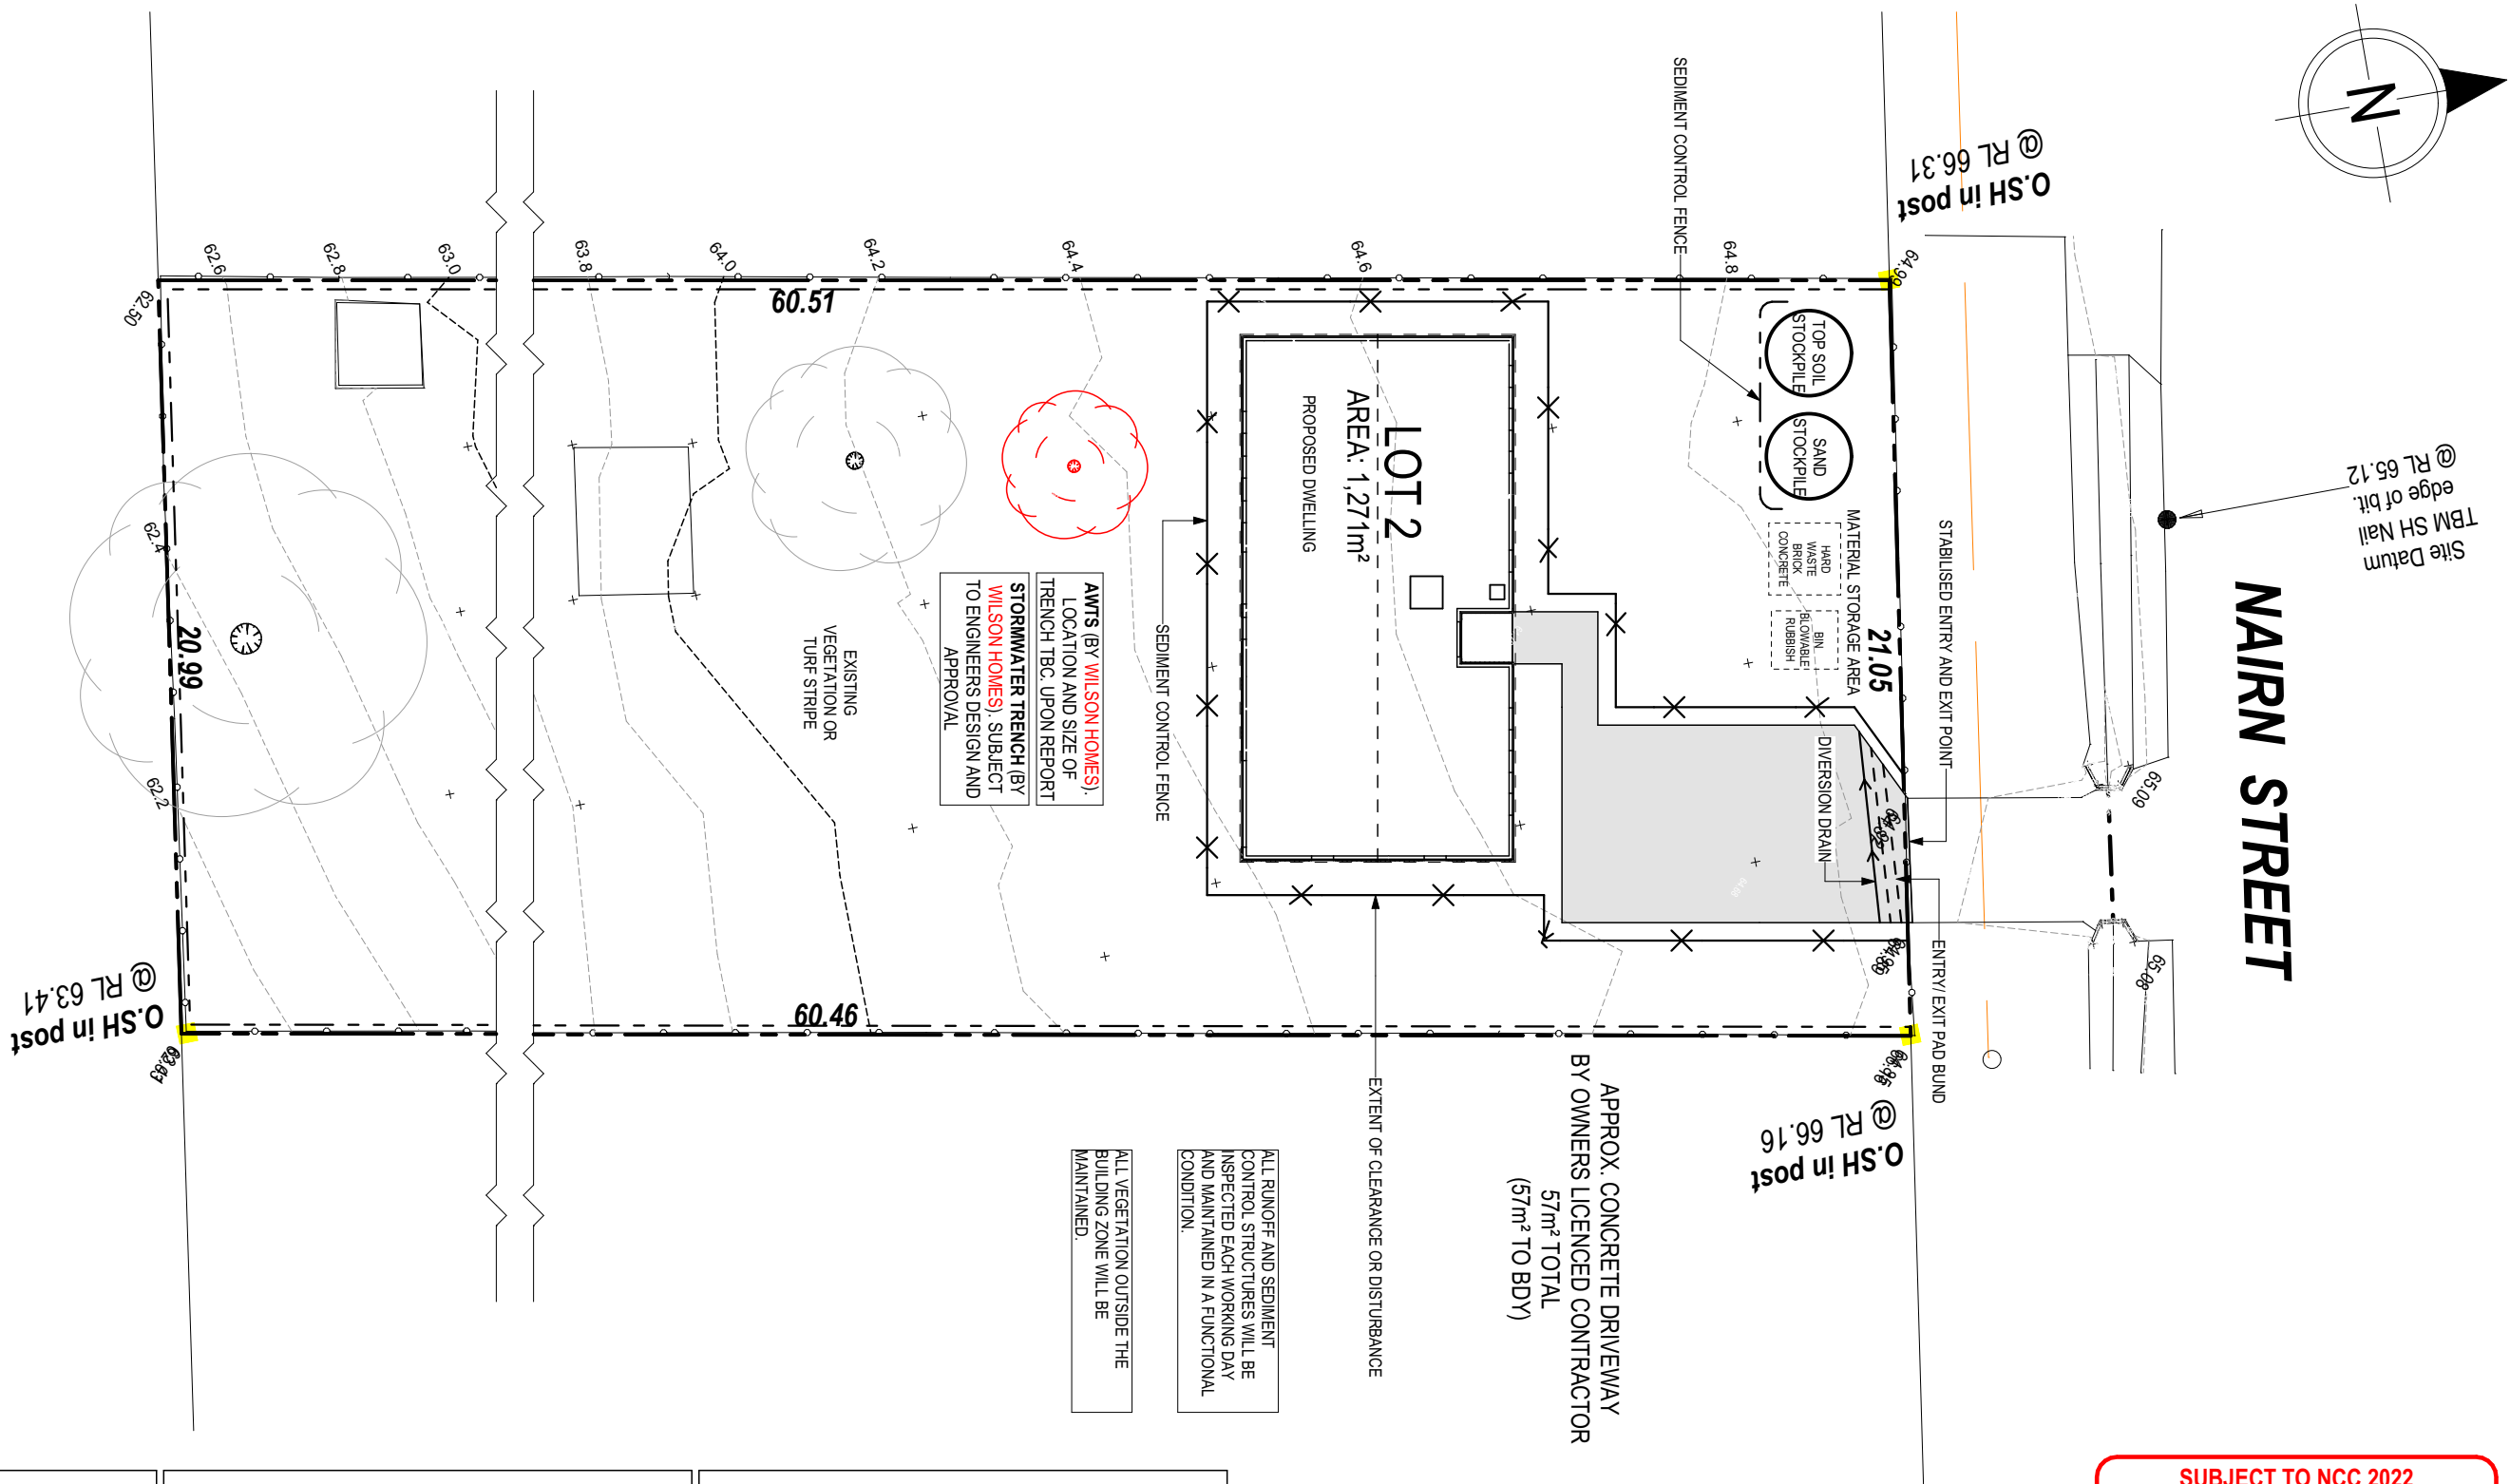

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(1 MAY 2023)
WATERPROOFING & PLUMBING**

PLAN ACCEPTANCE BY OWNER


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SIGNATURE: _____ DATE: _____


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BARN HOUSE	1	DRAFT SALE PLAN - CT1		HMI	06/10/2025				BARN HOUSE 10B			H-WBH10B10SA		
COPYRIGHT:	2	CT1 - AMENDMENT		HMI	06/10/2025	ADDRESS:			FACADE DESIGN:			FACADE CODE:		
© 2025	3	PRELIM PLANS - INITIAL ISSUE		TDI	02/11/2025	18 NAIRN ST, BUCKLAND TAS 7190			BARN			F-WBH10B10BARNA		
	4	PRELIM PLANS - COLOUR UPDATE		TDI	09/12/2025	LOT / SECTION / CT:		COUNCIL:		SHEET TITLE:		SHEET No.:	SCALES:	
	5	PRELIM PLANS - AMENDMENTS		PL1	11/12/2025	185631 / - / 2		GLAMORGAN SPRING BAY		SOIL & WATER MANAGEMENT PLAN		4 / 21	1:200	714463


BAL-12.5 BUSHFIRE REQUIREMENTS
SEE SHEET 1 (COVER SHEET) FOR DETAILS



NORTH ELEVATION
SCALE: 1:100

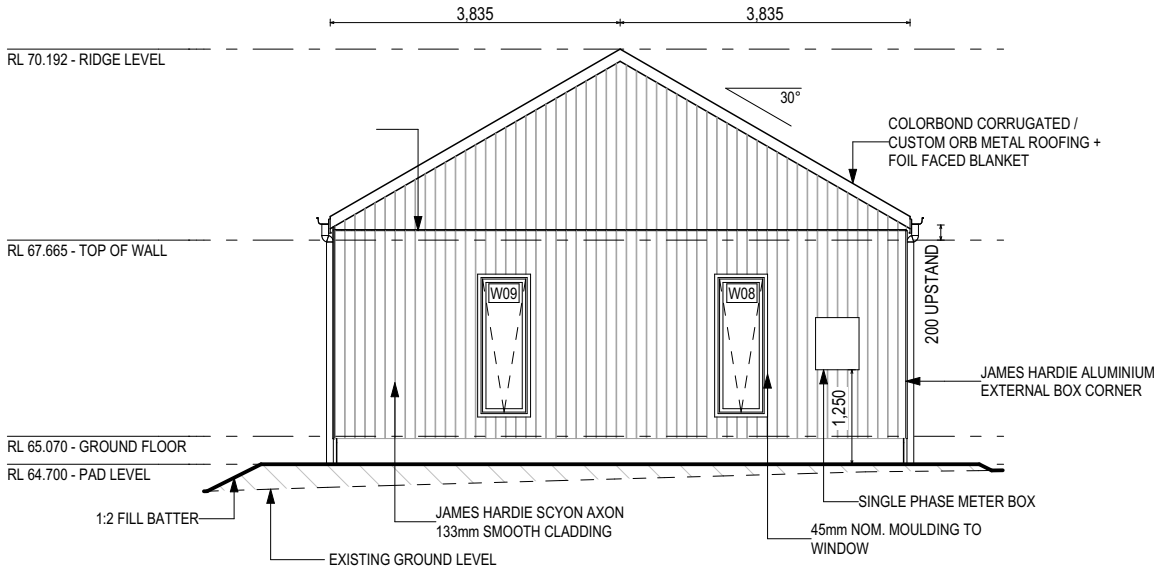


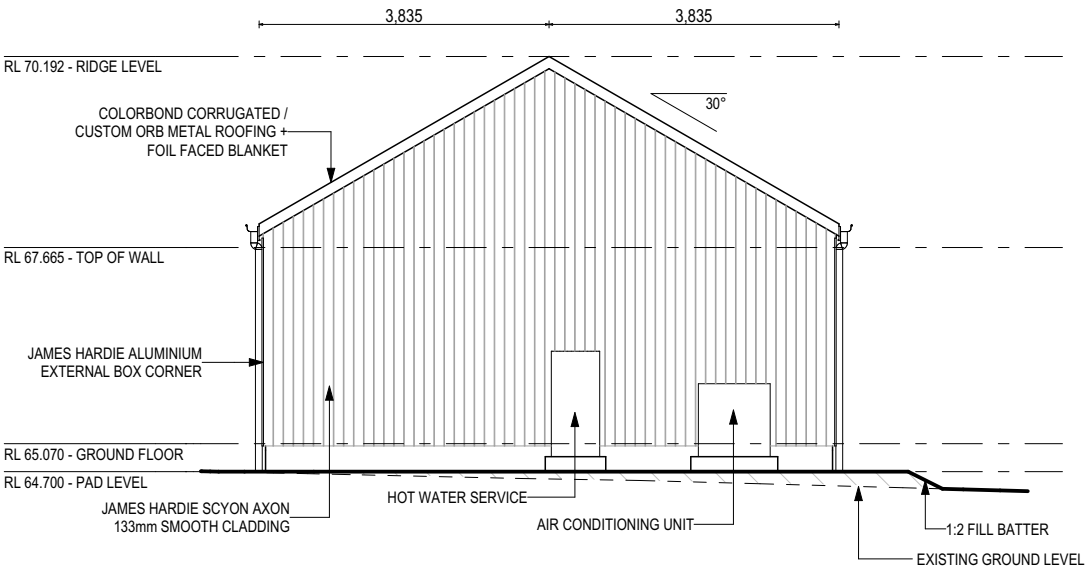SOUTH ELEVATION
SCALE: 1:100

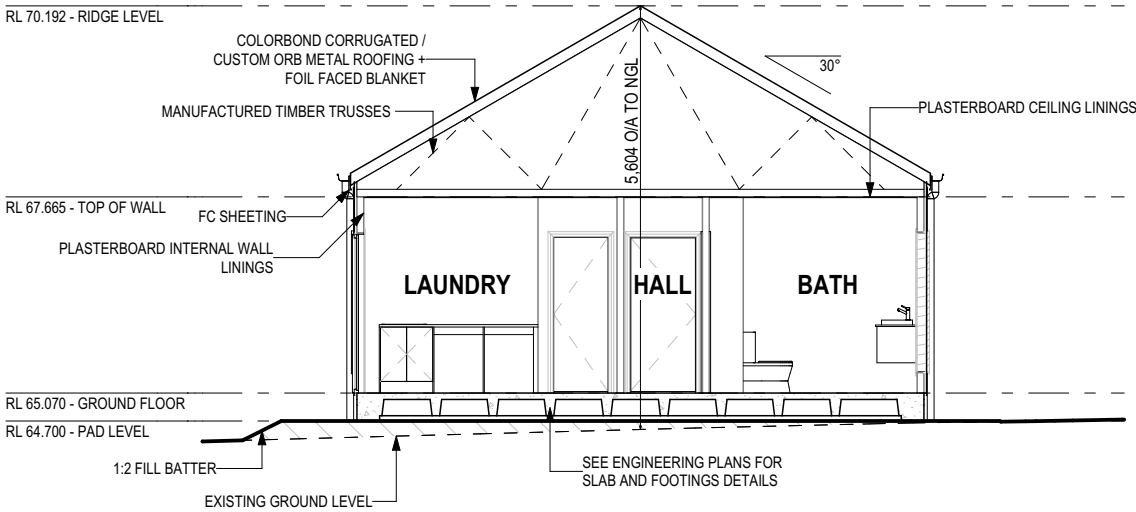


SECTION A-A
SCALE: 1:100

GLASS TYPE LEGEND

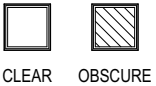

WINDOW TYPE LEGEND

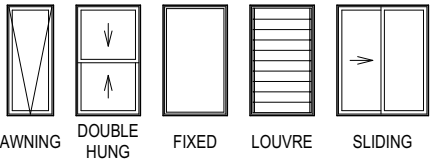

SUBJECT TO NCC 2022
(1 MAY 2023)
WATERPROOFING & PLUMBING

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COPYRIGHT: © 2025	1 DRAFT SALE PLAN - CT1	HMI 06/10/2025	ADDRESS: 18 NAIRN ST, BUCKLAND TAS 7190	FACADE DESIGN: BARN	FACADE CODE: F-WBH10B10BARN	
	2 CT1 - AMENDMENT	HMI 06/10/2025	LOT / SECTION / CT: 185631 / - / 2	SHEET TITLE: ELEVATIONS / SECTION	SHEET No.: 6 / 21	
	3 PRELIM PLANS - INITIAL ISSUE	TDI 02/11/2025	COUNCIL: GLAMORGAN SPRING BAY		SCALES: 1:100	
	4 PRELIM PLANS - COLOUR UPDATE	TDI 09/12/2025				
	5 PRELIM PLANS - AMENDMENTS	PL1 11/12/2025				

BAL-12.5 BUSHFIRE REQUIREMENTS
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- SUSTAINABILITY REQUIREMENTS
- SITE CLASSIFICATION
- GENERAL BUILDING INFORMATION


SOME DETAILS ON THIS SHEET ARE INDICATIVE ONLY FOR EXAMPLE BRICKWORK AND CLADDING (EXPANSION JOINTS, ORIENTATION AND LAYOUT) AND ARE SUBJECT TO CHANGE.

SH = SNAP HEADER SILL


BEDROOM WINDOW OPENINGS ABOVE 2m OFF THE SURFACE BENEATH TO BE RESTRICTED AS REQUIRED BY NCC 11.3.7 (VOLUME TWO)

ROOMS OTHER THAN BEDROOM WINDOW OPENINGS ABOVE 4m OFF THE SURFACE BENEATH TO BE RESTRICTED AS REQUIRED BY NCC 11.3.7 (VOLUME TWO)

REFER TO THE FOLLOWING DETAILS:
BRICK COURSING W-BRIC-001

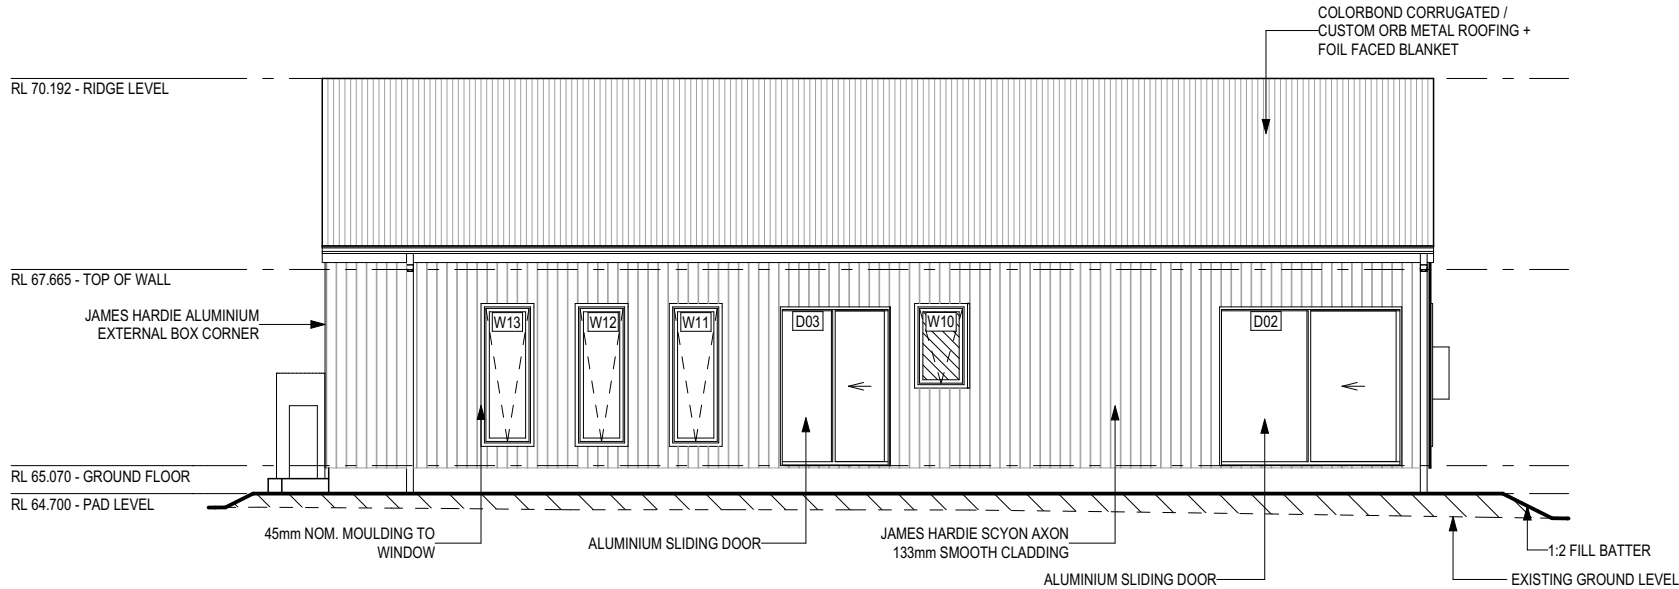


EAST ELEVATION
SCALE: 1:100

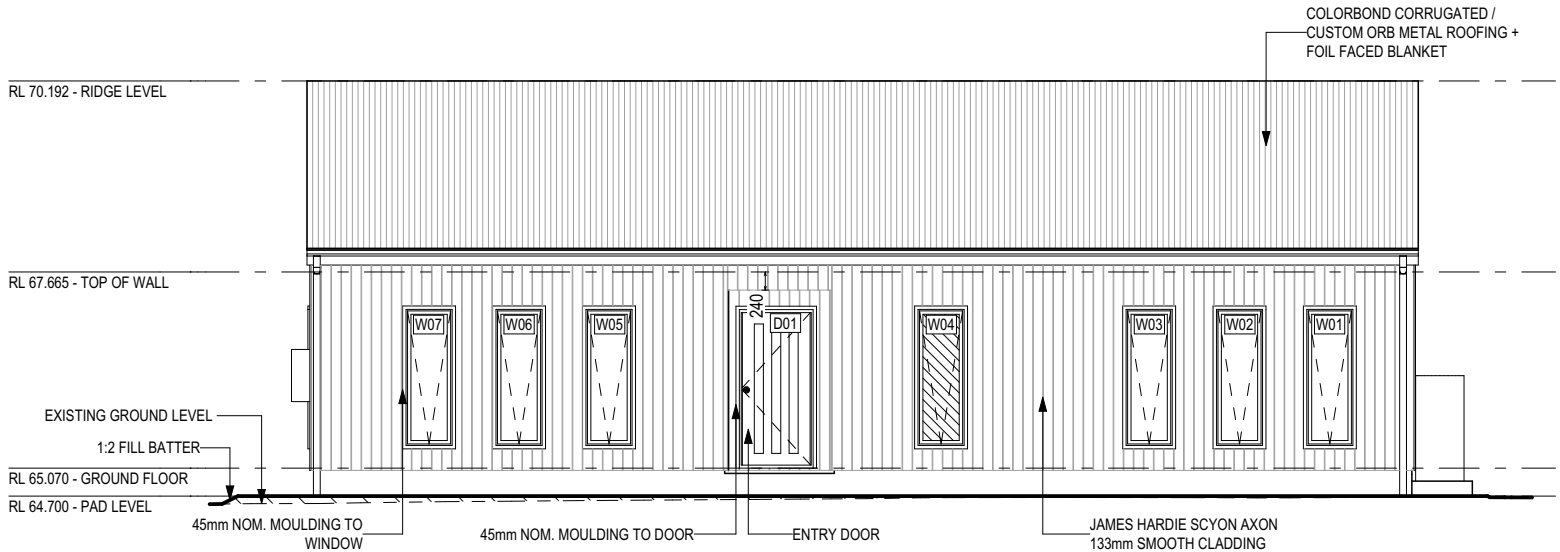


WEST ELEVATION
SCALE: 1:100

SUBJECT TO NCC 2022
(1 MAY 2023)
WATERPROOFING & PLUMBING

GLASS TYPE LEGEND

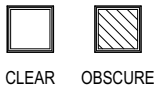

WINDOW TYPE LEGEND

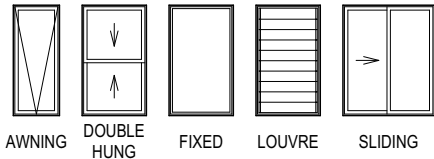

PLAN ACCEPTANCE BY OWNER

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COPYRIGHT: © 2025	1 DRAFT SALE PLAN - CT1	HMI 06/10/2025	ADDRESS: 18 NAIRN ST, BUCKLAND TAS 7190	FACADE DESIGN: BARN	FACADE CODE: F-WBH10B10BARN	
	2 CT1 - AMENDMENT	HMI 06/10/2025		SHEET TITLE: ELEVATIONS	SHEET No.: 7 / 21	
	3 PRELIM PLANS - INITIAL ISSUE	TDI 02/11/2025	LOT / SECTION / CT: 185631 / - / 2		SCALES: 1:100	
	4 PRELIM PLANS - COLOUR UPDATE	TDI 09/12/2025	COUNCIL: GLAMORGAN SPRING BAY			
	5 PRELIM PLANS - AMENDMENTS	PL1 11/12/2025				

EXTERIOR WINDOW & DOOR SCHEDULE 1,2 ASSUME LOOKING FROM OUTSIDE

	STOREY	ID	CODE¹	TYPE	ROOM	HEIGHT	WIDTH	PERIMETER	AREA (m²)	FRAME TYPE	BAL RATING	SILL TYPE	ORIENT.	GLAZING AREA (m²)	GLAZING TYPE (SINGLE GLAZING U.N.O.)	ADDITIONAL INFORMATION²
WINDOW																
	GROUND FLOOR	W01	A1806	AWNING	BED 1	1,800	610	4,820	1.10	ALUMINIUM	BAL-12.5	NONE	W	0.81	CLEAR, DOUBLE GLAZED	
	GROUND FLOOR	W02	A1806	AWNING	BED 1	1,800	610	4,820	1.10	ALUMINIUM	BAL-12.5	NONE	W	0.81	CLEAR, DOUBLE GLAZED	
	GROUND FLOOR	W03	A1806	AWNING	BED 1	1,800	610	4,820	1.10	ALUMINIUM	BAL-12.5	NONE	W	0.81	CLEAR, DOUBLE GLAZED	
	GROUND FLOOR	W04	A1806	AWNING	BATH	1,800	610	4,820	1.10	ALUMINIUM	BAL-12.5	NONE	W	0.81	OBSCURE, DOUBLE GLAZED, TOUGHENED	
	GROUND FLOOR	W05	A1806	AWNING	LIVING	1,800	610	4,820	1.10	ALUMINIUM	BAL-12.5	NONE	W	0.81	CLEAR, DOUBLE GLAZED	
	GROUND FLOOR	W06	A1806	AWNING	LIVING	1,800	610	4,820	1.10	ALUMINIUM	BAL-12.5	NONE	W	0.81	CLEAR, DOUBLE GLAZED	
	GROUND FLOOR	W07	A1806	AWNING	LIVING	1,800	610	4,820	1.10	ALUMINIUM	BAL-12.5	NONE	W	0.81	CLEAR, DOUBLE GLAZED	
	GROUND FLOOR	W08	A1806	AWNING	LIVING	1,800	610	4,820	1.10	ALUMINIUM	BAL-12.5	NONE	N	0.81	CLEAR, DOUBLE GLAZED	
	GROUND FLOOR	W09	A1806	AWNING	DINING	1,800	610	4,820	1.10	ALUMINIUM	BAL-12.5	NONE	N	0.81	CLEAR, DOUBLE GLAZED	
	GROUND FLOOR	W10	A1006	AWNING	WC	1,029	610	3,278	0.63	ALUMINIUM	BAL-12.5	NONE	E	0.44	OBSCURE, DOUBLE GLAZED, TOUGHENED	
	GROUND FLOOR	W11	A1806	AWNING	BED 2	1,800	610	4,820	1.10	ALUMINIUM	BAL-12.5	NONE	E	0.81	CLEAR, DOUBLE GLAZED	
	GROUND FLOOR	W12	A1806	AWNING	BED 2	1,800	610	4,820	1.10	ALUMINIUM	BAL-12.5	NONE	E	0.81	CLEAR, DOUBLE GLAZED	
	GROUND FLOOR	W13	A1806	AWNING	BED 2	1,800	610	4,820	1.10	ALUMINIUM	BAL-12.5	NONE	E	0.81	CLEAR, DOUBLE GLAZED	
								61,118 mm	13.80					10.14		
DOOR																
	GROUND FLOOR	D01	920	SWINGING	ENTRY	2,097	976	6,146	2.05	ALUMINIUM	BAL-12.5	NONE	W	1.41	CLEAR	
	GROUND FLOOR	D02	FS2124	SLIDING	DINING	2,100	2,410	9,020	5.06	ALUMINIUM	BAL-12.5	NONE	E	4.51	CLEAR, TOUGHENED	ALI VIEW SECURITY SCREEN
	GROUND FLOOR	D03	FS2115	SLIDING	LDRY	2,100	1,450	7,100	3.05	ALUMINIUM	BAL-12.5	NONE	E	2.59	CLEAR, TOUGHENED	ALI VIEW SECURITY SCREEN
								22,266 mm	10.15					8.52		
								83,384 mm	23.96					18.66		

NOTE:
Provide BAL-12.5 rated aluminium windows and external glass sliding doors in lieu of standard.

Provide flyscreens with corrosion resistant mesh to all opening window sashes only.

Window Manufacturer: Dowell Windows

No BAL / BAL 12.5 Window Type Sliding Window Awning Window Fixed External Window Sliding Door Stacking Door Hinged Door Bi-Fold Door	WERS Code	U Value	SHGC
	DOW-022-003	2.9	0.64
	DOW-005-001	3.9	0.58
	DOW-038-001	3.03	0.71
	DAR-034-001	3.97	0.63
	DAR-034-001	3.97	0.63
BAL 19 Window Type Sliding Window Awning Window Fixed External Window Sliding Door Stacking Door Hinged Door Bi-Fold Door	DOW-017-001	4.1	0.55
	DOW-020-001	4.1	0.54
	WERS Code	U Value	SHGC
	TND-034-001	3.1	0.61
	STG-001-066	3.91	0.54
	DOW-038-005	3.02	0.66
BAL 29 Window Type Sliding Window Awning Window Fixed External Window Sliding Door Stacking Door Hinged Door	AUW-009-009	4.03	0.58
	AUW-009-009	4.03	0.58
	GRN-009-001	4.25	0.53
	DOW-020-001	4.1	0.54
	WERS Code	U Value	SHGC
	TND-034-001	3.1	0.61
	STG-001-066	3.91	0.54
	DOW-038-005	3.02	0.66
	AMJ-007-005	4.03	0.59
	AMJ-007-005	4.03	0.59
	GRN-009-001	4.29	0.53

NOTE:
Windows supplied MUST HAVE Uw better and or equal to stated figures and SHGC within +/- 5% of stated figures. Restricted windows to have their openability restricted as per N.C.C 11.3.6.

INTERIOR WINDOW & DOOR SCHEDULE

	STOREY	QTY	CODE	TYPE	HEIGHT	WIDTH	GLAZING TYPE	ADDITIONAL INFORMATION
DOOR								
	GROUND FLOOR	1	1000 SS	SQUARE SET OPENING	2,100	1,000	N/A	
	GROUND FLOOR	2	720	SWINGING	2,040	720	N/A	
	GROUND FLOOR	1	770	SWINGING	2,040	770	N/A	
	GROUND FLOOR	1	820	SWINGING	2,040	820	N/A	LIFT-OFF HINGES
	GROUND FLOOR	3	820	SWINGING	2,040	820	N/A	
	GROUND FLOOR	1	870	SWINGING	2,040	870	N/A	
	GROUND FLOOR	1	870	SWINGING	2,040	870	N/A	LIFT-OFF HINGES

REFER TO SHEET 1 (COVER SHEET) FOR ALL BUILDING INFORMATION REGARDING:
- SUSTAINABILITY REQUIREMENTS
- SITE CLASSIFICATION
- GENERAL BUILDING INFORMATION

BAL-12.5 BUSHFIRE REQUIREMENTS
SEE SHEET 1 (COVER SHEET) FOR DETAILS

NOTE: INTERNAL DOORS TO WET AREAS WITH MECHANICAL VENTILATION TO BE UNDERCUT 20mm

PICTURE, TV RECESS AND SS WINDOW OPENINGS				
QTY	TYPE	HEIGHT	WIDTH	AREA (m²)

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SIGNATURE: DATE:

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SPECIFICATION: BARN HOUSE COPYRIGHT: © 2025		REVISION		DRAWN		CLIENT:		HOUSE DESIGN: BARN HOUSE 10B		HOUSE CODE: H-WBH10B10SA		DO NOT SCALE DRAWINGS. USE FIGURED DIMENSIONS ONLY. CHECK AND VERIFY DIMENSIONS AND LEVELS PRIOR TO THE COMMENCEMENT OF ANY WORK. ALL DISCREPANCIES TO BE REPORTED TO THE DRAFTING OFFICE. 714463
	1	DRAFT SALE PLAN - CT1		HMI	06/10/2025							
	2	CT1 - AMENDMENT		HMI	06/10/2025	ADDRESS: 18 NAIRN ST, BUCKLAND TAS 7190		FACADE DESIGN: BARN		FACADE CODE: F-WBH10B10BARN A		
	3	PRELIM PLANS - INITIAL ISSUE		TDI	02/11/2025							
	4	PRELIM PLANS - COLOUR UPDATE		TDI	09/12/2025	LOT / SECTION / CT: 185631 / - / 2		COUNCIL: GLAMORGAN SPRING BAY		SHEET TITLE: WINDOW & DOOR SCHEDULES		
	5	PRELIM PLANS - AMENDMENTS		PL1	11/12/2025					SHEET No.: 8 / 21	SCALES:	

NATURAL LIGHT AND VENTILATION

ROOM	AREA (m2)	WINDOW ID	LIGHT REQUIRED (m2)	LIGHT ACHIEVED (m2)	VENTILATION REQ'D (m2)	VENTILATION ACH'D (m2)
OPEN KITCHEN/ LIVING/ DINING	38.89 m²	W05, W06, W07, W08, W09, D02	3.89 m²	8.56 m²	1.94 m²	7.36 m²
BED 1	16.30 m²	W01, W02, W03	1.63 m²	2.43 m²	0.82 m²	3.00 m²
BED 2	14.40 m²	W11, W12, W13	1.44 m²	2.43 m²	0.72 m²	3.00 m²

PART 10.5.1 LIGHT: Minimum 10% of the floor area of a habitable room required (natural light)

PART 10.6 VENTILATION: Minimum 5% of the floor area of a habitable room required. (An exhaust fan may be used for sanitary compartment, laundry or bathroom provided contaminated air discharges directly to the outside of the building by way of ducts).

REFER TO SHEET 1 (COVER SHEET) FOR ALL BUILDING INFORMATION REGARDING:
- SUSTAINABILITY REQUIREMENTS
- SITE CLASSIFICATION
- GENERAL BUILDING INFORMATION

BAL-12.5 BUSHFIRE REQUIREMENTS
SEE SHEET 1 (COVER SHEET) FOR DETAILS

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SUBJECT TO NCC 2022
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PLAN ACCEPTANCE BY OWNER

SIGNATURE: _____ DATE: _____


SIGNATURE: _____ DATE: _____

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


SPECIFICATION: BARN HOUSE	REVISION	DRAWN	CLIENT:	HOUSE DESIGN: BARN HOUSE 10B	HOUSE CODE: H-WBH10B10SA	DO NOT SCALE DRAWINGS, USE FIGURED DIMENSIONS ONLY. CHECK AND VERIFY DIMENSIONS AND LEVELS PRIOR TO THE COMMENCEMENT OF ANY WORK. ALL DISCREPANCIES TO BE REPORTED TO THE DRAFTING OFFICE. 714463
COPYRIGHT: © 2025	1 DRAFT SALE PLAN - CT1	HMI 06/10/2025	ADDRESS: 18 NAIRN ST, BUCKLAND TAS 7190	FACADE DESIGN: BARN	FACADE CODE: F-WBH10B10BARN	
	2 CT1 - AMENDMENT	HMI 06/10/2025				
	3 PRELIM PLANS - INITIAL ISSUE	TDI 02/11/2025	LOT / SECTION / CT:	SHEET TITLE:	SHEET No.:	
	4 PRELIM PLANS - COLOUR UPDATE	TDI 09/12/2025	185631 / - / 2	GLAMORGAN SPRING BAY	9 / 21	
	5 PRELIM PLANS - AMENDMENTS	PL1 11/12/2025				

SHEET CLADDING

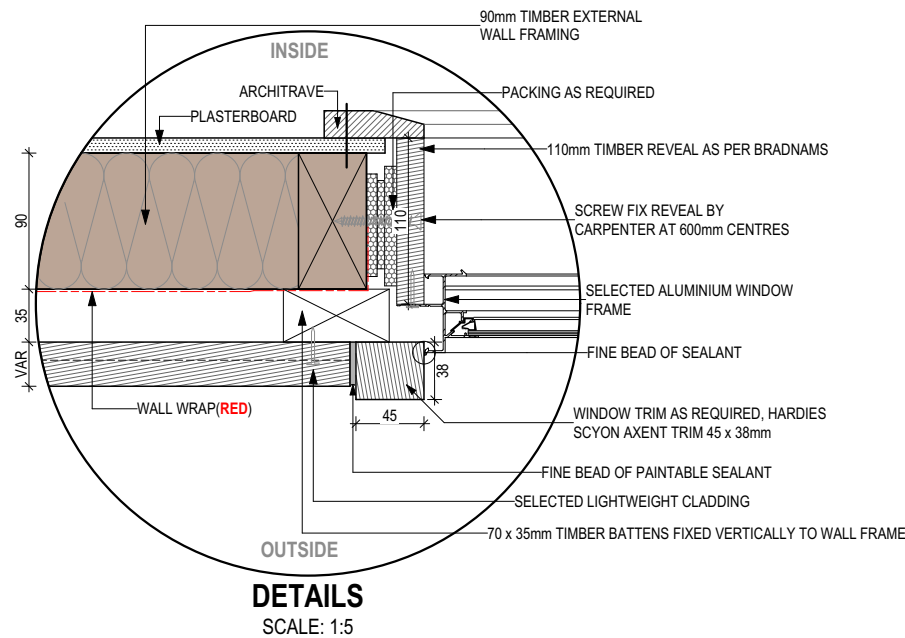

<b style="color: red;">SUBJECT TO NCC 2022 <b style="color: red;">(1 MAY 2023) <b style="color: red;">WATERPROOFING & PLUMBING	
PLAN ACCEPTANCE BY OWNER	
SIGNATURE:	DATE:
SIGNATURE:	DATE:
PLEASE NOTE THAT VARIATIONS WILL NOT BE ACCEPTED AFTER THIS PLAN ACCEPTANCE HAS BEEN SIGNED	

	SPECIFICATION:		REVISION		DRAWN		CI		HOUSE DESIGN:		HOUSE CODE:		DO NOT SCALE DRAWINGS, USE FIGURED DIMENSIONS ONLY. CHECK AND VERIFY DIMENSIONS AND LEVELS PRIOR TO THE COMMENCEMENT OF ANY WORK. ALL DISCREPANCIES TO BE REPORTED TO THE DRAFTING OFFICE.
	BARN HOUSE		1	DRAFT SALE PLAN - CT1	HMI	06/10/2025			BARN HOUSE 10B		H-WBH10B10SA		
	COPYRIGHT:		2	CT1 - AMENDMENT	HMI	06/10/2025	ADDRESS:		FACADE DESIGN:		FACADE CODE:		
	© 2025		3	PRELIM PLANS - INITIAL ISSUE	TDI	02/11/2025	18 NAIRN ST, BUCKLAND TAS 7190		BARN		F-WBH10B10BARN		
			4	PRELIM PLANS - COLOUR UPDATE	TDI	09/12/2025	LOT / SECTION / CT:		SHEET TITLE:		SHEET No.:	SCALES:	
		5	PRELIM PLANS - AMENDMENTS	PL1	11/12/2025	185631 / - / 2		COUNCIL:		10 / 21		714463	
						GLAMORGAN SPRING BAY		DETAILS (CLADDING)					

template Version: 24/041

WHERE DOWNPIPES ARE FURTHER THAN 1.2m AWAY FROM VALLEY REFER TO N.C.C. 7.3.5(2)

POSITION AND QUALITY OF DOWNPIPES ARE NOT TO BE ALTERED WITHOUT CONSULTATION WITH DESIGNER.



AREA'S SHOWN ARE SURFACE AREAS/ CATCHMENT AREAS, NOT PLAN AREAS

Roofing Data		
	112.75	Flat Roof Area (excluding gutter and slope factor) (m²)
	130.19	Roof Surface Area (includes slope factor, excludes gutter) (m²)
Downpipe roof calculations (as per AS/NZA3500.3:2021)		
Ah	120.01	Area of roof catchment (including 115mm Slotted Quad Gutter) (m²)
Ac	154.81	Ah x Catchment Area Multiplier for slope (Table 3.4.3.2 from AS/NZS 3500.3:2021) (1.29 for 30° pitch) (m²)
Ae	6300	Cross sectional area of 57 x 115 Slotted Quad Gutter (mm²)
DRI	108	Design Rainfall Intensity (determined from Table E1 from AS/NZS 3500.3:2021)
Acdp	64	Catchment area per Downpipe (determined from Figure 3.5(A) from AS/NZS 3500.3:2021) (m²)
Required Downpipes	2.42	Ac / Acdp
Downpipes Provided	4	

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BARN HOUSE		1	DRAFT SALE PLAN - CT1	HMI	06/10/2025			BARN HOUSE 10B		H-WBH10B10SA		
COPYRIGHT:		2	CT1 - AMENDMENT	HMI	06/10/2025	ADDRESS:		FACADE DESIGN:		FACADE CODE:		
© 2025		3	PRELIM PLANS - INITIAL ISSUE	TDI	02/11/2025	18 NAIRN ST, BUCKLAND TAS 7190		BARN		F-WBH10B10BARN		
		4	PRELIM PLANS - COLOUR UPDATE	TDI	09/12/2025	LOT / SECTION / CT:	COUNCIL:	SHEET TITLE:	SHEET No.:	SCALES:		
		5	PRELIM PLANS - AMENDMENTS	PL1	11/12/2025	185631 / - / 2	GLAMORGAN SPRING BAY	ROOF DRAINAGE PLAN	11 / 21	1:100	714463	



EV SOFFIT EAVE VENT PROPOSED LOCATION TO BE MIN. 1M FROM CORNER JOINT

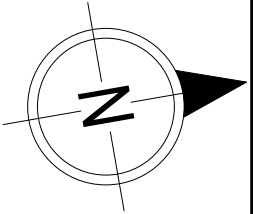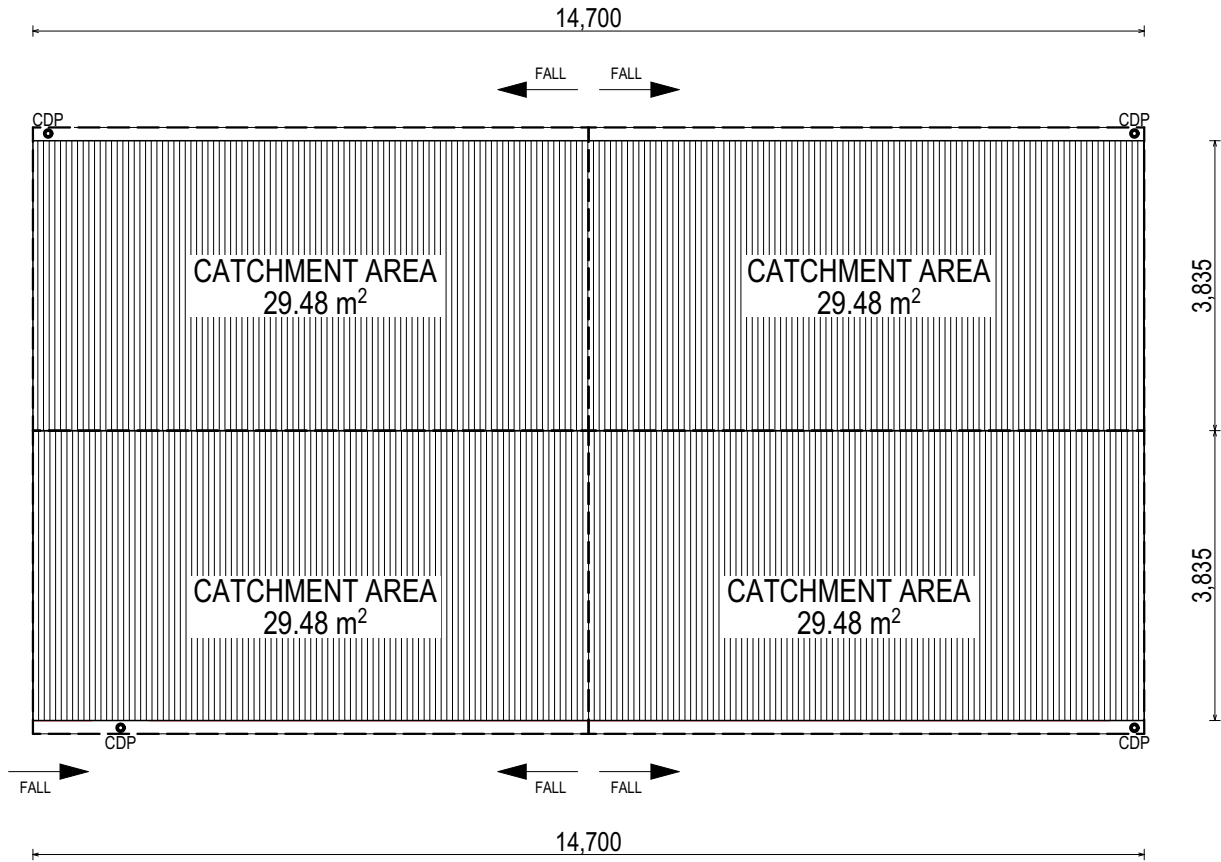**SUBJECT TO NCC 2022
(1 MAY 2023)
WATERPROOFING & PLUMBING**

PLAN ACCEPTANCE BY OWNER	
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SIGNATURE:	DATE:
PLEASE NOTE THAT VARIATIONS WILL NOT BE ACCEPTED AFTER THIS PLAN ACCEPTANCE HAS BEEN SIGNED	

REFER TO SHEET 1 (COVER SHEET) FOR ALL BUILDING INFORMATION REGARDING:

- SUSTAINABILITY REQUIREMENTS
- SITE CLASSIFICATION
- GENERAL BUILDING INFORMATION

FLOOR TILES SHOWN ON PLAN DO NOT INDICATE THE SIZE OR JOINT LOCATIONS OF THE ACTUAL FLOOR TILES.
TIMBER FLOORING SHOWN ON PLAN DOES NOT INDICATE THE BOARD SIZE OR DIRECTION OF THE ACTUAL FLOORING.

COVERINGS LEGEND

NO COVERING

COVER GRADE CONCRETE


CARPET

LAMINATE

TILE (STANDARD WET AREAS)

TILE (UPGRADED AREAS)

DECKING

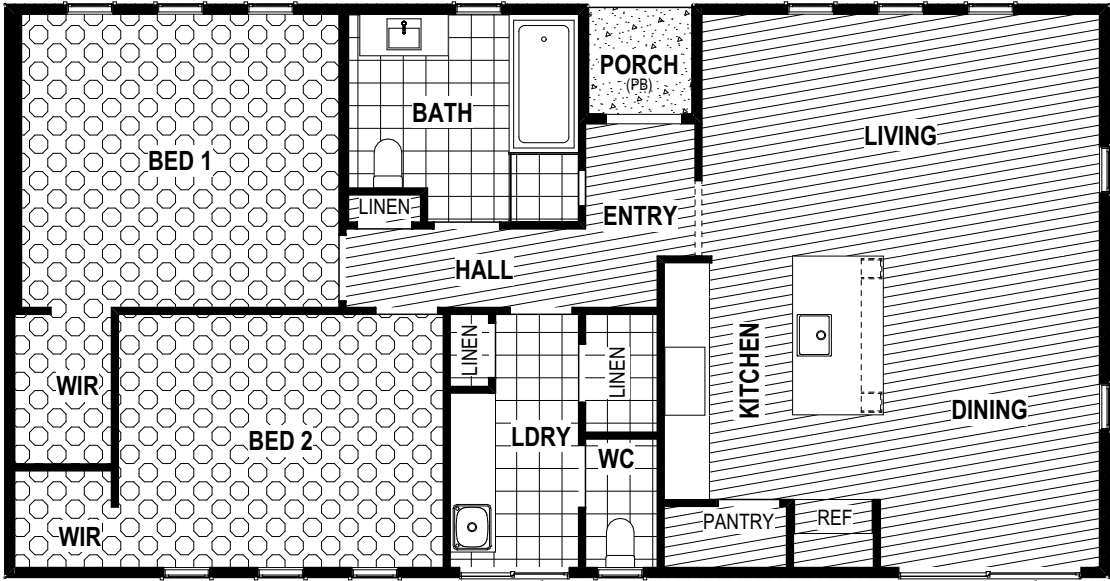

SUBJECT TO NCC 2022
(1 MAY 2023)
WATERPROOFING & PLUMBING

PLAN ACCEPTANCE BY OWNER

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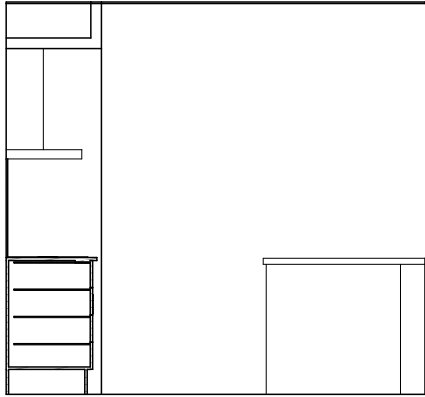
BAL-12.5 BUSHFIRE REQUIREMENTS
SEE SHEET 1 (COVER SHEET) FOR DETAILS

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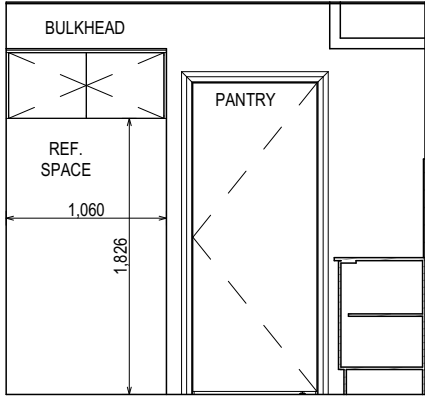


SPECIFICATION: BARN HOUSE		REVISION	DRAWN	CLIENT:	HOUSE DESIGN: BARN HOUSE 10B	HOUSE CODE: H-WBH10B10SA	DO NOT SCALE DRAWINGS, USE FIGURED DIMENSIONS ONLY. CHECK AND VERIFY DIMENSIONS AND LEVELS PRIOR TO THE COMMENCEMENT OF ANY WORK. ALL DISCREPANCIES TO BE REPORTED TO THE DRAFTING OFFICE. 714463
COPYRIGHT: © 2025	1	DRAFT SALE PLAN - CT1	HMI 06/10/2025	ADDRESS: 18 NAIRN ST, BUCKLAND TAS 7190	FACADE DESIGN: BARN	FACADE CODE: F-WBH10B10BARN	
	2	CT1 - AMENDMENT	HMI 06/10/2025	LOT / SECTION / CT: 185631 / - / 2	SHEET TITLE: FLOOR COVERINGS	SHEET No.: 12 / 21	
	3	PRELIM PLANS - INITIAL ISSUE	TDI 02/11/2025	COUNCIL: GLAMORGAN SPRING BAY		SCALES: 1:100	
	4	PRELIM PLANS - COLOUR UPDATE	TDI 09/12/2025				
	5	PRELIM PLANS - AMENDMENTS	PL1 11/12/2025				


BAL-12.5 BUSHFIRE REQUIREMENTS
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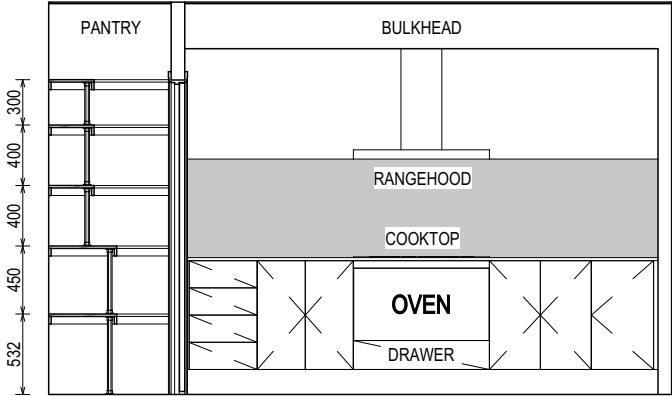
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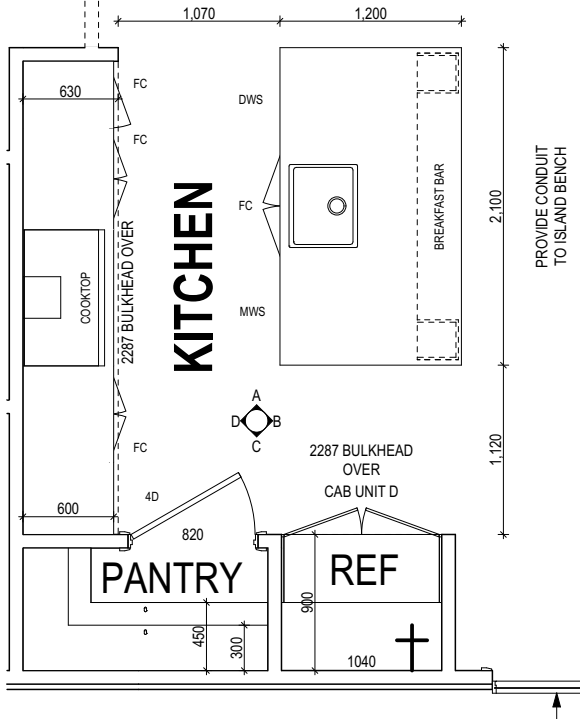
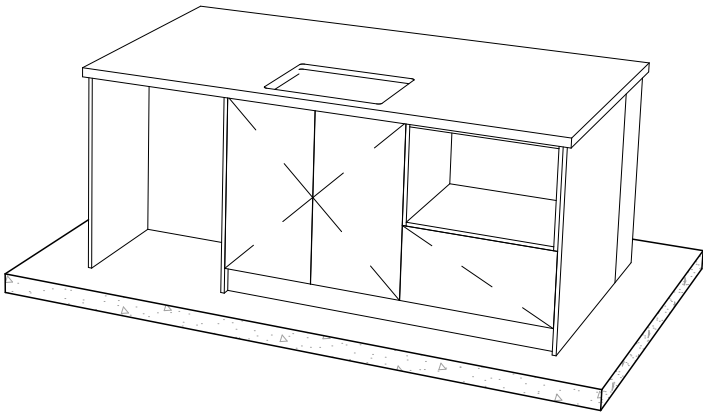
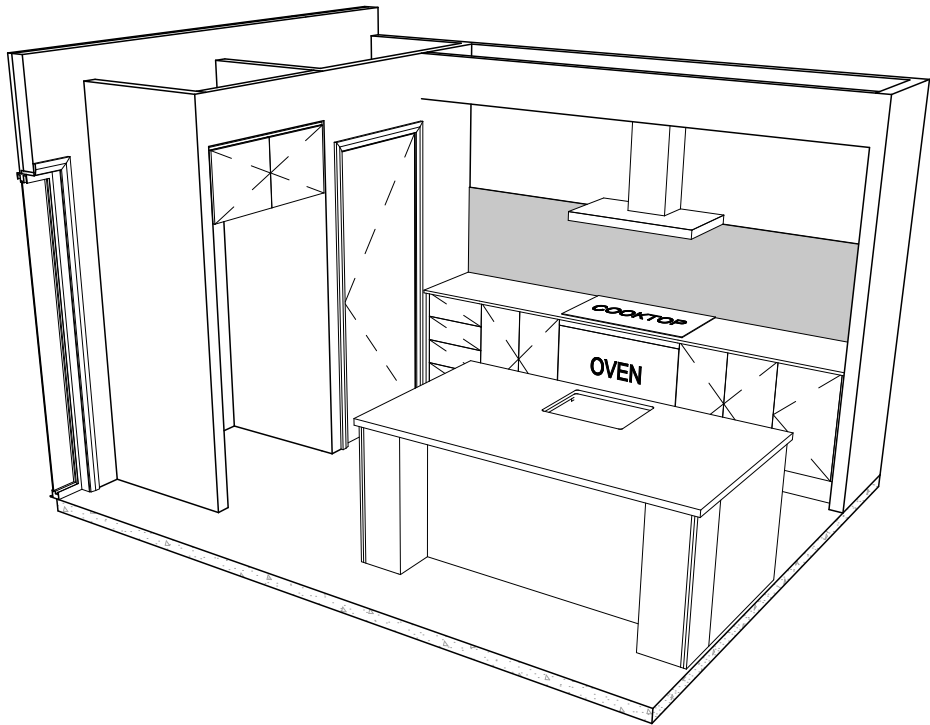
ELEVATION C
SCALE: 1:50



ELEVATION B
SCALE: 1:50



ELEVATION D
SCALE: 1:50

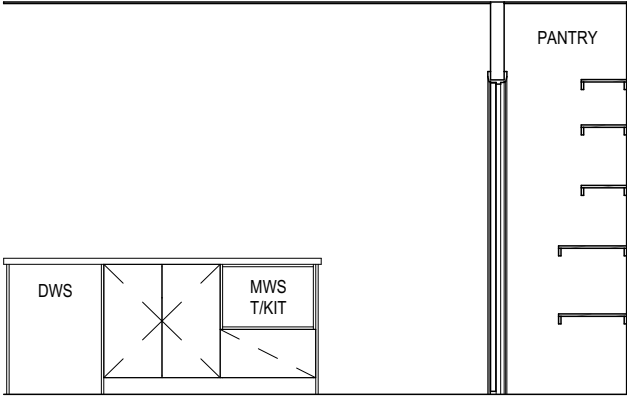

KITCHEN PLAN
SCALE: 1:50

REFER TO SHEET 1 (COVER SHEET) FOR ALL BUILDING INFORMATION REGARDING:
- SUSTAINABILITY REQUIREMENTS
- SITE CLASSIFICATION
- GENERAL BUILDING INFORMATION

DETAILS DEPICTED ON THIS SHEET ARE A REPRESENTATION ONLY. JOINER MAY ADJUST CABINETS AS REQUIRED.

**SUBJECT TO NCC 2022
(1 MAY 2023)
WATERPROOFING & PLUMBING**

PLAN ACCEPTANCE BY OWNER

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COPYRIGHT: © 2025	1 DRAFT SALE PLAN - CT1	HMI 06/10/2025	ADDRESS: 18 NAIRN ST, BUCKLAND TAS 7190	FACADE DESIGN: BARN	FACADE CODE: F-WBH10B10BARN	
	2 CT1 - AMENDMENT	HMI 06/10/2025	LOT / SECTION / CT: 185631 / - / 2	SHEET TITLE: KITCHEN DETAILS	SHEET No.: 13 / 21	
	3 PRELIM PLANS - INITIAL ISSUE	TDI 02/11/2025	COUNCIL: GLAMORGAN SPRING BAY		SCALES: 1:50	
	4 PRELIM PLANS - COLOUR UPDATE	TDI 09/12/2025				
	5 PRELIM PLANS - AMENDMENTS	PL1 11/12/2025				

BAL-12.5 BUSHFIRE REQUIREMENTS
SEE SHEET 1 (COVER SHEET) FOR DETAILS


REFER TO THE FOLLOWING DETAILS:
VANITY DETAILS G-VANI-001
WINDOW OVER BATH HOB D-WIND-ALU001
STANDARD BATH HOB D-WETA-BATH003
WET AREA TILING LAYOUTS D-WETA-TILE002
SQUARE SET WINDOWS G-WIND-SSET02
FULL HEIGHT TILING D-LINI-WETA

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- GENERAL BUILDING INFORMATION


DETAILS DEPICTED ON THIS SHEET ARE A
REPRESENTATION ONLY

LEGEND


- | | |
|------|----------------------------|
| RSHR | RAIL SHOWER |
| ROSE | SHOWER ROSE |
| ELBW | SHOWER ELBOW
CONNECTION |
| MIX | MIXER TAP |
| HT | HOT TAP |
| CT | COLD TAP |
| HS | HOB SPOUT |
| WS | WALL SPOUT |
| SC | STOP COCK |
| TRH | TOILET ROLL HOLDER |
| TR-S | TOWEL RAIL - SINGLE |
| TR-D | TOWEL RAIL - DOUBLE |
| TL | TOWEL LADDER |
| TH | TOWEL HOLDER |
| TR | TOWEL RACK |
| TMB | TUMBLER HOLDER |
| RNG | TOWEL RING |
| RH | ROBE HOOK |
| SHLF | SHELF |
| SR | SHAMPOO RECESS |
| SOAP | SOAP HOLDER |

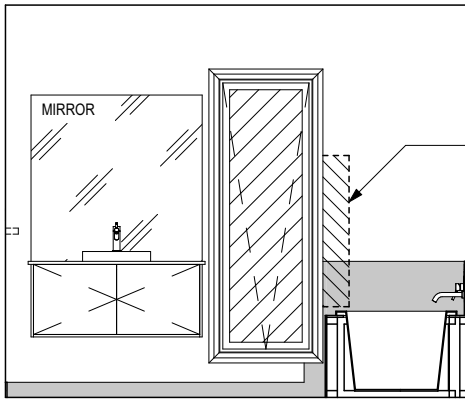


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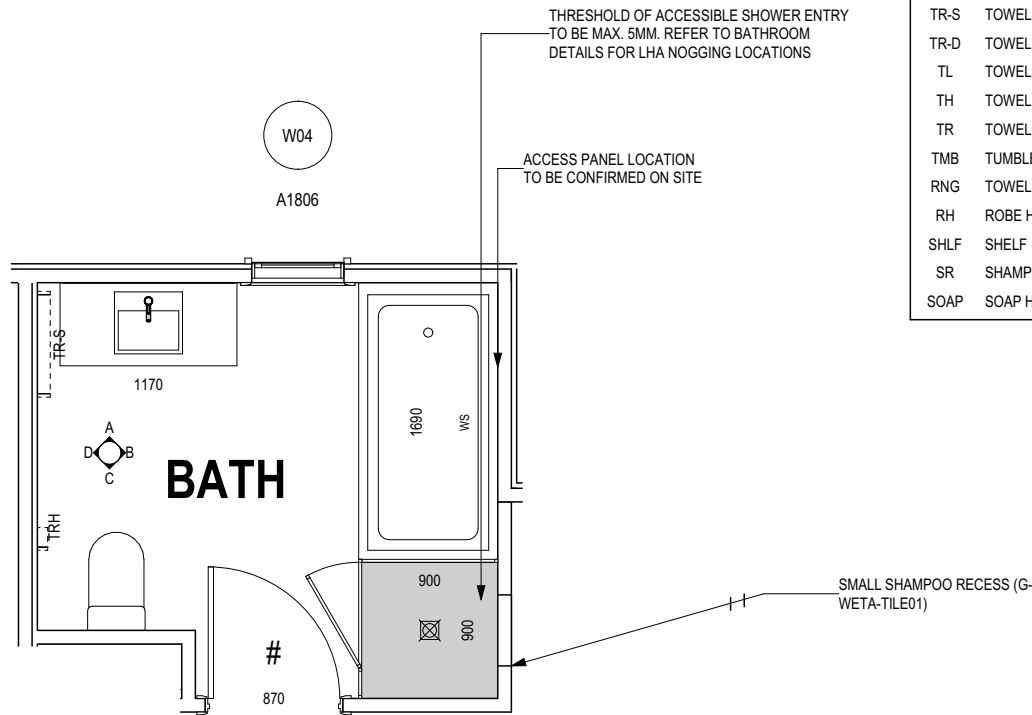
ELEVATION B
SCALE: 1:50

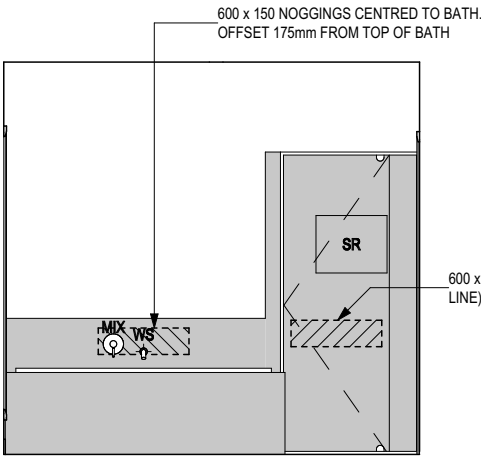

ELEVATION C
SCALE: 1:50

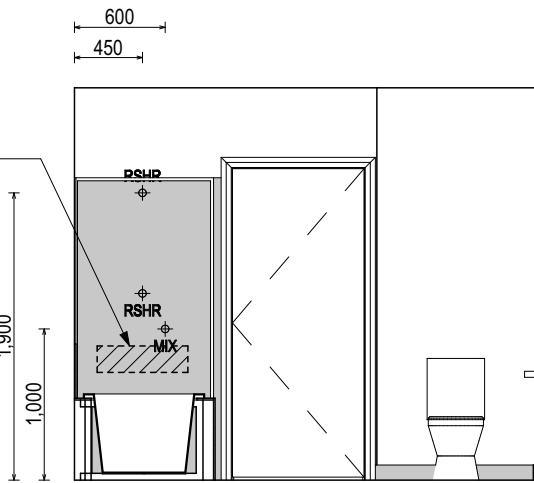

ELEVATION D
SCALE: 1:50

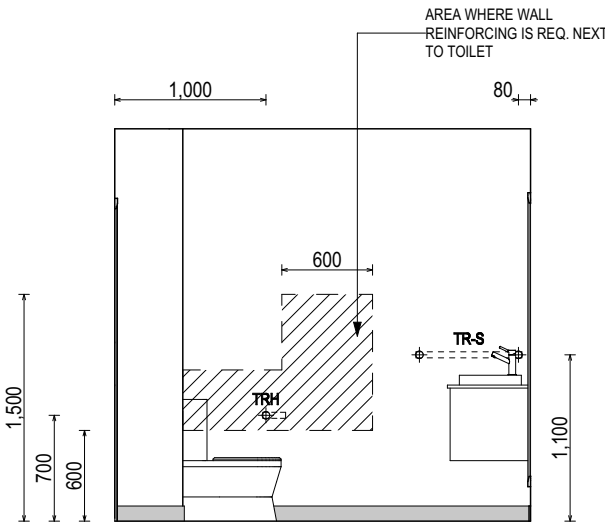

BATHROOM PLAN
SCALE: 1:50

SUBJECT TO NCC 2022
(1 MAY 2023)
WATERPROOFING & PLUMBING

PLAN ACCEPTANCE BY OWNER

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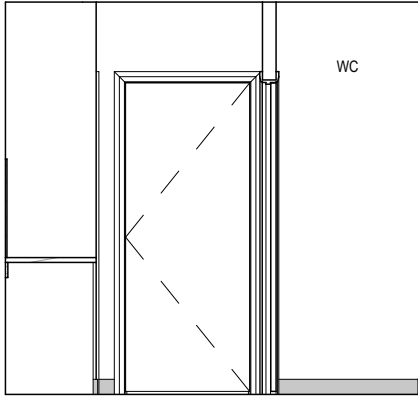


SPECIFICATION: BARN HOUSE	REVISION	DRAWN	CLIENT:	HOUSE DESIGN: BARN HOUSE 10B	HOUSE CODE: H-WBH10B10SA	DO NOT SCALE DRAWINGS. USE FIGURED DIMENSIONS ONLY. CHECK AND VERIFY DIMENSIONS AND LEVELS PRIOR TO THE COMMENCEMENT OF ANY WORK. ALL DISCREPANCIES TO BE REPORTED TO THE DRAFTING OFFICE.
COPYRIGHT: © 2025	1 DRAFT SALE PLAN - CT1	HMI 06/10/2025	ADDRESS: 18 NAIRN ST, BUCKLAND TAS 7190	FACADE DESIGN: BARN	FACADE CODE: F-WBH10B10BARN	
	2 CT1 - AMENDMENT	HMI 06/10/2025	LOT / SECTION / CT: 185631 / - / 2	SHEET TITLE: BATHROOM DETAILS	SHEET No.: 14 / 21	
	3 PRELIM PLANS - INITIAL ISSUE	TDI 02/11/2025	COUNCIL: GLAMORGAN SPRING BAY		SCALES: 1:50	
	4 PRELIM PLANS - COLOUR UPDATE	TDI 09/12/2025				
	5 PRELIM PLANS - AMENDMENTS	PL1 11/12/2025				714463


BAL-12.5 BUSHFIRE REQUIREMENTS
SEE SHEET 1 (COVER SHEET) FOR DETAILS

REFER TO SHEET 1 (COVER SHEET) FOR
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- GENERAL BUILDING INFORMATION


DETAILS DEPICTED ON THIS SHEET ARE A
REPRESENTATION ONLY




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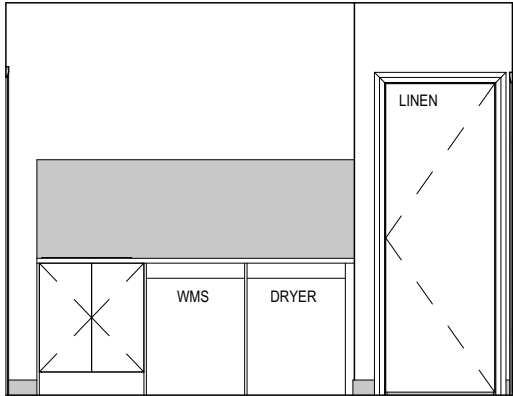
ELEVATION B
SCALE: 1:50

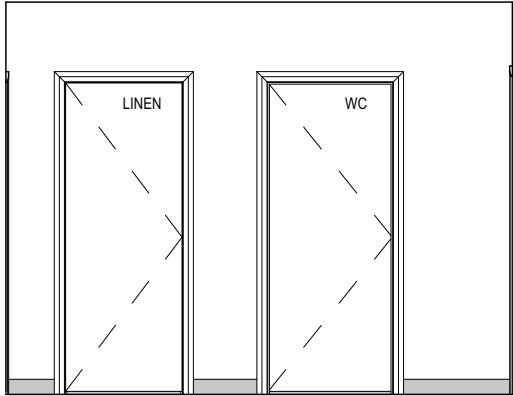

LAUNDRY PLAN
SCALE: 1:50

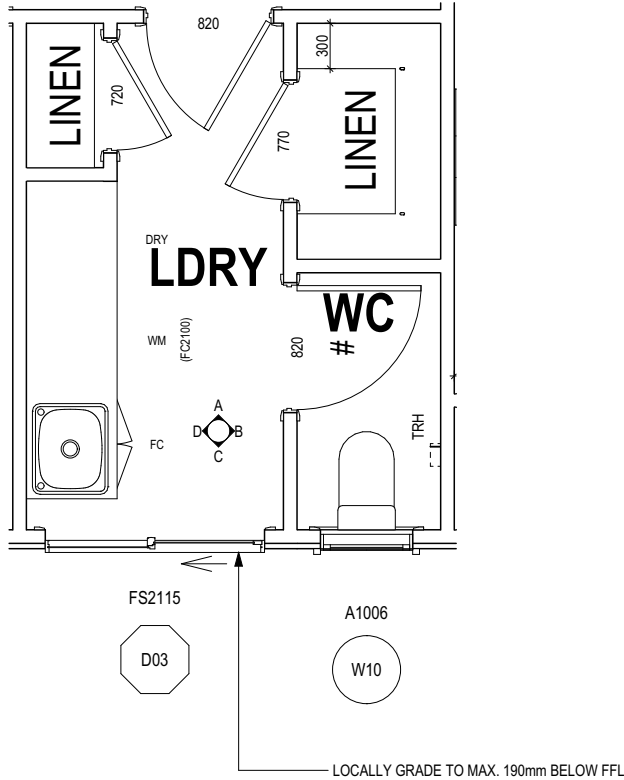

ELEVATION C
SCALE: 1:50

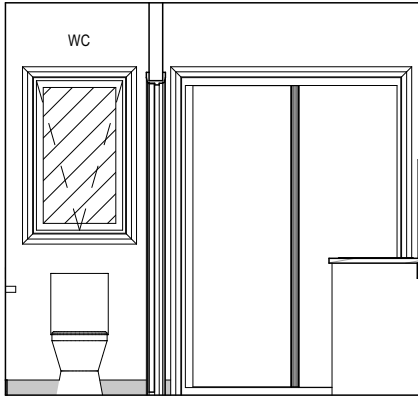

ELEVATION D
SCALE: 1:50

**SUBJECT TO NCC 2022
(1 MAY 2023)
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PLAN ACCEPTANCE BY OWNER

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SIGNATURE: DATE:


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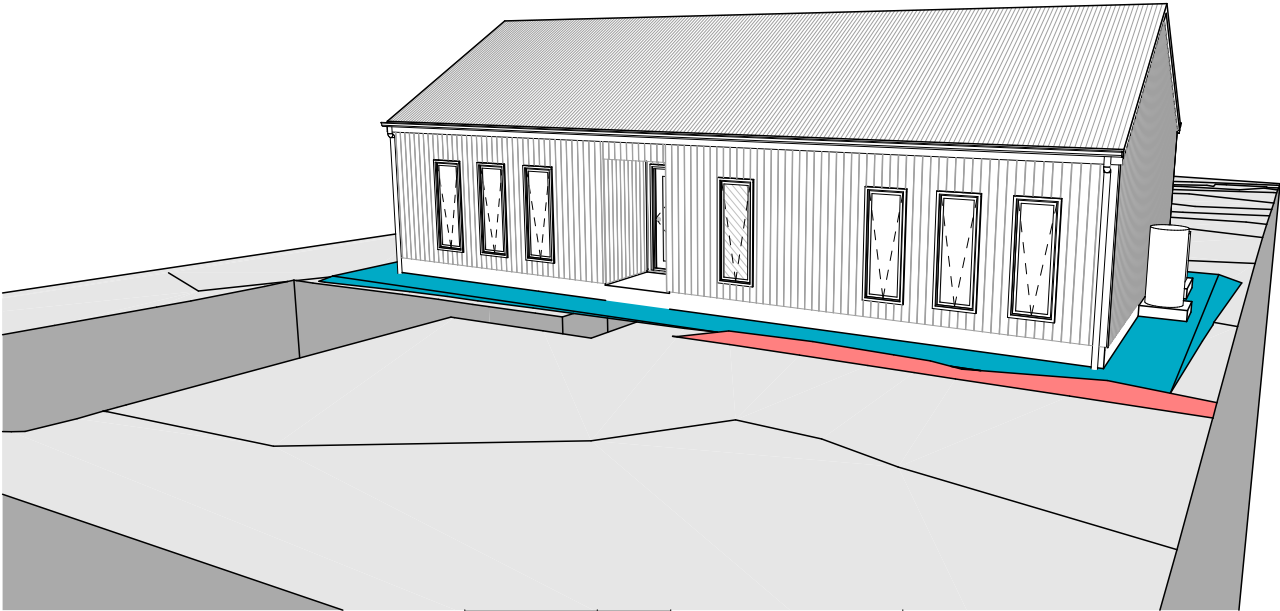
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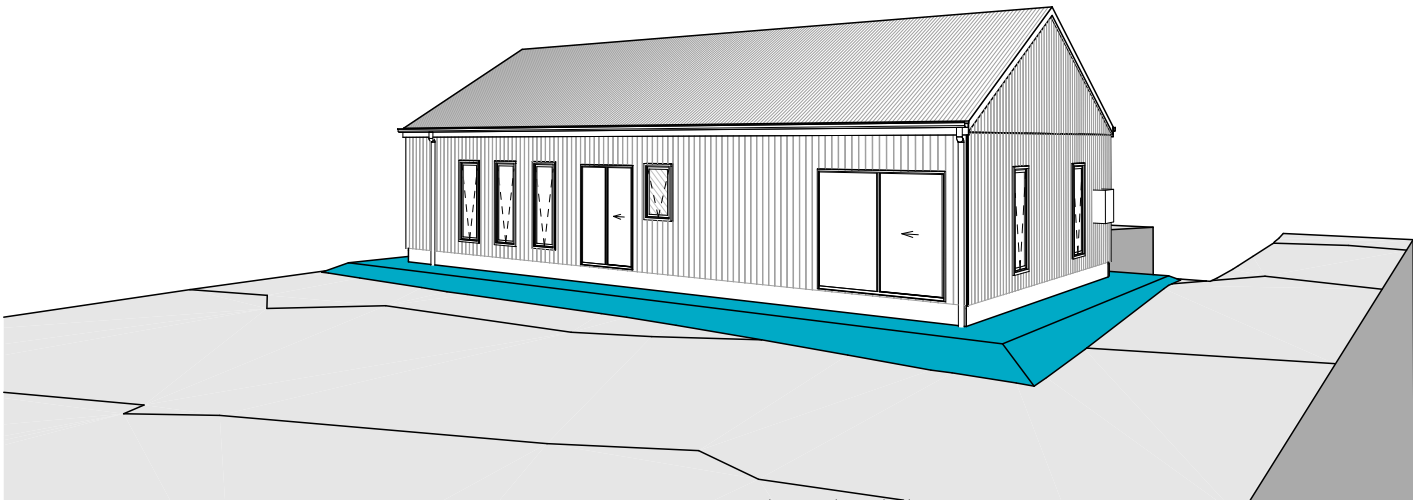
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	2 CT1 - AMENDMENT	HMI 06/10/2025	LOT / SECTION / CT: 185631 / - / 2	SHEET TITLE: LAUNDRY DETAILS	SHEET No.: 15 / 21	
	3 PRELIM PLANS - INITIAL ISSUE	TDI 02/11/2025	COUNCIL: GLAMORGAN SPRING BAY		SCALES: 1:50	
	4 PRELIM PLANS - COLOUR UPDATE	TDI 09/12/2025				
	5 PRELIM PLANS - AMENDMENTS	PL1 11/12/2025				




FRONT LEFT



FRONT RIGHT

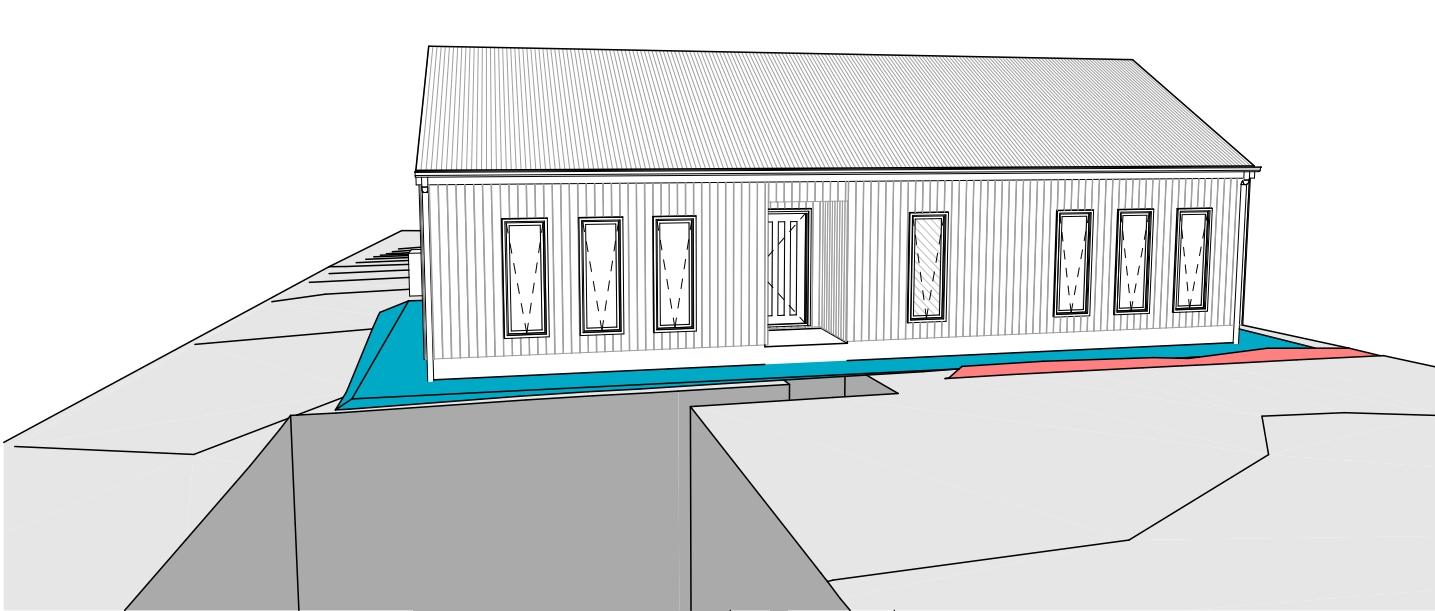

REAR LEFT

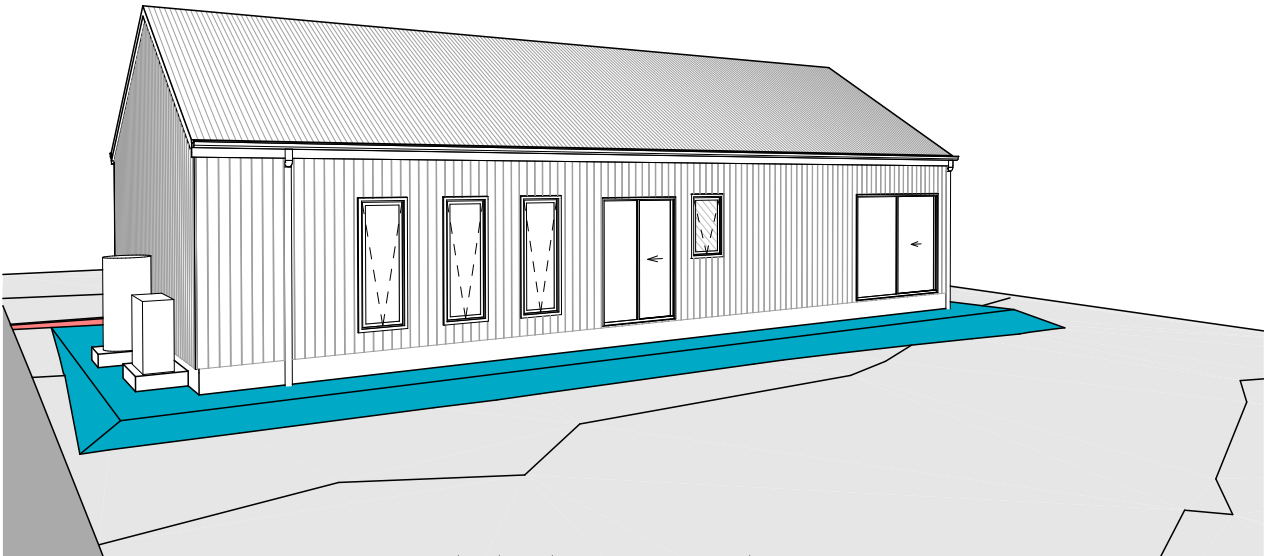

REAR RIGHT

SUBJECT TO NCC 2022
(1 MAY 2023)
WATERPROOFING & PLUMBING

PLAN ACCEPTANCE BY OWNER	
SIGNATURE: _____	DATE: _____
SIGNATURE: _____	DATE: _____
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SPECIFICATION: BARN HOUSE COPYRIGHT: © 2025		REVISION	DRAWN	CLIENT: ADDRESS: 18 NAIRN ST, BUCKLAND TAS 7190	HOUSE DESIGN: BARN HOUSE 10B FACADE DESIGN: BARN	HOUSE CODE: H-WBH10B10SA FACADE CODE: F-WBH10B10BARN A	DO NOT SCALE DRAWINGS. USE FIGURED DIMENSIONS ONLY. CHECK AND VERIFY DIMENSIONS AND LEVELS PRIOR TO THE COMMENCEMENT OF ANY WORK. ALL DISCREPANCIES TO BE REPORTED TO THE DRAFTING OFFICE.
	1	DRAFT SALE PLAN - CT1	HMI 06/10/2025				
	2	CT1 - AMENDMENT	HMI 06/10/2025				
	3	PRELIM PLANS - INITIAL ISSUE	TDI 02/11/2025	LOT / SECTION / CT:	SHEET TITLE:	SHEET No.:	
	4	PRELIM PLANS - COLOUR UPDATE	TDI 09/12/2025	185631 / - / 2	3D VIEWS	16 / 21	
	5	PRELIM PLANS - AMENDMENTS	PL1 11/12/2025	COUNCIL: GLAMORGAN SPRING BAY		SCALES:	714463

WET AREA NOTES

VESSELS OR AREA WHERE THE FIXTURE IS INSTALLED	FLOORS AND HORIZONTAL SURFACES	WALLS	WALL JUNCTIONS AND JOINTS	PENETRATIONS
ENCLOSED SHOWER WITH HOB	WATERPROOF ENTIRE ENCLOSED SHOWER AREA INCLUDING HOB.	WATERPROOF TO NOT LESS THAN 150mm ABOVE THE SHOWER FLOOR SUBSTRATE OR NOT LESS THAN 25mm ABOVE THE MAXIMUM RETAINED WATER LEVEL WHICH EVER IS THE GREATER WITH THE REMAINDER BEING WATERPROOF TO A HEIGHT OF NOT LESS THAN 1800mm ABOVE THE FINISHED FLOOR LEVEL.	WATERPROOF INTERNAL AND EXTERNAL CORNERS AND HORIZONTAL JOINTS WITHIN A HEIGHT OF 1800mm ABOVE THE FLOOR LEVEL WITH NOT LESS THAN 40mm WIDTH EITHER SIDE OF THE JUNCTION.	WATERPROOF ALL PENETRATIONS.
ENCLOSED SHOWER WITHOUT HOB	WATERPROOF ENTIRE ENCLOSED SHOWER AREA, INCLUDING WATERSTOP.	WATERPROOF TO NOT LESS THAN 150mm ABOVE THE SHOWER FLOOR SUBSTRATE WITH THE REMAINDER BEING WATERPROOF TO A HEIGHT OF NOT LESS THAN 1800mm ABOVE THE FINISHED FLOOR LEVEL.	WATERPROOF INTERNAL AND EXTERNAL CORNERS AND HORIZONTAL JOINTS WITHIN A HEIGHT OF 1800mm ABOVE THE FLOOR LEVEL WITH NOT LESS THAN 40mm WIDTH EITHER SIDE OF THE JUNCTION.	WATERPROOF ALL PENETRATIONS.
ENCLOSED SHOWER WITH STEPDOWN	WATERPROOF ENTIRE ENCLOSED SHOWER AREA INCLUDING THE STEPDOWN.	WATERPROOF TO NOT LESS THAN 150mm ABOVE THE SHOWER FLOOR SUBSTRATE OR NOT LESS THAN 25mm ABOVE THE MAXIMUM RETAINED WATER LEVEL WHICHEVER IS THE GREATER WITH THE REMAINDER BEING WATERPROOF TO A HEIGHT OF NOT LESS THAN 1800mm ABOVE THE FINISHED FLOOR LEVEL.	WATERPROOF INTERNAL AND EXTERNAL CORNERS AND HORIZONTAL JOINTS WITHIN A HEIGHT OF 1800mm ABOVE THE FLOOR LEVEL WITH NOT LESS THAN 40mm WIDTH EITHER SIDE OF THE JUNCTION.	WATERPROOF ALL PENETRATIONS.
ENCLOSED SHOWER WITH PRE-FORMED SHOWER BASE	N/A	WATERPROOF TO A HEIGHT OF NOT LESS THAN 1800mm ABOVE FINISHED FLOOR LEVEL.	WATERPROOF INTERNAL AND EXTERNAL CORNERS AND HORIZONTAL JOINTS WITHIN A HEIGHT OF 1800mm ABOVE THE FLOOR LEVEL WITH NOT LESS THAN 40mm WIDTH EITHER SIDE OF THE JUNCTION.	WATERPROOF ALL PENETRATIONS.
UNENCLOSED SHOWERS	WATERPROOF ENTIRE UNCLOSED SHOWER AREA.	WATERPROOF TO NOT LESS THAN 150mm ABOVE THE SHOWER FLOOR SUBSTRATE OR NOT LESS THAN 25mm ABOVE THE MAXIMUM RETAINED WATER LEVEL WHICH EVER IS THE GREATER WITH THE REMAINDER BEING WATERPROOF TO A HEIGHT OF NOT LESS THAN 1800mm ABOVE THE FINISHED FLOOR LEVEL.	WATERPROOF INTERNAL AND EXTERNAL CORNERS AND HORIZONTAL JOINTS WITHIN A HEIGHT OF 1800mm ABOVE THE FLOOR LEVEL WITH NOT LESS THAN 40mm WIDTH EITHER SIDE OF THE JUNCTION.	WATERPROOF ALL PENETRATIONS.
AREAS OUTSIDE THE SHOWER AREA FOR CONCRETE AND COMPRESSED FIBRE CEMENT SHEET FLOORING	WATER RESISTANT TO ENTIRE FLOOR.	N/A	WATERPROOF ALL WALL/FLOOR JUNCTIONS. WHERE A FLASHING IS USED THE HORIZONTAL LEG MUST BE NOT LESS THAN 40mm.	N/A
AREAS OUTSIDE THE SHOWER AREA FOR TIMBER FLOORS INCLUDING PARTICLEBOARD, PLYWOOD AND OTHER TIMBER BASED FLOORING MATERIALS	WATERPROOF ENTIRE FLOOR.	N/A	WATERPROOF ALL WALL/FLOOR JUNCTIONS. WHERE A FLASHING IS USED THE HORIZONTAL LEG MUST BE NOT LESS THAN 40mm.	N/A
AREAS ADJACENT TO BATHS AND SPAS FOR CONCRETE AND COMPRESSED FIBRE CEMENT SHEET FLOORING.	WATER RESISTANT TO ENTIRE FLOOR.	WATERPROOF TO A HEIGHT OF NOT LESS THAN 150mm ABOVE THE VESSEL AND EXPOSED SURFACES BELOW THE VESSEL LIP TO FLOOR LEVEL.	WATERPROOF EDGES OF THE VESSEL AND JUNCTION OF BATH ENCLOSURE WITH FLOOR. WHERE THE LIP OF THE BATH IS SUPPORTED BY A HORIZONTAL SURFACE, THIS MUST BE WATERPROOF FOR SHOWERS OVER BATH AND WATER RESISTANT FOR ALL OTHER CASES.	WATERPROOF ALL TAP AND SPOUT PENETRATIONS WHERE THEY OCCUR IN A HORIZONTAL SURFACE.
AREAS ADJACENT TO BATHS AND SPAS (SEE NOTE 1) FOR TIMBER FLOORS INCLUDING PARTICLEBOARD, PLYWOOD AND OTHER TIMBER BASED FLOORING MATERIALS.	WATERPROOF ENTIRE FLOOR.	WATERPROOF TO A HEIGHT OF NOT LESS THAN 150mm ABOVE THE VESSEL AND EXPOSED SURFACES BELOW THE VESSEL LIP TO FLOOR LEVEL.	WATERPROOF EDGES OF THE VESSEL AND JUNCTION OF BATH ENCLOSURE WITH FLOOR. WHERE THE LIP OF THE BATH IS SUPPORTED BY A HORIZONTAL SURFACE, THIS MUST BE WATERPROOF FOR SHOWERS OVER BATH AND WATER RESISTANT FOR ALL OTHER CASES.	WATERPROOF ALL TAP AND SPOUT PENETRATIONS WHERE THEY OCCUR IN A HORIZONTAL SURFACE.
INSERTED BATHS	N/A FOR FLOOR UNDER BATH. ANY SHELF AREA ADJOINING THE BATH OR SPA MUST BE WATERPROOF AND INCLUDE A WATERSTOP UNDER THE VESSEL LIP.	N/A FOR WALL UNDER BATH. WATERPROOF TO NOT LESS THAN 150mm ABOVE THE LIP OF THE BATH.	N/A FOR WALL UNDER BATH. WATERPRROF TO NOT LESS THAN 150 mm ABOVE THE LIP OF A BATH OR SPA.	WATERPROOF ALL TAP AND SPOUT PENETRATIONS WHERE THEY OCCUR IN A HORIZONTAL SURFACE.
WALLS ADJOINING OTHER VESSELS (EG. SINKS, LAUNDRY TUBS AND BASINS)	N/A	WATERPROOF TO A HEIGHT OF NOT LESS THAN 150mm ABOVE THE VESSEL IF THE VESSEL IS WITHIN 75mm OF THE WALL.	WHERE THE VESSEL IS FIXED TO A WALL, WATERPROOF EDGES FOR EXTENT OF VESSEL.	WATERPROOF ALL TAP AND SPOUT PENETRATIONS WHERE THEY OCCUR IN A HORIZONTAL SURFACE.
LAUNDRIES AND WCS	WATER RESISTANT TO ENTIRE FLOOR.	WATERPROOF ALL WALL/FLOOR JUNCTIONS TO NOT LESS THAN 25mm ABOVE THE FINISHED FLOOR LEVEL, SEALED TO FLOOR.	WATERPROOF ALL WALL/FLOOR JUNCTIONS. WHERE A FLASHING IS USED THE HORIZONTAL LEG MUST BE NOT LESS THAN 40mm.	N/A

THE ABOVE INFORMATION IS FOR GENERAL GUIDANCE AND IS INDICATIVE ONLY. WATERPROOFING INSTALLERS TO COMPLY WITH ALL CURRENT CODES OF LEGISLATION WHICH TAKE PRECEDENCE OVER THIS SPECIFICATION.

WET AREA WAERPROOFING BY LICENSED AND ACCREDITED INSTALLER. CERTIFICATION TO BE PROVIDED TO BUILDING SURVEYOR. CONTRACTOR OR BUILDER TO DETERMINE THE APPROPRIATE WATERPROOFING IN ACCORDANCE WITH AS3740 PART 10.2 OF N.C.C AND TO NOTIFY THE BUILDING SURVEYOR FOR INSPECTION ARRANGEMENTS DURING INSTALLATION.

ENERGY EFFICIENCY - GENERAL

STATED R VALUES ARE FOR ADDITIONAL INSULATION REQUIRED AND ARE NOT RT VALUES (TOTAL SYSTEM VALUE)

INSULATION TO BE INSTALLED TO MANUFACTURERS SPECIFICATIONS AND ANY RELEVANT STANDARDS

BULK INSULATION IS NOT TO BE COMPRESSED AS THIS REDUCES THE EFFECTIVE R RATING

WAFFLE POD ALLOWANCES:

- R0.6 - 175mm DEEP
- R0.7 - 225mm DEEP
- R0.8 - 300mm DEEP
- R0.9 - 375mm DEEP

N.C.C 2022 TAS PART H6

IN TASMANIA, FOR NCC PART H6 REFER TO NCC 2019 AMENDMENT 1 PART 2.6; FOR NCC PART 13.1 REFER TO NCC 2019 PART 3.12

N.C.C 2019 3.12.0 (A)

PERFORMANCE REQUIREMENT P2.6.1 FOR THE THERMAL PERFORMANCE OF THE BUILDING IS SATISFIED BY COMPLYING WITH:

3.12.0.1 - FOR REDUCING THE HEATING AND COOLING LOADS
TO REDUCE HEATING AND COOLING LOADS MUST ACHIEVE AN ENERGY RATING USING HOUSING ENERGY RATING SOFTWARE OF NOT LESS THAN 6 STARS.

3.12.1.1 - FOR BUILDING FABRIC THERMAL INSULATION
BUILDER TO ENSURE THAT ALL INSULATION COMPLIES WITH AS/NZS 4859.1 AND BE INSTALLED TO N.C.C 3.12.1.1.

3.12.1.2(e) - FOR COMPENSATING FOR A LOSS OF CEILING INSULATION
REFER TO ATTACHED THERMAL PERFORMANCE CERTIFICATE
(i) IF ALLOWANCE HAS BEEN MADE FOR CEILING PENERATIONS IN NATHERS (FIRST RATE 5) CERTIFICATION PROCESS THEN NO FURTHER ACTION REQUIRED.
(ii) IF NO ALLOWANCE HAS BEEN MADE FOR CEILING PENETRATIONS IN NATHERS (FIRST RATE 5) CERTIFICATION PROCESS THEN CEILING PENETRATION AREA MUST BE CALCULATED AND THE NECESSARY ADJUSTMENT MADE TO THE SPECIFIED INSULATION AS PER TABLE 3.12.1.1B OF NCC

3.12.1.5(c) AND 3.12.1.5(d) - FOR FLOOR EDGE INSULATION
FOR CONCRETE SLAB ON GROUND WITH IN SLAB HEATING OR COOLING.

3.12.3 - FOR BUILDING SEALING
3.12.3.1 - CHIMNEYS AND FLUES
THE CHIMNEY OR FLUE OF AN OPEN SOLID FUEL BURNING APPLIANCE MUST BE PROVIDED WITH A DAMPER OR FLAP THAT CAN BE CLOSED TO SEAL THE CHIMNEY OR FLUE.

3.12.3.2 - ROOF LIGHTS
(a) A ROOF LIGHT MUST BE SEALED, OR CAPABLE OF BEING SEALED WHEN SERVING:
(i) A CONDITIONED SPACE; OR
(ii) A HABITABLE ROOM IN CLIMATE ZONES 4, 5, 6, 7 OR 8
(b) A ROOF LIGHT REQUIRED BY (a) TO BE SEALED, OR CAPABLE OF BEING SEALED MUST BE CONSTRUCTED WITH:
(i) AN IMPERFORATE CEILING DIFFUSER OR THE LIKE INSTALLED AT A CEILING OR INTERNAL LINING LEVEL; OR
(ii) A WATERPROOF SEAL; OR
(iii) A SHUTTER SYSTEM READILY OPERATED MANUALLY, MECHANICALLY OR ELECTRONICALLY BY THE OCCUPANT.

3.12.0.1 - EXTERNAL WINDOWS AND DOORS
(a) A SEAL TO RESTRIC AIR INFILTRATION MUST BE FITTED TO EACH OF AN EXTERNAL DOOR, OPENABLE WINDOW AND OTHER SUCH OPENING:
(i) WHEN SERVING A CONDITIONED SPACE; OR
(ii) IN CLIMATE ZONES 4, 5, 6, 7 OR 8, WHEN SERVING A HABITABLE ROOM.
(b) A WINDOW COMPLYING WITH THE MAXIMUM AIR INFILTRATION RATES SPECIFIED IN AS2047 NEED NOT COMPLY WITH (a).
(c) A SEAL REQUIRED BY (a)
(i) FOR THE BOTTOM EDGE OF AN INTERNAL SWING DOOR, MUST BE A DRAFT PROTECTION DEVICE; AND
(ii) FOR THE OTHER EDGES OF AN EXTERNAL SWING DOOR OR THE EDGES OF AN OPENABLE WINDOW OR OTHER SUCH OPENING, MAY BE A FOAM OR RUBBER COMPRESSIBLE STRIP, FIBROUS SEAL OR THE LIKE.

3.12.3.4 - EXHAUST FANS
AN EXHAUST FAN MUST BE FITTED WITH A SEALING DEVICE SUCH AS A SELF CLOSE DAMPER, FILTER OR THE LIKE WHEN SERVING:
(a) A CONDITIONED SPACE; OR
(b) A HABITABLE ROOM IN THE CLIMATE ZONES 4, 5, 6, 7 OR 8.

3.12.3.5 - CONSTRUCTION OF ROOF, WALLS AND FLOORS
(a) ROOFS, EXTERNAL WALLS, EXTERNAL FLOORS AND AN OPENING SUCH AS A WINDOW FRAME, DOOR FRAME, ROOF LIGHT FRAME OR THE LIKE MUST BE CONSTRUCTED TO MINIMISE AIR LEAKAGE IN ACCORDANCE WITH (b) WHEN FORMING PART OF THE EXTERNAL FABRIC OF:
(i) A CONDITIONED SPACE; OR
(ii) A HABITABLE ROOM IN CLIMATE ZONE 4, 5, 6, 7 OR 8.
(b) CONSTRUCTION REQUIRED BY (a) MUST BE:
(i) ENCLOSED BY AN INTERNAL LINING SYSTEM THAT ARE CLOSE FITTING AT CEILING, WALL AND FLOOR JUNCTIONS; OR
(ii) SEALED BY CAULKING, SKIRTING, ARCHITRAVES, CORNICES OR THE LIKE.

3.12.3.6 - EVAPORATIVE COOLERS
AN EVAPORATIVE COOLER MUST BE FITTED WITH A SELF CLOSING DAMPER OR THE LIKE WHEN SERVING:
(a) A HEATED SPACE; OR
(b) A HABITABLE ROOM IN CLIMATE ZONES 4, 5, 6, 7 OR 8.

3.12.5.5 - ARTIFICIAL LIGHTING
(a) LAMP POWER DENSITY OR ILLUMINATION POWER DENSITY OF AN ARTIFICIAL LIGHT, EXCLUDING HEATING THAT EMITS LIGHT, MUST NOT EXCEED THE ALLOWANCE OF:
(i) 5W/m² IN A CLASS 1 BUILDING
(ii) 4W/m² ON A VERANDAH, BALCONY OR THE LIKE ATTACHED TO A CLASS 1 BUILDING (NOT EXCLUDING EAVE PERIMETER LIGHTS);
(iii) 3W/m² IN A CLASS 10A BUILDING ASSOCIATED WITH A CLASS 1 BUILDING.
(b) THE ILLUMINATION POWER DENSITY ALLOWANCE IN (a) MAY BE INCREASED BY DIVIDING IT BY THE ILLUMINATION POWER DENSITY ADJUSTMENT FACTOR FOR A CONTROL DEVICE AS PER N.C.C TABLE 3.12.5.3.

SUBJECT TO NCC 2022
(1 MAY 2023)
WATERPROOFING & PLUMBING

PLAN ACCEPTANCE BY OWNER

SIGNATURE: DATE:

SIGNATURE: DATE:

PLEASE NOTE THAT VARIATIONS WILL NOT BE ACCEPTED AFTER THIS PLAN ACCEPTANCE HAS BEEN SIGNED

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	2	CT1 - AMENDMENT	HMI 06/10/2025	LOT / SECTION / CT: 185631 / - / 2	SHEET TITLE: WET AREA & ENERGY EFFICIENCY NOTES	SHEET No.: 18 / 21	
	3	PRELIM PLANS - INITIAL ISSUE	TDI 02/11/2025	COUNCIL: GLAMORGAN SPRING BAY			
	4	PRELIM PLANS - COLOUR UPDATE	TDI 09/12/2025				
	5	PRELIM PLANS - AMENDMENTS	PL1 11/12/2025				

714463

Requirements for Building In Bushfire Hazard Areas
Building Act 2016
Directors Determination - Bushfire Hazard Areas
V1.1, dated 08 April 2021

Deemed-to-Satisfy Requirements (Part 2.3)

2.3.1 Design and construction
(1) Building work in a bushfire-prone area must be designed and constructed in accordance with either: -
(a) AS 3959-2018; or
(b) Standard for Steel Framed Construction in Bushfire Areas published by the National Association of Steel Framed Housing Inc. (NASH), as appropriate for a BAL determined for that site using table 2.6 of AS 3959.
(2) Subclause (1)(a) is only applicable to the following:
(a) a Class 1, 2 or 3 building; or
(b) a Class 10a building or deck associated with a Class 1, 2 or 3 building.
(3) Subclause (1)(b) is only applicable to the following:
(a) a Class 1 building; or
(b) a Class 10a building or deck associated with a Class 1 building.
(4) Despite subsection (1) permissible, variations from requirements specified in 1(a) and 1(b) are as specified in Table 1.
(5) Despite subsections (1) and (4), performance requirements for buildings subject to BAL 40 or BAL Flame Zone (BAL-FZ) are not satisfied by compliance with subsections (1) or (4).

2.3.2 Property Access
(1) A new building in a bushfire-prone area must be provided with property access to the building area and the firefighting water point, accessible by a carriageway, designed and constructed as specified in subclause (4).
(2) For an addition or alteration to an existing building in a bushfire-prone area, if there is no property access available property access must be provided to the building area and the firefighting water point accessible by a carriageway as specified in subclause (4).
(3) An addition or alteration to an existing building in a bushfire-prone area must not restrict any existing property access to the building area or to water supply for firefighting.
(4) Vehicular access from a public road to a building must:
(a) comply with the property access requirements specified in Table 2;
(b) include access from a public road to within 90 metres of the furthest part of the building measured as a hose lay; and
(c) include access to the hardstand area for the firefighting water point.

2.3.3 Water Supply for Fire fighting
(1) A new building constructed in a bushfire-prone area, must be provided with a water supply dedicated for fire fighting purposes as specified in Table 3A or Table 3B.
(2) For an addition or alteration to an existing building in a bushfire-prone area, if there is no water supply for firefighting available the building must be provided with a water supply dedicated for firefighting purposes which complies with the requirements specified in Table 3A or Table 3B.

2.3.4 Hazard Management Areas
(1) A new building, and an existing building in the case of an addition or alteration to a building, in a bushfire-prone area must be provided with a hazard management area.
(2) The hazard management area must comply with the requirements specified in Table 4.
(3) The hazard management area for a particular BAL must have the minimum dimensions required for the separation distances specified for that BAL in Table 2.6 of AS 3959.
(4) The hazard management area must be established and maintained such that the fuels are reduced sufficiently, and other hazards are removed such that the fuels and other hazards do not significantly contribute to the bushfire attack.
2.3.5 Bushfire emergency plan
(1) An emergency plan must be provided for:
(a) a new building;
(b) an existing building in the case of an addition or alteration to a building;
(c) an existing building in the case of a change of building class;
(d) a building associated with the use, handling, generation or storage of a hazardous chemical or explosive; in a bushfire-prone area.
(2) A bushfire emergency plan must comply with the requirements specified in Table 5.

7. Interpretation of Tables
(1) For the purposes of the deemed-to-satisfy provisions in clause 2.3 of this Determination, Tables 1, 2, 3A, 3B, 4, and 5 must be complied with in the following way:
(a) for a particular element specified in column 1, the corresponding requirement specified in column 2 must be complied with.

Table 1 - Construction Requirements & Construction Variations

Column 1		Column 2
ELEMENT		REQUIREMENT
A.	Straw Bale Construction	May be used in exposures up to and including BAL 19.
B.	Shielding provisions under Section 3.5 of AS3959-2018	To reduce construction requirements due to shielding, building plans must include suitable detailed elevations or plans that demonstrate that the requirements of Section 3.5 of the Standard can be met.
		Comment: Application of Section 3.5 of the Standard cannot result in and assessment of BAL-LOW.

Table 2 - Requirements for Property Access

Column 1		Column 2
ELEMENT		REQUIREMENT
A.	Property access length is less than 30 metres; or access is not for a fire appliance to access a water connection point.	There are no specified design and construction requirements.
B.	Property access length is 30 metres or greater; or access for a fire appliance to a water connection point.	The following design and construction requirements apply to property access: (1) All-weather construction; (2) Load capacity of at least 20 tonnes, including for bridges and culverts; (3) Minimum carriageway widths of 4 metres; (4) Minimum vertical clearance of 4 metres; (5) Minimum horizontal clearance of 0.5 metres from the edge of the carriageway; (6) Cross falls of less than 3° (1:20 or 5%); (7) Dips less than 7° (1:8 or 12.5%) entry and exit angle; (8) Curves with a minimum inner radius of 10 metres; (9) Maximum gradient of 15° (1:3.5 or 28%) for sealed roads, and 10° (1:5.5 or 18%) for unsealed roads; and (10) Terminate with a turning area for fire appliances provided by one of the following: (a) A turning circle with a minimum inner radius of 10 metres; (b) A property access encircling the building; or (c) A hammerhead "T" or "Y" turning head 4 metres wide and 8 metres long.
C.	Property access length is 200 metres or greater.	The following design and construction requirements apply to property access: (1) The Requirements for B above; and (2) Passing bays of 2 metres additional carriageway width and 20 metres length provided every 200 metres.
D.	Property access length is greater than 30 metres, and access is provided to 3 or more properties.	The following design and construction requirements apply to property access: (1) Complies with Requirements for B above; and (2) Passing bays of 2 metres additional carriageway width and 20 metres length must be provided every 100 metres.

Table 3A - Reticulated Water Supply for Firefighting

Column 1		Column 2
ELEMENT		REQUIREMENT
A.	Distance between building area to be protected and water supply	The following requirements apply: (1) The building area to be protected must be located within 120 metres of a fire hydrant; and (2) The distance must be measured as a hose lay, between the water connection point and the furthest part of the building area.
B.	Design criteria for fire hydrants	The following requirements apply: (1) Fire hydrant system must be designed and constructed in accordance with TasWater Supplement to Water Supply Code of Australia WSA 03 - 2011-3.1 MRWA Edition 2.0; and (2) Fire hydrants are not installed in parking areas.
C.	Hardstand	A hardstand area for fire appliances must be provided: (1) no more than three metres from the hydrant, measured as a hose lay; (2) No closer than six metres from the building area to be protected; (3) With a minimum width of three metres constructed to the same standard as the carriageway; and (4) Connected to the property access by a carriageway equivalent to the standard of the property access

Table 3B - Static Water Supply for Firefighting

Column 1		Column 2
ELEMENT		REQUIREMENT
A.	Distance between building area to be protected and water supply	The following requirements apply: (a) The building area to be protected must be located within 90 metres of the water connection point of a static water supply; and (b) The distance must be measured as a hose lay, between the water connection point and the furthest part of the building area.
B.	Static Water Supplies	A static water supply: (a) May have a remotely located offtake connected to the static water supply; (b) May be a supply for combined use (fire fighting and other uses) but the specified minimum quantity of fire fighting water must be available at all times; (c) Must be a minimum of 10,000 litres per building area to be protected. This volume of water must not be used for any other purpose including fire fighting sprinkler or spray systems; (d) Must be metal, concrete or lagged by non-combustible materials if above ground; and (e) If a tank can be located so it is shielded in all directions in compliance with Section 3.5 of AS 3959-2018, the tank may be constructed of any material provided that the lowest 400 mm of the tank exterior is protected by: (i) metal; (ii) non-combustible material; or (iii) fibre-cement a minimum of 6 mm thickness.
C.	Fittings, pipework and accessories (including stands and tank supports)	Fittings and pipework associated with a water connection point for a static water supply must: (a) Have a minimum nominal internal diameter of 50mm; (b) Be fitted with a valve with a minimum nominal internal diameter of 50mm; (c) Be metal or lagged by non-combustible materials if above ground; (d) Where buried, have a minimum depth of 300mm (e) Provide a DIN or NEN standard forged Storz 65 mm coupling fitted with a suction washer for connection to fire fighting equipment; (f) Ensure the coupling is accessible and available for connection at all times; (g) Ensure the coupling is fitted with a blank cap and securing chain (minimum 220 mm length); (h) Ensure underground tanks have either an opening at the top of not less than 250 mm diameter or a coupling compliant with this Table; and (i) Where a remote offtake is installed, ensure the offtake is in a position that is: (i) Visible; (ii) Accessible to allow connection by fire fighting equipment; (iii) At a working height of 450 - 600mm above ground level; and (iv) Protected from possible damage, including damage by vehicles.
D.	Signage for static water connections	(1) The water connection point for a static water supply must be identified by a sign permanently fixed to the exterior of the assembly in a visible location. The sign must: (a) comply with water tank signage requirements within AS 2304; or (b) comply with the TFS Water Supply Signage Guideline.
E.	Hardstand	A hardstand area for fire appliances must be provided: (a) No more than three metres from the water connection point, measured as a hose lay (including the minimum water level in dams, swimming pools and the like); (b) No closer than six metres from the building area to be protected; (c) With a minimum width of three metres constructed to the same standard as the carriageway; and (d) Connected to the property access by a carriageway equivalent to the standard of the property access.

Table 4 - Requirements for Hazard Management Area

Column 1		Column 2
ELEMENT		REQUIREMENT
A.	Hazard managements areas for new buildings on lots provided with a BAL at the time of subdivision.	A new building must: (a) Be located on the lot so as to be provided with a HMA no smaller than the required separation distances for the BAL determined at the time of the subdivision; and (b) Have a HMA established in accordance with a certified bushfire hazard management plan.
B.	Hazard management areas for new buildings on lots not provided with a BAL at the time of sub division.	A new building must: (a) Be located on the lot so as to be provided with a HMA no smaller than the separation distances required for BAL 29; and (b) Have an HMA established in accordance with a certified bushfire hazard management plan.
C.	Hazard management areas for alterations or additions to buildings.	An alteration or addition to a building must: (a) Be located on the lot so as to be provided with a HMA which: (i) Has the separation distances required for the BAL assessed for the construction of the existing building; or (ii) In the case of a building without an existing BAL assessment, is no smaller than the separation distances required for BAL 29; and (b) Have an HMA established in accordance with a certified bushfire hazard management plan.
D.	Hazard management areas for new buildings and additions and alterations to buildings classified as an accommodation building BCA Class 1b, BCA Class 2, or BCA Class 3, other than communal residence for persons with a disability, a respite centre or a residential aged care facility or similar.	A new building or an alteration or addition must: (a) Be located on the lot so as to be provided with HMAs no smaller than the separation distances required for BAL 12.5; and (b) have a HMA established in accordance with a certified bushfire hazard management plan.
E.	Hazard management areas for new buildings and additions and alterations to existing buildings classified as vulnerable use as defined in the relevant planning scheme.	A new building or an addition or alteration including change of use must: (a) Be located on the lot so as to be provided with HMAs no smaller than the separation distances required for BAL 12.5; and (b) have a HMA established in accordance with a certified bushfire hazard management plan.
F.	Hazard management areas for new buildings or additions and alterations to buildings associated with the use, handling, generation or storage of a hazardous chemical or explosive.	A new building or an alteration or addition, including change of use, for a building determined as a hazardous use must: (a) Be located on the lot so as to be provided with a HMA no smaller than the required separation distances for the BAL determined in the certified bushfire hazard management plan; and (b) Have a HMA established in accordance with a certified bushfire hazard management plan.

Table 5 - Requirements for Emergency Planning

Column 1		Column 2
ELEMENT		REQUIREMENT
A.	Bushfire emergency plans	An emergency plan must be developed for the site which is: (a) Consistent with TFS Bushfire Emergency Planning Guidelines; and (b) Approved by TFS or a person accredited by the TFS.

REFER TO SHEET 1 (COVER SHEET) FOR ALL BUILDING INFORMATION REGARDING:
- SUSTAINABILITY REQUIREMENTS
- SITE CLASSIFICATION
- GENERAL BUILDING INFORMATION

BAL-12.5 BUSHFIRE REQUIREMENTS
SEE SHEET 1 (COVER SHEET) FOR DETAILS

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© 2025		3	PRELIM PLANS - INITIAL ISSUE	TDI	02/11/2025			BARN		F-WBH10B10BARN A		
		4	PRELIM PLANS - COLOUR UPDATE	TDI	09/12/2025	LOT / SECTION / CT:	COUNCIL:	SHEET TITLE:	SHEET No.:	SCALES:	714463	
		5	PRELIM PLANS - AMENDMENTS	PL1	11/12/2025	185631 / - / 2	GLAMORGAN SPRING BAY	BUILDING ACT BUSHFIRE HAZARD AREAS	19 / 21			

AS3959 (2018)

All specifications are per AS3959 (2018) and Wilson Homes request. Other materials and options may be available, refer to AS3959 for full list of compliant materials.

5.1 GENERAL

A building assessed in Section 2 as being BAL -12.5 shall comply with Section 3 and Clauses 5.2 to 5.8.

Any element of construction or system that satisfies the test criteria of AS 1530.8.1 may be used in lieu of the applicable requirements contained in Clauses 5.2 to 5.8 (see Clause 3.8).

NOTE: BAL -12.5 is primarily concerned with protection from ember attack, and radiant heat up to and including 29kW/m² where the site is less than 100 m from the source of the bushfire attack.

5.2 SUBFLOOR SUPPORTS

This Standard does not provide construction requirements for subfloor supports where the subfloor space is enclosed with -
(a) a wall that complies with Clause 5.4; OR
(b) a mesh or perforated sheet with a maxium aperture of 2mm, made of corrosion resistant steel, bronze or aluminium; OR
(c) a combination of Items (a) and (b).

NOTE: This requirement applies to the subject building only and not to verandas, decks, steps, ramps and landings (see Clause 5.7)

C5.2 Combustible materials stored in the subfloor space may be ignited by embers and cause and impact to the building.

5.3 FLOORS

5.3.1 GENERAL

This Standard does not provide construction requirements for concrete slabs on the ground.

5.3.2 ELEVATED FLOORS

5.3.2.1 ENCLOSED SUBFLOOR SPACE

This standard does not provide consturction requirements for elevated floors, including bearers and joists and flooring, where the subfloor space is enclosed with

- (a) a wall that complies with Clause 5.4; OR
- (b) a mesh perforated sheet with a maximum aperture of 2mm, made of corrosion resistant steel, bronze or aluminium; OR
- (c) a combination of Items (a) and (b) above.

5.3.2.2 UNENCLOSED SUBFLOOR SPACE

Where the subfloor space is unenclosed, the bearers, joists and flooring, less than 400mm above finished ground level, shall be one of the following -

- (a) Materials that comply with the following:
 - (i) Bearers and joists shall be -
 - (A) non-combustible; OR
 - (B) bushfire-resisting timber (see Appendix F); OR
 - (C) a combination of Items (A) and (B) above.
 - (ii) Flooring shall be -
 - (A) non-combustible; OR
 - (B) bushfire-resisting timber (see Appendix F); OR
 - (C) timber (other than bushfire-resisting timber), particleboard or plywood flooring where the underside is lined with sarking-type material or mineral wool insulation; OR
 - (D) a combination of any Items (A), (B) or (C) above.
- OR
- (b) A system complying with AS1530.8.1

This standard does not provide construction requirements for elements of elevated floors, including bearers, joists and flooring, if the underside of the element is 400mm or more above finished ground level.

5.4.1 WALLS

The exposed components of an external wall that is less than 400 mm from the ground or less than 400 mm above decks, carport roofs, awnings and similar fittings having an angle of less than 18 degrees to the horizontal and extending more than 110 mm in width from the wall (see Figure D3, Appendix D) shall be:

- (a) Non-combustible material.
NOTE: Examples include, but are not limited to, the following (with a minimum of 90 mm inthickness):
 - (i) Full masonry or masonry veneer walls with an outer leaf of clay, concrete, calcium silicate or natural stone.
 - (ii) Precast or in situ walls of concrete or aerated concrete.
 - (iii) Earth wall including mud brick. OR

- (b) Timber logs of a species with a density of 680kg/m³ or greater at a 12 percent moisture content; of a minimum nominal overall thickness of 90mm and a minimum thickness of 70mm (see Clause 3.11); and gauge planed. OR
- (c) Cladding that is fixed externally to a timber-framed or a steel-framed wall that is sarked on the outside of the frame and is -
 - (i) non-combustible material; OR
 - (ii) fibre cement a minimum of 6mm in thickness; OR
 - (iii) bushfire-resisting timber (see Appendix F); OR
 - (iv) a timber species as specified in Paragraph E1, Appendix E; pr
 - (v) a combination of any of Items (i), (ii), (iii) or (iv) above. OR
- (d) A combination of any items (a), (b) or (c) above.

5.4.2 JOINTS

All joints in the external surface material of walls shall be covered, sealed, overlapped, backed or butt-jointed.

5.4.3 VENTS AND WEEPHOLES

Except for exclusions provided in Clause 3.6, vents and weepholes in external walls shall be screened with a mesh made of corrosion-resistant steel, bronze or aluminium.

5.5.1 BUSHFIRE SHUTTERS

Where fitted, bushfire shutters shall comply with Clause 3.7 and be made from -
(a) non-combustible material; OR
(b) a timber species as specified in Paragraph E1, Appendix E; OR
(c) bushfire-resisting timber (see Appendix F); OR
(d) a combination of Items (a), (b) and (c) above.

5.5.2 SCREENS FOR WINDOWS AND DOORS

Where fitted, screens for windows and doors shall have a mesh or perforated sheet made of corrosion-resistant steel, bronze or aluminium.

The frame supporting the mesh or perforated sheet shall be made from -
(a) metal; OR
(b) bushfire-resisting timber (see Appendix F); OR
(c) a timber species as specified in Paragraph E2, Appendix E.

5.5.3 WINDOWS AND SIDELIGHTS

Window assemblies shall:
(a) be completely protected by a bushfire shutter that complies with Clause 3.7 and clause 5.5.1; OR
(b) Be completely protected externally by screens that conform with Clause 3.6 and Clause 5.5.2
(c) Conform with the following:

- (i) Frame material For window assemblies less than 400mm from the ground or less than 400mm above decks, carport roofs, awnings and similar elements or fittings having and angle less than 18 degrees to the horizontal and extending more than 110mm in width from the window frame (see Figure D3, Appendix D), window frames and window joinery shall be made from:
 - (A) Bushfire-resisting timber (see Appendix F) OR
 - (B) A timber species as specified in Paragraph E2, Appendix F); OR
 - (C) Metal. OR
 - (D) Metal-reinforced uPVC. The reinforcing members shall be made from aluminium, stainless steel, or corrosion-resistant steel.
- There are no specific restrictions on frame material for all other windows.
- (ii) Hardware There are no specific restrictions on hardware for windows.
- (iii) Glazing Where glazing is less than 400mm from the ground or less than 400mm above decks, carport roofs, awnings and similar elements or fittings having and angle less than 18 degrees to the horizontal and extending more than 110mm in width from the window frame (see Figure D3, Appendix D), this glazing shall be Grade A safety glass a minimum of 4mm in thickness or glass blocks with no restriction on glazing methods.

NOTE: Where double-glazed assemblies are used above, the requirements apply to the external pane of the glazed assembly only. For all other glazing, annealed glass may be used in accordance with AS 1288.
(iv) Seals and weather strips There are no specific requirements for seals and weather strips at this BAL level.
(v) Screens The openable portions of windows shall be screened internally or externally with screens that conform with Clause 3.6 and Clause 5.5.2.

C5.5.3 For Clause 5.5.3(c), screening of the openable portions of all windows is required in all BAL's to prevent the entry of embers to the building when the window is open.
For Clause 5.5.3 (c)(v), screening of the openable and fixed portions of some windows is required to reduce the effects of radiant heat on some tyes of glass. If the screening is required to reduce the effects of radiant heat on glass, and has to be externally fixed.
For Clause 5.5.3 (c)(v), if the screening is required only to prevent the entry of embers, the screening may be fitted externally or internally.

5.5.4 DOORS SIDE-HUNG EXTERNAL DOORS (including French Doors, Panel Fold and Bi-fold Doors)

Side-hung external doors, including French doors, panel fold and bi-fold doors, shall -
(a) Be protected by bushfire shutters that comply with Clause 3.7 and Clause 5.5.1.

- OR
- (b) Be protected externally by screens that comply with Clause 3.6 and Clause 5.5.2.
- OR
- (c) conform with the following:
 - (i) Door panel material Materials shall be -
 - (A) non combustible; OR
 - (B) solid timber, laminated timber or reconstituted timber door, having a minimum thickness of 35mm for the first 400mm above the threshold; OR
 - (C) hollow core, solid timber, laminated timber or reconstituted timber with a non-combustible kickplate on the outside for the first 400mm above the threshold; OR
 - (D) hollow core, solid timber, laminated timber or reconstituted timber protected externally by a screen that complies with Clause 5.5.2; OR
 - (E) for fully framed glazed door panels, the framing is made from metal or bushfire resisting timber (see Appendix F), or a timber species as specified in Paragraph E2, Appendix E or uPVC.
 - (ii) Door frame material Door frames shall be made from:
 - (A) Bushfire-resisting timber (see Appendix F), OR
 - (B) a timber species as specified in Paragraph E2 of Appendix E;

- OR
 - (C) Metal. OR
 - (D) Metal-reinforced PVC-U. The reinforcing members shall be made from aluminium, stainless steel, or corrosion-resistant steel.
 - (iii) Hardware There are no specific requirements for hardwarea at this BAL level.
 - (iv) Glazing the glazing shall be Grade A safety glass a minimum of 4mm in thickness, or glass blocks with no restriction on glazing methods.
- NOTE: Where double glazed units are used the above requirements apply to the external face of the window assembly only.
(v) Seals and weather strips Weather strips, draft excluders or draft seals shall be installed.
(vi) Screens There are no specific requirements for hardwarea at this BAL level.
(vii) Doors shall be tight-fitting to the door frame and to an abutting door, if applicable.

5.5.5 DOORS-SLIDING DOORS

Sliding doors shall:
(a) Be protected by bushfire shutters that comply with Clause 3.7 and Clause 5.5.1.
OR
(b) Be protected externally by screens that comply with Clause 3.6 and Clause 5.5.2.
OR
(c) conform with the following:

- (i) Frame material The material for door frames, including fully framed glazed doors, shall be -
 - (A) Bushfire-resisting timber (see Appendix F). OR
 - (B) a timber species as specified in Paragraph E2 of Appendix E; OR
 - (C) Metal. OR
 - (D) Metal-reinforced uPVC. The reinforcing members shall be made from aluminium, stainless steel, or corrosion-resistant steel.
- (ii) Hardware There are no specific requirements for hardwarea at this BAL level.
- (iii) Glazing Where doors incorporate glazing, the glazing shall be Grade A safety glass a minimum of 4mm in thickness,
- (iv) Seals and weather strips There are no specific requirements for hardwarea at this BAL level.
- (v) Screens There are no specific requirements for hardwarea at this BAL level.
- (vi) Sliding panels Sliding panels shall be tight-fitting in the frames.

5.5.6 DOORS-VEHICLE ACCESS DOORS (GARAGE DOORS)

The following apply to vehicle access doors:
(a) The lower portion of a vehicle access door that is within 400mm of the ground when the door is closed (see Figure D4, Appendix D) shall be made from -

- (i) non combustible material; OR
- (ii) bushfire-resisting timber (see Appendix F); OR
- (iii) fibre- cement sheet, a minimum of 6mm in thickness; OR
- (iv) a timber species as specified in Paragraph E1, Appendix E; OR
- (iv) a combination of any Items (i), (iii) or (iv) above.

(b) All vehicle access doors doors shall be fitted with suitable weather strips, draught seals or brushses. Door assemblies fitted with guide tracks do not need edge gap protection.
NOTES:
1 Refer to AS/NZS 4505 for door types.
2 Gaps of door edges or building elements should be protected as per Section 3.
C5.5.6(b) These guide tracks do not provide a direct passage for embers into the building.
(c) Vehicle access doors with ventilation slots shall be protected in accordance with Clause 3.6.

5.6.1 ROOFS - GENERAL

The following apply to all types of roofs and roofing systems:
(a) Roof tiles, roof sheets and roof-covering accessories shall be non-combustible.
(b) The roof/wall junction shall be sealed, or otherwise protected in accordance with Clause 3.6.
(c) Roof ventilation openings, such as gable and roof vents, shall be fitted with ember guards made of non-combustible material or a mesh or perforated sheet conforming with Clause 3.6 and made of corrosion-resistant steel, bronze or aluminium.
(d) Only evaporative coolers manufactured in accordance with AS/NZS 60335.2.98 shall be used. Evaporative coolers with an internal damper to prevent the entry of embers into the roof space need to be screened externally.

5.6.2 TILED ROOFS

Tiled roofs shall be fully sarked. The sarking shall -
(a) be located on top of the roof framing, except that the roof battens may be fixed above the sarking;
(b) cover the entire roof area including ridges and hips; and
(c) extend into gutters and valleys.

5.6.3 SHEET ROOFS

Sheet roofs shall—
(a) be fully sarked in accordance with Clause 5.6.2, except that foil-backed insulation blankets may be installed over the battens; and
(b) have any gaps sealed at the fascia or wall line and at valleys, hips and ridges by -
(i) a mesh or perforated sheet that conforms with Clause 3.6 and that is made of corrosion-resistant steel, bronze or aluminium; OR
(ii) mineral wool; OR
(iii) other non-combustible material; OR
(iv) a combination of any of Items (i), (ii) or (iii) above.
C5.6.3 - Sarking is used as a secondary form of ember protection for the roof space to account for minor gaps that may develop in sheet roofing.

5.6.4 VERANDA, CARPORT AND AWNING ROOFS

The following apply to veranda, carport and awning roofs:
(a) A veranda, carport or awning roof forming part of the main roof space [see Figure D1(a), Appendix D] shall meet all the requirements for the main roof, as specified in Clauses 5.6.1, to 5.6.6.
(b) A veranda, carport or awning roof separated from the main roof space by an external wall [see Figures D1(b) and D1(c), Appendix D] complying with Clause 5.4 shall have a non-combustible roof covering, except where the roof covering is a translucent or transparent material.
NOTE: There is no requirement to line the inderside of a veranda, carport or awning roof that is separated from the main roof space

5.6.5 ROOF PENETRATIONS

The following apply to roof penetrations:
(a) Roof penetrations, including roof lights, roof ventilators, roof-mounted evaporative cooling units, aerials, vent pipes and supports for solar collectors shall be sealed. The material used to seal the penetration shall be non-combustible.
(b) Openings in vented roof lights, roof ventilators or vent pipes shall conform with Clause 3.6 and be made of corrosion-resistant steel, bronze or aluminium.
NOTE: This requirement does not apply to a room sealed gas appliance. NOTE: A gas appliance designed such that air for combustion dose not enter from, or combustion products enter into, the room which the appliance is located.
(c) All overhead glazing shall be Grade A safety glass complying with AS 1288.
(d) Glazed elements in roof lights and skylights may be of polymer, provided a Grade A safety glass diffuser, complying with AS 1288, is installed under the glazing. Where glazing is an insulating glazing unit (IGU), Grade A toughened safety glass of minimum 4 mm in thickness shall be used in the outer pane of the IGU.
(e) Flashing elements of tubular skylights may be of a fire-retardant material, provided the roof integrity is maintained by an under-flashing of a material having a flammability index not exceeding five..
(f) Evaporative cooling units shall be fitted with non-combustible butterfly closers as close as practicable to the roof level, or the unit shall be fitted with non-combustible covers with a mesh or perforated sheet with a maximum aperture of 2mm, made of corrosion-resistant steel, bronze or aluminium.
(g) Vent pipes made from PVC are permitted.
(h) Eaves lighting shall be adequately sealed and not compromise the performance of the element.

5.6.6 EAVES LININGS, FASCIAS AND GABLES

The following apply to eaves linings, fascias and gables:
(a) Gables shall comply with Clause 5.4.
(b) Eaves penetrations shall be protected the same as for roof penetrations, as specified in Clause 5.6.5.
(c) Eaves ventilation openings shall be fitted with ember guards in accordance with Clause 3.6 and made of corrosion-resistant steel, bronze or aluminium

Joints in eaves linings, fascias and gables may be sealed with plastic joining strips or timber storm moulds.

This standard does not provide construction requirements for fascias, bargeboards and eaves linings.

5.6.7 GUTTERS AND DOWNPIPES

This Standard does not provide material requirements for downpipes. If installed, gutter and valley leaf guards shall be non-combustible. With the exception of box gutters, gutters shall be metal or PVC-U. Box gutters shall be non-combustible and flashed at the junction with the roof with noncombustible material.

5.7.1 VERANDAS, DECKS, STEPS AND LANDINGS - GENERAL

Decking may be spaced.
There is no requirement to enclose the subfloor spaces of verandas, decks, steps, ramps or landings.

C5.7.7 - Spaced decking is nominally spaced at 3 mm (in accordance with standard industry practice); however, due to the nature of timber decking with seasonal changes in moisture content, that spacing may range from 0 - 5 mm during service. It should be noted that recent research studies have shown that gaps at 5 mm spacing afford opportunity for embers to become lodged in between timbers, which may contribute to a fire. Larger gap spacings of 10 mm may preclude this from happening but such a spacing regime may not be practical for a timber deck.

5.7.2 ENCLOSED SUBFLOOR SPACES OF VERANDAS, DECKS, STEPS, RAMPS AND LANDINGS

5.7.2.1 Materials to enclose a subfloor space

This standard does not provide construction requirements for the materials used to enclose a subfloor space except where those materials are less than 400mm from the ground.
Where the materials used to enclose a subfloor space are less than 400mm from the ground, they shall conform with Clause 5.4.

5.7.2.2 Supports
This Standard does not provide construction requirements for support posts, columns, stumps, stringers, piers and poles.

5.7.2.3 Framing
This Standard does not provide construction requirements for the framing of verandas, decks, ramps or landings (i.e., bearers and joists).

5.7.2.4 Decking, stair treads and the trafficable surfaces of ramps and landings
This standard does not provide construction requirements for decking, stair treds and the trafficable surfaces and landings that are more than 300mm from a glazed element.

Decking, stair treads and the trafficable surfaces of ramps and landings less than 300mm (measured horizontally at deck level) from glazed elements that are less than 400mm (measured vertically) from the surface of the deck (see Figure D2, Appendix D) shall be made from -
(a) of non-combustible material; OR
(b) of bushfire-resisting timber (see Appendix F); OR
(c) a timber species as specified in Paragraph E1, Appendix E; or
(d) uPVC; or
(e) a combination of Items (a), (b), (c) or (d).

5.7.3 UNENCLOSED SUBFLOOR SPACES OF VERANDAS, DECKS, STEPS, RAMPS AND LANDINGS

5.7.3.1 Supports
This Standard does not provide construction requirements for support posts, columns, stumps, stringers, piers and poles.

5.7.3.2 Framing
This Standard does not provide construction requirements for the framing of verandas, decks, ramps or landings (i.e., bearers and joists).

5.7.3.3 Decking, stair treads and the trafficable surfaces of ramps and landings
This Standard does not provide construction requirements for deshing, stair treds and the trafficable surfaces of ramps and landings that are more than 300mm from a glazed element.

Decking, stair treads and the trafficable surfaces of ramps and landings less than 300mm (measured horizontally at deck level) from glazed elements that are less than 400mm (measured vertically) from the surface of the deck (see Figure D2, Appendix D) shall be made from -
(a) of non-combustible material; OR
(b) of bushfire-resisting timber (see Appendix F); OR
(c) a timber species as specified in Paragraph E1, Appendix E; or
(d) uPVC; or
(e) a combination of any of Items (a), (b), (c) or (d).

5.7.4 BALUSTRADES, HANDRAILS OR OTHER BARRIERS

This Standard does not provide construction requirements for balustrades, handrails and other barriers.

5.7.5 VERANDA POSTS

Verandah Posts -
(a) Shall be timber mounted on galvanised mounted shoes or stirrups with a clearance of no less than 75mm above adjacent ground level; or
(b) if less than 400mm (measured vertically) from the surface of the deck or ground (see Fig D2, Appendix D) shall be made from -

- (i) non-combustible material;or
- (ii) bushfire-resisting timber (see Appendix F); or
- (iii) a timbers species as specified in Paragraph E1, Appendix E; or
- (iv) a combination of any of items (a) or (b).

5.8 WATER AND GAS SUPPLY PIPES

Above-ground, exposed water and gas supply pipes shall be metal.

SUBJECT TO NCC 2022
(1 MAY 2023)
WATERPROOFING & PLUMBING

PLAN ACCEPTANCE BY OWNER

SIGNATURE: DATE:

SIGNATURE: DATE:

PLEASE NOTE THAT VARIATIONS WILL NOT BE ACCEPTED AFTER THIS PLAN ACCEPTANCE HAS BEEN SIGNED

BAL-12.5 BUSHFIRE REQUIREMENTS
SEE SHEET 1 (COVER SHEET) FOR DETAILS

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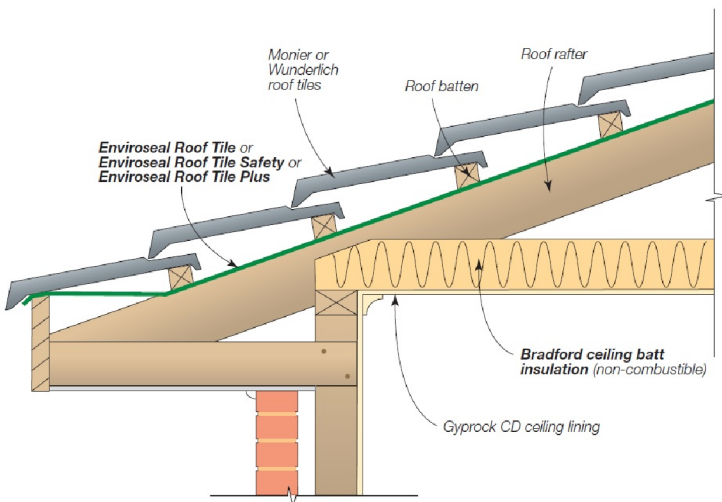


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Rafter Spacing	Product
Up to and including 600mm	EnviroSeal™ Roof Tile or EnviroSeal™ Roof Tile Plus
Over 600mm	EnviroSeal™ Roof Tile Safety

Figure 5.1. Tiled Roofs

- Install EnviroSeal roof tile sarking on top of the roof framing and below the roof battens.
- For further fixing details contact CSR technical support.



Application	Product
Sarking	EnviroSeal™ Resiwrap
Foil faced insulation blanket	Bradford Anticon™
Gap seal	Bradford Fireseal BAL 12.5 - 40 Blanket

Figure 5.2.1. Fascia Detail – Metal Roof (BAL12.5-40)

- Install EnviroSeal Resiwrap to the entire roof area over the top of the battens.
- Immediately above the fascia install BAL12.5 – 40 Blanket extending up the roof and over the first batten. Compress with the roof sheeting.
- For further fixing details contact CSR technical support.

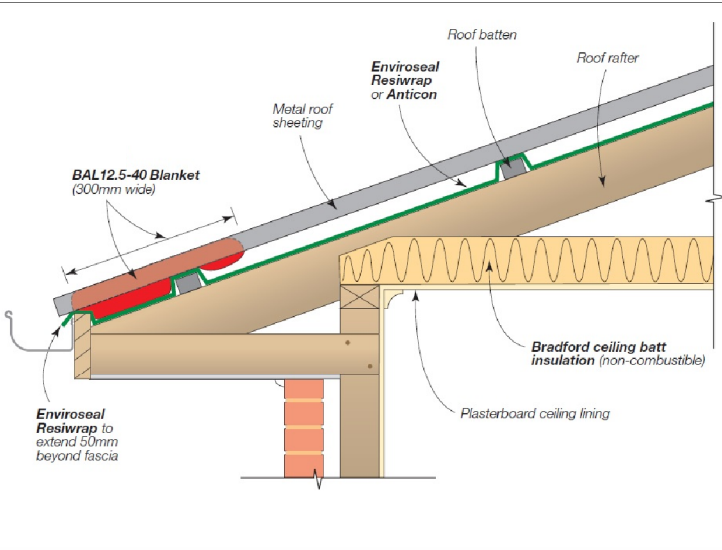


Figure 5.2.2. Valley Detail – Steel Roof (BAL-12.5 – BAL-40)

- Install EnviroSeal Resiwrap to the entire roof area over the top of the battens.
- BAL12.5 – 40 Blanket to be laid over the top of the sarking extending into the valley gutter. Compress with roof sheeting.
- For further fixing details contact CSR technical support.

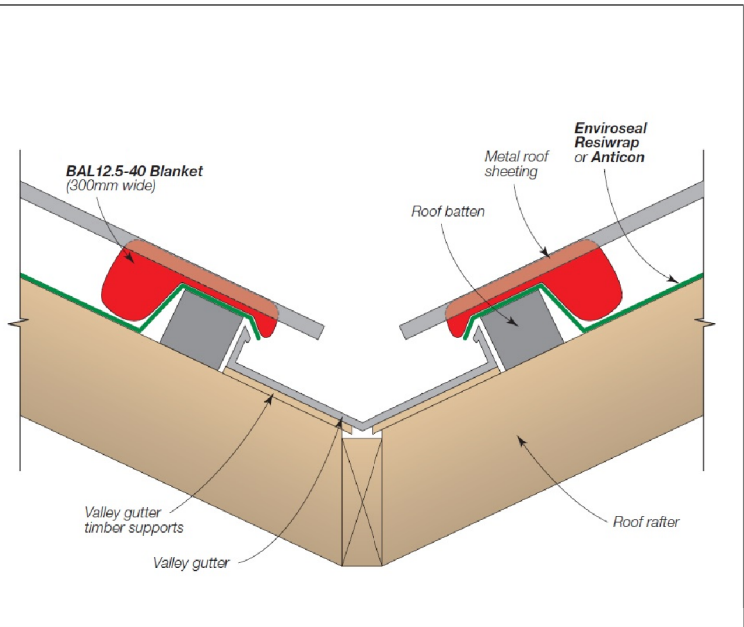


Figure 5.2.3. Barge Detail – Steel Roof (BAL-12.5 – BAL-40)

- Install EnviroSeal Resiwrap to the entire roof area over the top of the battens.
- At barge install BAL12.5 – 40 Blanket and compress with roof sheeting.
- For further fixing details contact CSR technical support.


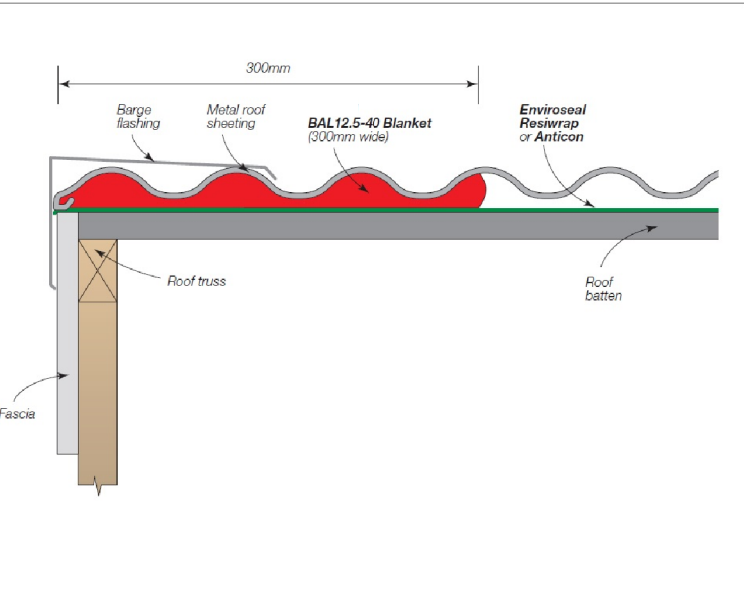


Figure 5.2.4. Hip/Ridge Detail – Steel Roof (BAL-12.5 – BAL-40)

- Install EnviroSeal Resiwrap to the entire roof area over the top of the battens.
- At the ridge/hip lay BAL12.5 – 40 Blanket over the gap between the roof sheets and compress with the ridge capping to the roof profile.
- For further fixing details contact CSR technical support.

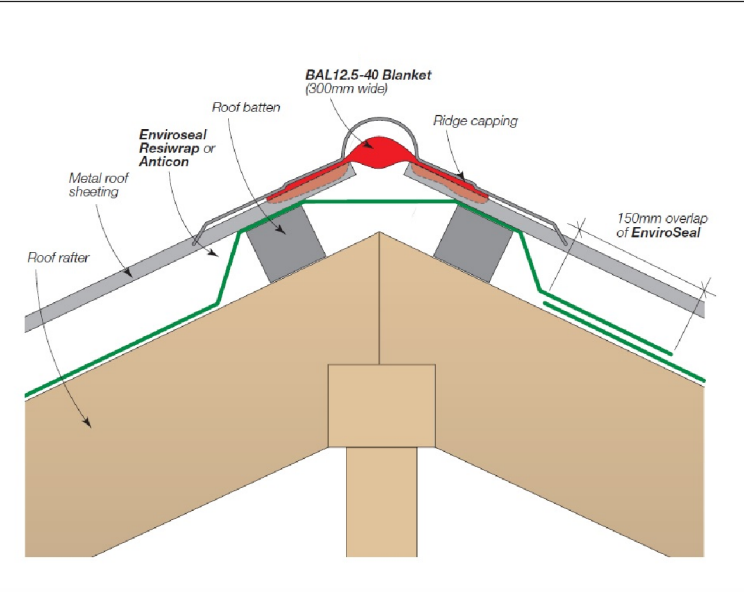

Details for the purpose of bushfire proofing only. To be printed in colour.

Images sourced from Bradfords "Bushfire Roofing System", Published 04/11.

BAL-12.5 BUSHFIRE REQUIREMENTS
SEE SHEET 1 (COVER SHEET) FOR DETAILS

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SPECIFICATION: BARN HOUSE COPYRIGHT: © 2025	REVISION		DRAWN		CLIENT: ADDRESS: 18 NAIRN ST, BUCKLAND TAS 7190 LOT / SECTION / CT: 185631 / - / 2 COUNCIL: GLAMORGAN SPRING BAY	HOUSE DESIGN: BARN HOUSE 10B FACADE DESIGN: BARN SHEET TITLE: BAL 12.5 - BAL 40 ROOF DETAILS	SHEET No.: 21 / 21	HOUSE CODE: H-WBH10B10SA FACADE CODE: F-WBH10B10BARN SCALES:	DO NOT SCALE DRAWINGS. USE FIGURED DIMENSIONS ONLY. CHECK AND VERIFY DIMENSIONS AND LEVELS PRIOR TO THE COMMENCEMENT OF ANY WORK. ALL DISCREPANCIES TO BE REPORTED TO THE DRAFTING OFFICE. 714463
	1	DRAFT SALE PLAN - CT1	HMI	06/10/2025					
	2	CT1 - AMENDMENT	HMI	06/10/2025					
	3	PRELIM PLANS - INITIAL ISSUE	TDI	02/11/2025					
	4	PRELIM PLANS - COLOUR UPDATE	TDI	09/12/2025					
	5	PRELIM PLANS - AMENDMENTS	PL1	11/12/2025					



SUBJECT TO NCC 2022
(1 MAY 2023)
WATERPROOFING & PLUMBING

PLAN ACCEPTANCE BY OWNER

SIGNATURE: DATE:

SIGNATURE: DATE:

PLEASE NOTE THAT VARIATIONS WILL NOT BE ACCEPTED AFTER THIS PLAN ACCEPTANCE HAS BEEN SIGNED