

GLAMORGAN/SPRING BAY COUNCIL NOTICE OF PROPOSED DEVELOPMENT

Notice is hereby given that an application has been made for planning approval for the following development:

SITE: 18 Freycinet Drive, Coles Bay

CT 242868/19

PROPOSAL: Extension to Dwelling & Carport

Any person may make representation on the application(s) by letter (PO Box 6, Triabunna) or electronic mail (planning@freycinet.tas.gov.au) addressed to the Chief Executive Officer. Representations must be received before midnight on 08 January 2025.

APPLICANT: Hamish Dingemanse

DATE: **07/11/2025**

APPLICATION NO: DA 2025 / 00197



- **©** 03 6256 4777
- ₼ 03 6256 4774
- admin@freycinet.tas.gov.au
- www.gsbc.tas.gov.au

Application for Planning Approval

Advice:

Use this form for all no permit required, permitted and discretionary planning applications including visitor accommodation, subdivision as well as for planning scheme amendment & minor amendments to permits.

Completing this form in full will help ensure that all necessary information is provided and avoid any delay. The planning scheme in clause 6.0 provides details of other information that may be required. A checklist of application documents is provided on page 4 of this form.

Often, it is beneficial to provide a separate written submission explaining in general terms what is proposed and why and to justify the proposal against any applicable performance criteria.

If you have any queries with the form or what information is required, please contact the office.

Details of Applicant and Owner								
Applicant:								
Contact perso	on: (if diff	erent from applicant)						
Address:								
Suburb:				Post Code:				
Email:				Phone: / Mobile:				
Note: All corre	sponden	ce with the applicant will	be via ei	mail unless otherwi	se advised			
Owner (if diff	erent fro	m applicant)						
Address:			•					
Suburb:				Post Code:				
Email:				Phone: / Mobile:				
Details of Site	e (Note: I	f your application is discr	etionary,	the following will l	be placed on public exhibition)			
Address of pr	oposal:							
Suburb:			Post Code:					
Size of site: (m ² or Ha)								
Certificate of Title(s):								
Current use o	of site:							



- **©** 03 6256 4777
- **△** 03 6256 4774
- admin@freycinet.tas.gov.au
- www.gsbc.tas.gov.au

General Application Details Complete for A	All Applications	
Description of proposed use or development:		
Estimated value of works: (design & constr The estimated cost is to include the cost of labor	401.011,	\$
current industry pricing and is to include GST.	our and materials using	
You may be required to verify this estimate.		
Is the property on the State Heritage Regis	ter? (Circle one)	Yes / No
For all Non-Residential Applications		
Hours of Operation		
Number of Employees		
Describe any delivery of goods to and from the site, including the types of vehicles used and the estimated average weekly frequency		
Describe any hazardous materials to be used or stored on site		
Type & location of any large plant or machinery used (refrigeration, generators)		
Describe any retail and/or storage of goods or equipment in outdoor areas		
Personal Information Protection Statemer	nt	

The personal information requested will be managed in accordance with the *Personal Information Protection Act 2004*. The personal information is being collected by Glamorgan Spring Bay Council for the purposes of managing, assessing, advising on, and determining the relevant application in accordance with the *Land Use Planning and Approvals Act 1993*(LUPPA) and other related purposes, including for the purpose of data collection.

The information may be shared with contractors and agents of the Council for this purpose, law enforcement agencies, courts and other organisations and it may also be made publicly available on the Council's website and available for any person to inspect in accordance with LUPAA. If you do not provide the information sought, Council will be unable to accept and/or process your application.



- **©** 03 6256 4777
- **△** 03 6256 4774
- <u>admin@freycinet.tas.gov.au</u>
- www.gsbc.tas.gov.au

Applicant Declaration

I/we hereby apply for planning approval to carry out the use or development described in this application and the accompanying documents and declare that:

- The information in this application is true and correct.
- I/we authorise Council employees or consultants to enter the site to assess the application.
- I/we have obtained all copy licenses and permission from the copyright owner for the publication, communication and reproduction of the application and reports, plans and materials provided as part of the application and for the purposes of managing, assessing, advising on, and determining the application.

I/we authorise the Council to:

- Make available the application and all information, reports, plans, and materials provided with or
 as part of the application in electronic form on the Council's website and in hard copy at the
 Council's office and other locations for public exhibition if and as required;
- Make such copies of the application and all information, reports, plans and materials provided with or as part of the application which are, in the Council's opinion, necessary to facilitate a consideration of the application;
- Publish and or reproduce the application and all information, reports, plans and materials provided with or as part of the application in Council agendas, for representors, referral agencies and other persons interested in the application; and
- provide a copy of any documents relating to this application to any person for the purpose of assessment or public consultation and agree to arrange for the permission of the copyright owner of any part of this application to be obtained.

You indemnify the Council for any claim or action taken against the Council for breach of copyright in respect of the application and all information, report, plan, and material provided with or as part of the application.

I/We declare that the Owner has been notified of the intention to make this application in accordance with section 52(1) of the Land Use Planning and Approvals Act 1993.

Applicant Signature:	40	Date:	
	U.S.		

Owners Consent required if application is on or affects Council or Crown owned or administered land

I declare that I have given permission for the making of this application for use and/or development.

Council General Manager	///>		Date:	
or delegate Signature:	Soften	(More		
		7		

If land affected by this application is owned or administered by the Crown or Council, then the written permission of the relevant Minister (or their delegate) and/or the General Manager must be provided. For Crown land, a copy of the instrument of delegation must be provided.

It is the applicant's responsibility to obtain any owners consent prior to lodgement. Written requests for Council consent are via the General Manager. Request for Ministerial consent is to be directed to the relevant department.



- **@** 03 6256 4777
- ₼ 03 6256 4774
- admin@freycinet.tas.gov.au
- www.gsbc.tas.gov.au

Checklist of application documents:

		raken from Section 6 of the Flamming Scheme
An	applicat	ion must include:
	any wri signed details a copy plan; ar	d application form; tten permission and declaration of notification required under s.52 of the Act and, if any document is by the delegate, a copy of the delegation; of the location of the proposed use or development; of the current certificate of title for all land to which the permit sought is to relate, including the title and escription of the proposed use or development.
ena aut rele	ble it to hority co evant sta	to the information that is required by clause 6.1.2, a planning authority may, in order to consider an application, require such further or additional information as the planning onsiders necessary to satisfy it that the proposed use or development will comply with any andards and purpose statements in the zone, codes or a specific area plan, applicable to development including:
	a site al (i) (ii) (iii) (iv) (v) (vi) (vii) (viii) (ix) (xi) (xiii) (xiii) (xiv) (xv) where is scale of (xvi) (xviii) (xviii) (xviii) (xviii) (xix) (xxi) (xxi) (xxi)	edule of easements if listed in the folio of the title and appear on the plan, where applicable; nalysis and site plan at a scale acceptable to the planning authority showing, where applicable: the existing and proposed use(s) on the site; topography including contours showing AHD levels and major site features; natural drainage lines, watercourses and wetlands on or adjacent to the site; soil type; vegetation types and distribution including any known threatened species, and trees and vegetation to be removed; the location and capacity and connection point of any existing services and proposed services; the location of easements on the site or connected to the site; existing pedestrian and vehicle access to the site; the location of existing and proposed buildings on the site; the location of existing and proposed buildings on the site; any natural hazards that may affect use or development on the site; proposed roads, driveways, parking areas and footpaths within the site; any proposed open space, common space, or facilities on the site; and proposed subdivision lot boundaries; it is proposed to erect buildings, a detailed layout plan of the proposed buildings with dimensions at a footpath is site; the private open space for each dwelling; external storage spaces; parking space location and layout; major elevations of every building to be erected; the relationship of the elevations to existing ground level, showing any proposed cut or fill; shadow diagrams of the proposed buildings and adjacent structures demonstrating the extent of shading of adjacent private open spaces and external windows of buildings on adjacent sites; and

(xxiii) materials and colours to be used on roofs and external walls.



RESULT OF SEARCH

RECORDER OF TITLES

Issued Pursuant to the Land Titles Act 1980



SEARCH OF TORRENS TITLE

VOLUME 242868	FOLIO 19
EDITION 5	DATE OF ISSUE 12-Jan-2021

SEARCH DATE : 05-Nov-2025 SEARCH TIME : 05.55 PM

DESCRIPTION OF LAND

Town of COLES BAY Lot 19 on Plan 242868

Derivation: Whole of Lot 19 Sec F Gtd to R Standage

Prior CT 3960/63

SCHEDULE 1

M605149

SCHEDULE 2

Reservations and conditions in the Crown Grant if any E245994 MORTGAGE to Westpac Banking Corporation Registered 12-Jan-2021 at noon

UNREGISTERED DEALINGS AND NOTATIONS

No unregistered dealings or other notations



FOLIO PLAN

RECORDER OF TITLES





CS-D 43

ANNEXURE TO CERTIFICATE OF TITLE

VOL. 3960 **FOL.** 63

ACTING DEPUTY Recorder of Titles

REGISTERED NUMBER

242868

Lot 19 of this plan consists of all the land comprised in the above-mentioned cancelled folio of the Register.

Whole of Lot 19 Sec.F Gtd. to R. Standage Meas. in Metres + 100

TWN. COLES BAY




Search Date: 05 Nov 2025

Search Time: 05:59 PM

Volume Number: 242868

Revision Number: 01

Page 1 of 1

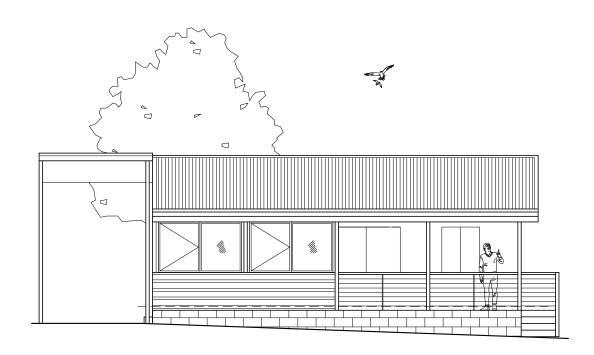

E.F & C.A DINGEMANSE PROPOSED EXTENSION TO RESIDENCE 18 FREYCINET DRIVE COLESBAY 7215

Job Number: 25DIN1

Issue: A2- For all Approvals

DRAWING SCHEDULE

- A01 COVER PAGE
- A02 ENSISTING FLOOR/ ELEVATIONS
- A03 SITE / SERVICES PLAN
- A05 PROPOSED FLOOR PLAN
- A05 SECTION/ CONSTRUCTION NOTES
- A06 ELEVATIONS
- A07 GLAZING/ VENTILATION/ REFLECTED CEILING
- **A08- ROOF DETAIL**
- A09 WET AREA DETAILS 1
- A10 WET AREA DETAILS 2
- A11 ONSITE WASTE WATER SYSTEM (Plan by Others)

Site Information

one information		
Land Title Reference:	242868/19	Certificate folio and volume
Property ID:	5289456	
Wind Classification:	N2 (Adopted)	Attached Site Classification to AS 4055-2006
Soil Classification:	H1 (Adopted)	Attached Site Classification to AS 2870-2011
Climate Zone:	7	www.abcb.gov.au map
BAL Level	19	Bushfire Hazard Report— Nova Land Consulting
Alpine Area:	NA	NCC Vol.2 2022 Schedule1 Glossary Fig. 3 and Table 2
Corrosion Environment:	NA	For steel subject to the influence of salt water, breaking surf or heavy industrial areas, refer to NCC Vol.2 2022 section 6.3.9 & AS 4100. Cladding and fixings to manufacturer's specifications.
Other Hazards:	NA	High wind, earthquake, flooding, landslipe, dispersive soils sand dunes, mine subsidence, landfill, snow & ice or other relevant factors
Current Enclosed Area: Current Balcony/Deck Area:	79.7 sq.m 42.1 sq.m	
New Enclosed Area: New Alfresco Area: Carport Area :	121.0 sq.m 38.9 sq.m 33.0 sq.m	

THIS PLAN HAS BEEN DRAWN BY THIS DESIGNER TO COMPLY WITH THE NATIONAL CONSTRUCTION CODE OF AUSTRALIA (NCC Vol.2). AND ALL REQUIREMENTS OF LOCAL AUTHORITIES. USE ONLY FIGURED DIMENSIONS. DO NOT SCALE. NO WORK SHOULD COMMENCE UNTIL LOCAL AUTHORITIES HAVE APPROVED THE BUILDING APPLICATION. THE DESIGNER DOES NOT ACCEPT ANY RESPONSIBILITY FOR MISCONSTRUCTION OR INTERPRETATION. ALL WORK SHOULD BE IN CONJUNCTION WITH ANY STRUCTURAL ENGINEERS CERTIFICATES. CONTRACTORS SHOULD ENSURE ALL WORK IS CLEAR OF EXISTING SERVICES WHETHER SHOWN ON DRAWINGS OR NOT. SERVICES SHOULD BE LOCATED IN CONJUNCTION WITH RELEVANT AUTHORITIES.

PRINT DATE:

1:200 (A3) Check dimensions.


drawing no: A01DRAWN BY: ME

Dimensions take precedence over scale | SHEET NO. : 1 Of 1



Mob. 0407071492 mdebuildinadesians@ ABN 62650579624

DATE: DESCRIPTION: OCT. 2025 FOR TENDERS AND ALL APPROVALS NOV. 2025 FIR- Glamorgan Spring Bay Council

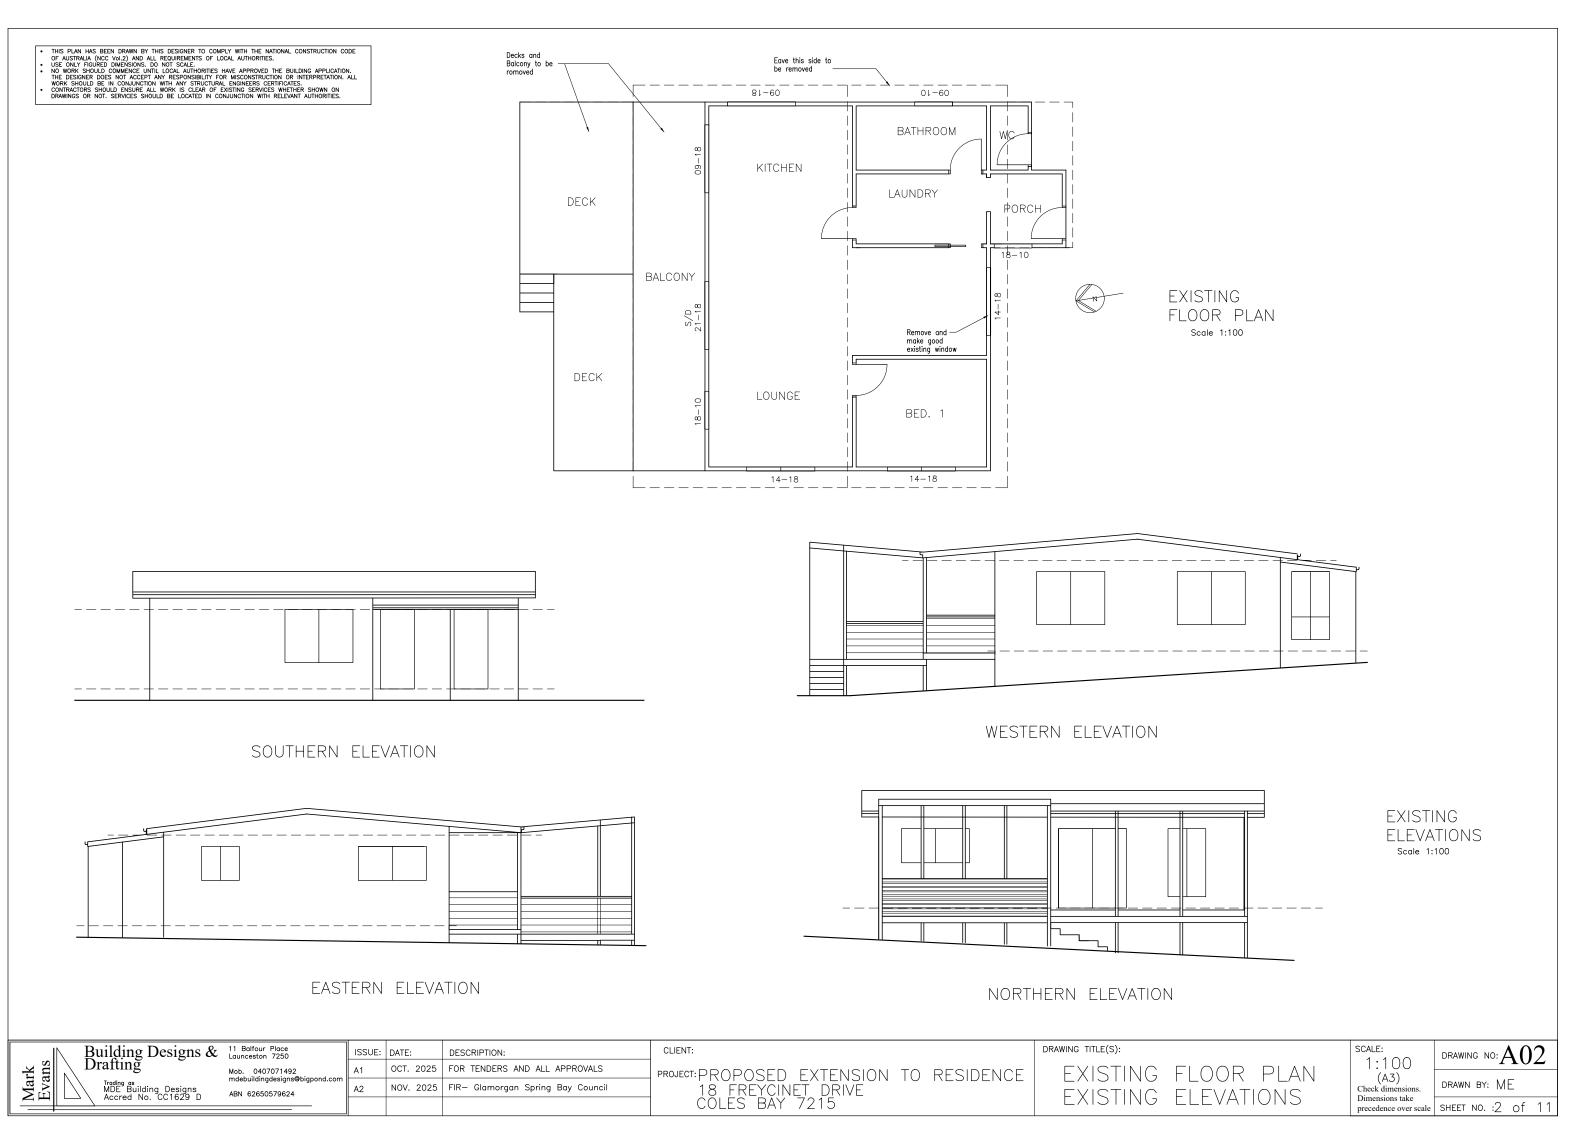

ALL DRAINAGE WORK SHOWN IS PROVISIONAL ONLY AND IS SUBJECT TO AMENDENT TO COMPLY WITH LOCAL AUTORITIES. ALL WORK IS TO COMPLY WITH AS—3500 AND LOCAL PLUMBING CODE AND MUST BE CARRIED OUT BY A LICENSED PLUMBER DOWNPIPES - 90 dia STORMWATER-100 dia PVC AT 1:100 GRADIENT MIN. SEWER - 100 dia. PVC AT 1:60 GRADIENT MIN. ____ STORMWATER SEWERAGE

All works are to be in accordance with the Water Supply Code of Australia WSA 03-2011-3.1 Version 3.1 MRWA Edition V2.0 and Sewerage Code of Australia Melbourne Retail Water Agencies Code WSA 02-2014-3.1 MRWA Version 2/ WSA 02-2002 Version 2.3 MRWA Edition 1.0 and TasWater's supplements to these codes.

COLD WATER
FROM METER TO HOUSE USE 25mm
CLASS 12 POLYETHYLENE. INSIDE HOUSE
USE 20mm CLASS 'B' WITH 12mm CLASS 'B' COPPER BRANCH LINES

HOT WATER
FROM HWC USE USE 18mm CLASS 'B' WITH
15mm COPPER BRANCH LINES TO FIXTURES. INSTALL 'RMC' OR EQUAL TEMPERING VALVE SET TO 50 deg. C

HOT WATER SUPPLY SYSTEM DESIGNED AND INSTALLED IAW AS/NZS 3500.

LEGEND OF DIAMETERS TROUGH = 50mm

SINK = 50mmBATH = 40mmBASIN = 40mmSHOWER = 50mm

WC = 100mm

LEGEND B - BASIN Ba - BATH

S - SINK T - LAUNDRY TUB

SH - SHOWER
WC - WATER CLOSET
FW - FLOOR WASTE DP - DOWN PIPE

V - VENT IO - INSPECTION OPENING ORG -OVERFLOW RELIEF GULLY

RE - RODDING EYE HWC- HOT WATER CYLINDER X - EXTERNAL TAP

See Sheet A11 for Onsite Waste Water System Design. (Original System 2009 —Plan by Others)

See attached Bushfire Hazard Management Report Nova Land Consulting

THIS PLAN HAS BEEN DRAWN BY THIS DESIGNER TO COMPLY WITH THE NATIONAL CONSTRUCTION CODE OF AUSTRALIA (NCC Vol.2) AND ALL REQUIREMENTS OF LOCAL AUTHORITIES. USE ONLY FIGURED DIMENSIONS, DO NOT SCALE.

NO WORK SHOULD COMMENCE UNTIL LOCAL AUTHORITIES HAVE APPROVED THE BUILDING APPLICATION. THE DESIGNER DOES NOT ACCEPT ANY RESPONSIBILITY FOR MISCONSTRUCTION OR INTERPRETATION. ALL WORK SHOULD BE IN CONJUNCTION WITH ANY STRUCTURAL ENGINEERS CERTIFICATES.

CONTRACTORS SHOULD ENSURE ALL WORK IS CLEAR OF EXISTING SERVICES WHETHER SHOWN ON DRAWINGS OR NOT. SERVICES SHOULD BE LOCATED IN CONJUNCTION WITH RELEVANT AUTHORITIES.

LEGEND & NOTES:

RIVE

REYCINET

EXISTING CROSSOVER

ANY NOTED DISCREPANCIES ON ANY OF THESE DRAWINGS OR DOCUMENTS FOR THIS PROJECT SHOULD BE MADE AWARE TO THE DESIGNER BEFORE ANY FURTHER WORK CONTINUES.

ALL CONSTRUCTION TO COMPLY WITH THE LATEST NATIONAL CONSTRUCTION CODE NCC Vol.2 2022 AND AUSTRALIAN STANDARDS.

ANY ENGINEERS SPECIFICATIONS TAKE PRECEDENT OVER DRAWING NOTES

EXISTING LEVELS

→ NEW LEVELS

CONTOUR INTERVALS = 10 m

CONFIRM ALL DIMENSIONS ON SITE PRIOR TO THE COMMENCEMENT OF WORKS.

PROTECTION MUST BE PROVIDED TO ADJOINING PROPERTIES IN ACCORDANCE WITH BUILDING REGULATIONS.

ENSURE FINISHED FLOOR LEVEL IS 150mm MIN. ABOVE FINISHED GROUND LEVEL.

CLIENT:

SITEWORKS SOIL & WATER MANAGEMENT STRATEGIES

All fixtures (new and existing) directed to existing Septic System to AS3500 and TasWater

Stormwater

directed to

system to

existing

AS3500

Standards. (See Sheet A11)

DRIVEWAY/ TURNING

Layered and compacted

17100

HARDSTAND AREA

gravel

12000

SITE TO BE PREPARED IAW ENGINEERS OR SURVEYORS REPORT IF APPLICABLE.

SITE TO BE EXCAVATED OR FILLED TO INDICATED LEVELS IAW NCC Vol.2 PART 3.2 AND AS3798.

SURFACE DRAINAGE -FINISHED GROUND TO FALL AWAY FROM BUILDING FOR A MINIMUM DISTANCE OF 1000 AT 1:20 MIN. AND TO A POINT WHERE PONDING WILL NOT OCCUR.

VACANT BLOCK

PROPOSED CARPORT

RESIDENCE

DP O

10

WC

<u>EXISTING</u> SHED

PROPOSED

EXTENSION

2845

40.48 m

PROPOSED

ALFRESCO

VACANT BLOCK

(16 Freycinet

Drive)

DP

36.58 m

DOWNPIPES TO BE CONNECTED INTO COUNCIL STORMWATER AS SOON AS ROOF ID INSTALLED.

DRAINAGE WORKS TO BE IAW NCC Vol.2 PART 3.3 AND AS/NZS 3500

INSTALL ANY AG DRAINS PRIOR TO FOOTING EXCAVATION. SEE DRAINAGE PLAN FOR LOCATION.

SURFACE DRAINAGE —FINISHED GROUND TO FALL AWAY FROM BUILDING FOR A MINIMUM DISTANCE OF 1m AT 1:20 MIN. AND TO A POINT WHERE PONDING WILL NOT OCCUR.

PREVENT PONDING OF WATER UNDER SUSPENDED FLOORS.

EXCAVATED MATERIAL PLACED UP—SLOPE OF AG DRAINS. TO BE REMOVED WHEN BUILDING WORKS ARE COMPLETED AND USED AS FILL ON SITE FOR ANY LOW POINTS. INSTALL A SEDIMENT FENCE ON THE DOWNSLOPE SIDE OF MATERIAL.

DRAWING TITLE(S):

SITE/SERVICES PLAN

SCALE: 1:200 (A3) Check dimensions. Dimensions take

drawing no:A03

DRAWN BY: ME precedence over scale SHEET NO. :3 of 11

Building Designs & 11 Balfour Place Launceston 7250 Mark Evans Drafting Trading as MDE Building Designs Accred No. CC1629 D

Mob. 0407071492 ABN 62650579624

ISSUE: DATE: DESCRIPTION: OCT. 2025 FOR TENDERS AND ALL APPROVALS NOV. 2025 | FIR- Glamorgan Spring Bay Council

PROJECT: PROPOSED EXTENSION TO RESIDENCE 18 FREYCINET DRIVE COLES BAY 7215

NOTES:
-ALL DIMENSIONS INDICATED ARE FRAME TO FRAME AND DO NOT ACCOUNT FOR WALL LININGS.

• 240V HARD-WIRED SMOKE DETECTORS ALL INTER-CONNECTED

DO NOT SCALE DRAWINGS-IF ANY DOUBT CONTACT DESIGNER.

ALL DIMENSIONS IN MILLIMETRES UNLESS SPECIFIED

CHECK ALL DIMENSIONS AND VERIFY LEVELS, PRIOR TO SETOUT OR COMMENCEMENT


ANY NOTED DISCREPANCIES ON ANY OF THESE DRAWINGS OR DOCUMENTS REFERRING TO THIS PROJECT SHOULD BE MADE AWARE TO THE DESIGNER BEFORE

ALL CONSTRUCTION TO COMPLY WITH THE LATEST NATIONAL CONSTRUCTION CODE NCC Vol.2 2022 AND AUSTRALIAN STANDARDS.

ENGINEER'S SPECIFICATIONS TAKE PRECEDENT OVER DRAWING NOTES.

ALL BUILDING MATERIALS USED NEED TO MEET RELEVANT CORROSION RESISTANT REQUIREMENTS FOR THE LOCAL ENVIRONMENT AND COMPATIBILITY OF MATERIALS.

ALL PLUMBING AND DRAINAGE TO COMPLY AS3500 AND LOCAL COUNCIL PLUMBING REQUIREMENTS.

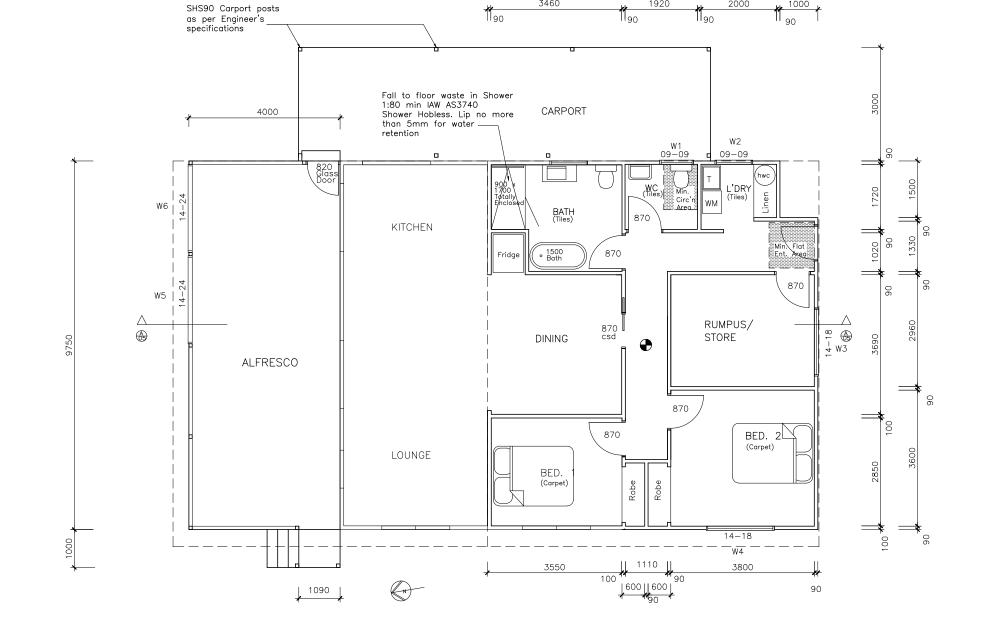

3460

1190

1920

LIVABLE HOUSING DESIGN STANDARD

CONSTRUCTION MUST BE IN COMPLIANCE WITH THESE DRAWINGS AND MEET ALL ASPECTS OF ABCB STANDARD SATISFYING PART H8 AND PART G7 OF NCC 2022- LIVEABLE HOUSING DEIGN.

- 870 wide 35mm doors to habitable rooms allow 820mm openings between door stops.
 Corridor/ hall 1000mm widths min. (Stud to stud allowing 10mm plaster lining and architraves)
- Within the bathroom & WC) wall reinforcement as required in Part H8 NCC Vol.2 to the Shower, Bath and WC walls with 12mm structural ply (min.) or timber noggins 25mm thick (min.)
- Bathroom shower to be hobless, step free entry with lip mot more than 5mm to be provided for water retention purposes.

THIS PLAN HAS BEEN DRAWN BY THIS DESIGNER TO COMPLY WITH THE NATIONAL CONSTRUCTION CODE OF AUSTRALIA (NCC Vol.2) AND ALL REQUIREMENTS OF LOCAL AUTHORITIES. USE ONLY FIGURED DIMENSIONS, DO NOT SCALE.

NO WORK SHOULD COMMENCE UNTIL LOCAL AUTHORITIES HAVE APPROVED THE BUILDING APPLICATION. THE DESIGNER DOES NOT ACCEPT ANY RESPONSIBILITY FOR MISCONSTRUCTION OR INTERPRETATION. ALL WORK SHOULD BE IN CONJUNCTION WITH ANY STRUCTURAL ENGINEERS CERTIFICATES.

CONTRACTORS SHOULD ENSURE ALL WORK IS CLEAR OF EXISTING SERVICES WHETHER SHOWN ON DRAWINGS OR NOT. SERVICES SHOULD BE LOCATED IN CONJUNCTION WITH RELEVANT AUTHORITIES.

Building Designs & 11 Balfour Place Launceston 7250 Drafting Mark Evans

Mob. 0407071492 ABN 62650579624

ISSUE: DATE: DESCRIPTION: OCT. 2025 FOR TENDERS AND ALL APPROVALS NOV. 2025 | FIR- Glamorgan Spring Bay Council

CLIENT: PROJECT: PROPOSED EXTENSION TO RESIDENCE 18 FREYCINET DRIVE COLES BAY 7215

PROPOSED FLOOR PLAN

DRAWING TITLE(S):

SCALE: 1:100 (A3) Check dimension Dimensions take

DRAWING NO: A04DRAWN BY: ME

THIS PLAN HAS BEEN DRAWN BY THIS DESIGNER TO COMPLY WITH THE NATIONAL CONSTRUCTION CODE OF

THIS PLAN HAS BEEN DRAWN BY THIS DESIGNER TO COMPLY WITH THE NATIONAL CONSTRUCTION CODE OF AUSTRALIA (NCC Vol.2) AND ALL REQUIREMENTS OF LOCAL AUTHORITIES WITH STRUCTURE DIMENSIONS. DO NOT SCALE. USE ONLY FIGURED DIMENSIONS. DO NOT SCALE. ON WORK SHOULD COMMENCE UNTIL LOCAL AUTHORITIES HAVE APPROVED THE BUILDING APPLICATION. THE DESIGNER DOES NOT ACCEPT ANY RESPONSIBILITY FOR MISCONSTRUCTION OR INTERPRETATION. ALL WORK SHOULD BE IN CONJUNCTION WITH ANY STRUCTURAL BENGINEERS CERTIFICATES. WHETHER SHOWN ON DRAWING OR NOT. SERVICES SHOULD BE LOCATED IN CONJUNCTION WITH ARE EVANT AUTHORITIES.

EXTEND AND BRACE EXISTING WALLS RAFTERS OF NEW RAISED ROOF 120x35 TO SUPPORT NEW ROOF RAFTERS HySPAN LVLs AT 900 ctrs. MAX. R4.0 INSULATION TO CEILING 9 deg. COLORBOND CUSTOM ORB ROOFING. 10 deg. 70x35 F17 HWD ROOF BATTENS AT 900 CRS. MAX. -RIDGE BEAM 120x35 HySPAN LVL EXISTING ROOF DOUBLE TOP PLATES TO ALL PERIMETER AND LOAD BEARING WALLS. SELECTED PLASTER CORNICES.
RONDO 129 FURRING CHANNELS AT 450ctrs. EXTERNAL WALLS R2.5 INSULATION TO 10mm PLASTERBOARD WALL AND EXTERNAL WALLS. CEILING VILLABOARD TO WET AREAS EXTERNAL WALLS WITH PERMEABLE BUILDING FABRIC TO GIVE MIN R2.8. RUMPUS **ALFRESCO** DINING HALL LOUNGE SELECTED SKIRTINGS & ARCHITRAVES Existing Slab Floor EXTENSION SLAB DETAIL TO **ENGINEERS SPECIFICATIONS**

SECTION AA

ALL WORK SHALL BE IN ACCORDANCE & COMPLY WITH THE NATIONAL CONSTRUCTION CODE (NCC) Vol 2, COUNCIL BY-LAWS, RELEVANT AUSTRALIAN STANDARDS AND CURRÈNT WORKPLACE STANDARDS CODES OF PRACTICE.

DO NOT SCALE DRAWINGS—IF ANY DOUBT CONTACT DESIGNER. • ALL DIMENSIONS IN MILLIMETRES UNLESS SPECIFIED.

- CHECK ALL DIMENSIONS AND VERIFY LEVELS, PRIOR TO SETOUT OR COMMENCEMENT OF ANY
- ANY NOTED DISCREPANCIES ON ANY OF THESE DRAWINGS OR DOCUMENTS REFERRING TO THIS PROJECT SHOULD BE MADE AWARE TO THE DESIGNER BEFORE ANY FURTHER WORK CONTINUES. ALL CONSTRUCTION TO COMPLY WITH THE LATEST NATIONAL CONSTRUCTION CODE (NCC Vol.2) AND

-NEW ALFRESCO SLAB AND BLOCK RETAINING WALL

DETAIL TO ENGINEERS **SPECIFICATIONS**

- ENGINEER'S SPECIFICATIONS TAKE PRECEDENT OVER DRAWING NOTES.
 ALL BUILDING MATERIALS USED NEED TO MEET RELEVANT CORROSION RESISTANT REQUIREMENTS
 FOR THE LOCAL ENVIRONMENT AND COMPATIBILITY OF MATERIALS.
 ALL PLUMBING AND DRAINAGE TO COMPLY AS3500 AND LOCAL COUNCIL PLUMBING REQUIREMENTS.
- SITE TO BE PREPARED IAW ENGINEERS OR SURVEYORS REPORT IF APPLICABLE
- SITE TO BE EXCAVATED OR FILLED TO INDICATED LEVELS IAW WITH NCC Vol.2 2022 3.2 AND AS3798.
- DRAINAGE WORKS TO BE IAW NCC Vol.2 2022 PART 3.3 AND AS/NZS 3500 SURFACE DRAINAGE —FINISHED GROUND TO FALL AWAY FROM BUILDING FOR
- A MINIMUM DISTANCE OF 1m AT 1:20 MIN. AND TO A POINT WHERE PONDING WILL NOT OCCUR.
- PREVENT PONDING OF WATER UNDER ANY SUSPENDED FLOORS.
- GENERALLY TO BE IAW WITH AS4100-STEEL STRUCTURES AND
- AS1544-WELDING IN BUILDING.
 STEELWORK TO BE COATED WITH ANTI-OXIDISING PAINT PRIOR TO
- ALL STEEL IN EXPOSED CONDITIONS TO BE GALVANISED OR PROPRIETARY GALVANISED PRODUCT.
- ANY STRUCTURAL STEEL FRAMING TO BE IAW NCC VOL.2 Part 6.3, AS1250, AS4100, MANUFACTURERS SPECIFICATIONS AND STRUCTURAL ENGINEERS DESIGN AND SPECIFICATIONS.

- GENERALLY MASONRY WALLS TO BE CONSTRUCTED IN ACCORDANCE WITH NCC VOL.2 2020 PART 5 & AS3700.
- MASONRY VENEER TO NCC VOL.2 2020 PART 5.2, CAVITY MASONRY TO NCC VOL.2 2020 PART 5.3,
- UNRENFORCED LEAF MASONRY TO NCC VOL.2 2020 PART 5.4,
- ISOLATED PIERS TO NCC VOL.2 2020 PART 5.5 and
- MASONRY COMPONENTS AND ACCESSORIES TO NCC VOL.2 2020 PART 5.6

WALL FRAMING

- ALL TIMBER FRAMING TO COMPLY WITH AS1684.2, NCC Vol.2 2022 PART 6.1, ANY ENGINEERS DETAILS, MATERIAL SUPPLIERS SPECS AND LOCAL COUNCIL REQUIREMENTS.
- HARDWOOD MINIMUM STRESS GRADE F17 SOFTWOOD MINIMUM STRESS GRADE MGP10,
- TIMBER STUDS: 90x35 MPG 10 STRUC. PINE OR 90x35 F17 HWD AT
- 450 ctrs TOP AND BOTTOM PLATES & NOGGINS: 90x35 MPG 10 STRUC. PINE
- OR 90x35 F17 HWD. BRACING OF TIMBER CONSTRUCTION TO BE IAW SECTION 8 OF
- AS1684.2 AND ANY ENGINEERS SPECIFICATIONS
 TIE-DOWN OF TIMBER FRAME TO BE IN ACCORDANCE WITH SECTION 9 OF AS1684.2, AS4055 AND ENGINEER'S SPECIFICATIONS.
- LINTELS AS PER WINDOW SCHEDULE AND/ OR TRUSS MANUFACTURER TAKING INTO ACCOUNT WHERE GIRDER TRUSSES ETC, ARE LOCATED.

EXTERIOR WALL CLADDING

- GENERALLY IAW NCC Vol.2 2022 PART 7
 ANY EXTERNAL TIMBER CLADDING TO BE FIXED IAW MANUFACTURERS **SPECIFICATIONS**
- IF APPLICABLE WEATHERBOARDS AND CHAMFERBOARDS TO BE PRIMED

CLIENT:

- VAPOR PERMEABLE SARKING TO BE PROVIDED BETWEEN EXTERNAL WALL CLADDING AND FRAMING.
- WALL CLADDING TO BE IAW MANUFACTURERS SPECIFICATIONS. FLASHINGS TO WINDOW/DOOR OPENINGS ARE TO AS290

ELECTRICAL

- ALL WIRING, LIGHTING, ELECTRICAL OUTLETS AND FIXTURES
- MUST BE INSTALLED BY A LICENCED PRACTITIONER.

 ALL LIGHTING AND ELECTRICAL FITTINGS AND FIXTURES AS PRESCRIBED BY OWNER AT TIME OF INSTALLATION.

- THE DOOR OF A FULLY ENCLOSED SANITARY COMPARTMENT MUST OPEN OUTWARDS, SLIDE OR BE READILY REMOVABLE FROM THE OUTSIDE OF THE COMPARTMENT UNLESS THERE IS A CLEAR SPACE OF AT LEAST 1200mm BETWEEN THE CLOSET PAN AND THE NEAREST PART OF THE DOORWAY
- PROVISION OF NATURAL LIGHT TO BE IAW NCC Vol.2 2022 PART 10.4 WINDOWS/ROOFLIGHTS TO PROVIDE LIGHT TRANSMISSION AREA EQUAL TO 10% OF FLOOR AREA OF ROOM
- VENTILATION TO BE IAW NCC Vol.2 2022 PART 10.6 OR AS 1668.2 FOR MECHANICAL VENTILATION. EXHAUST FAN FOR BATHROOM/ WC TO BE VENTED TO OUTSIDE FOR STEEL ROOF AND TO ROOF SPACE FOR TILE ROOF
- NATURAL VENTILATION TO BE PROVIDED AT A RATE OF 5% OF ROOM FLOOR AREA IAW NCC Vol.2 2022 PART 10.6

LIVABLE HOUSING DESIGN STANDARD

CONSTRUCTION MUST BE IN COMPLIANCE WITH THESE DRAWINGS AND MEET ALL ASPECTS OF ABCB STANDARD SATISFYING PART H8 AND PART G7 OF NCC 2022— LIVEABLE HOUSING DEIGN

Note —All ceiling, roof,external wall_& floor insulation nominated in these plans and accompanying Energy rating assessment has been applied only to areas that are connected to external elements (i.e Earth or outside air)

DRAWING TITLE(S):

INTERNAL LINING

- LINE WALLS AND CEILINGS INTERNALLY WITH 10mm PLASTERBOARD SHEETING WITH SELECTED PLASTER CORNICES
- CEILING PLASTER FITTED TO METAL FURRING CHANNELS AT 450 ctrs.
- PLASTERBOARD LINING TO WET AREAS TO BE 'VILLABOARD', W.R BOARD OR OTHER APPROVED WATERPROOF LINING
- ALL EAVE AND SOFFIT LININGS TO BE 'VILLABOARD'. W.R BOARD OR OTHER APPROVED WATERPROOF LINING UNLESS OTHERWISE NOTED. ALL DOORS, WINDOWS, ARCHITRAVES, SKIRTING, WALL AND FLOOR SURFACES AND ALL FITTINGS AND FIXTURES AS PRESCRIBED BY

GENERAL FIRE SAFETY

- GENERALLY TO BE IAW NCC Vol.2 2022 PART 9
- FIRE SEPARATION TO IAW NCC Vol.2 2022 PARTS 9.2, 9.3,9.4 EXTERNAL WALLS AND GABLE ENDS CONSTRUCTED WITHIN 900mm OF BOUNDARY ARE TO EXTEND TO UNDERSIDE OF NON COMBUSTIBLE ROOFING/ EAVES AND ARE TO BE CONSTRUCTED OF A MASONRY SKIN 90mm THÍCK AND WITH AN FRL OF 60/ 60/60.
- SARKING TO HAVE A FLAMMABILITY INDEX LESS THAN 5.
- ROOF LIGHTS NOT TO BE PLACED CLOSER THAN 900 FROM BOUNDARY. SMOKE ALARM INSTALLATION TO BE IAW NCC Vol.2 2022 PART 9.5. AND AS1670, LOCATIONS INDICATED ON FLOOR PLAN.
- INSTALLATION LOCATIONS:

 -CEILINGS- 300 AWAY FROM WALL JUNCTION.

 -CATHEDRAL CEILING- 500 DOWN FROM APEX.

- -WALLS- 300 DOWN FROM CEILING JUNCTION
 HEATING APPLIANCES GENERALLY TO BE IN COMPLIANCE WITH NCC Vol.2 2022 PART 9 AND AS2918 "DOMESTIC SOLID FUEL BURNING APPLIANCE

Building Designs & 11 Balfour Place Launceston 7250 Drafting

Mob. 0407071492 ABN 62650579624


ISSUE: DATE: DESCRIPTION: OCT. 2025 FOR TENDERS AND ALL APPROVALS NOV. 2025 | FIR- Glamorgan Spring Bay Council

PROJECT: PROPOSED EXTENSION TO RESIDENCE 18 FREYCINET DRIVE COLES BAY 7215

SFCTION CONSTRUCTION NOTES SCALE: 1:50 (A3) Check dimensions Dimensions take

DRAWING NO: A(05)

DRAWN BY: ME precedence over scale | SHEET NO. :5 of 11

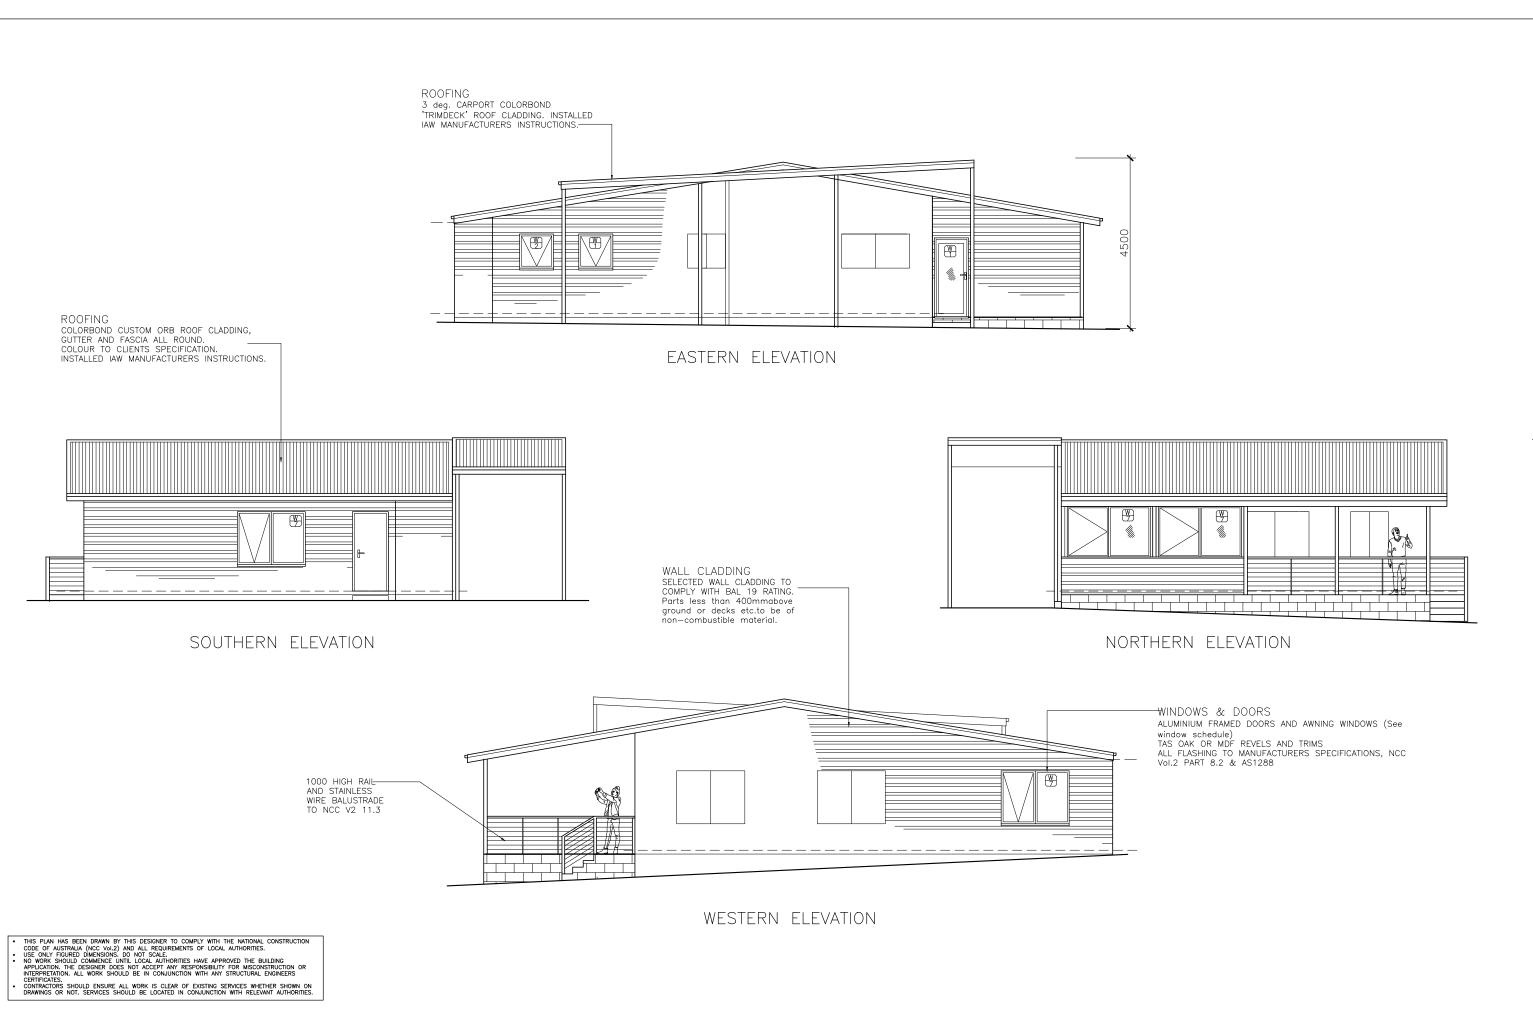

Building Designs & 11 Bolfour Place Launceston 7250 Mob. 0407071492 Mark Evans

Mob. 0407071492 mdebuildingdesigns@bigpond.co ABN 62650579624

ISSUE: DATE: DESCRIPTION: OCT. 2025 FOR TENDERS AND ALL APPROVALS NOV. 2025 | FIR- Glamorgan Spring Bay Council

CLIENT PROJECT: PROPOSED EXTENSION TO RESIDENCE 18 FREYCINET DRIVE COLES BAY 7215

ELEVATIONS

DRAWING TITLE(S):

SCALE: 1:100 (A3) Dimensions take

DRAWING NO:A06DRAWN BY: ME

precedence over scale | SHEET NO. :6 of 11

THIS PLAN HAS BEEN DRAWN BY THIS DESIGNER TO COMPLY WITH THE NATIONAL CONSTRUCTION CODE OF AUSTRALIA (NCC Vol.2) AND ALL REQUIREMENTS OF LOCAL AUTHORITIES.

USE ONLY FIGURED DIMENSIONS. DO NOT SCALE.

NO WORK SHOULD COMMENCE UNTIL LOCAL AUTHORITIES HAVE APPROVED THE BUILDING APPLICATION. THE DESIGNER DOES NOT ACCEPT MAY RESPONSIBILITY FOR MISCONSTRUCTION OR INTERPRETATION. ALL WORK SHOULD BE IN CONJUNCTION WITH ANY STRUCTURAL ENGINEERS CERTIFICATES.

CONTRACTORS SHOULD ENSURE ALL WORK IS CLEAR OF EXISTING SERVICES WHETHER SHOWN ON DRAWINGS OR NOT. SERVICES SHOULD BE LOCATED IN CONJUNCTION WITH RELEVANT AUTHORITIES.

Light Switch(2w=2 way switch) (Dim =dimmer)

 \bigcirc B

 \otimes DL

battery backup.

Track Liahts

Range Hood/ Exhaust Fan

Smoke Alarm —all interconnected, hard wired with

To AS 3786 and Part 3.7.2 of current NCC(Vol2)

Surface mounted batten light fitting with 11W LED

Downlights -IC Rated LED -fitted with approved covers that allow bulk insulation to fully cover.


Natural Light and Ventilation

Minimum 10% of the floor area of a habitable room required (natural light)

PART 3 8 5 VENTILATION

Minimum 5% of the floor area of a habitable room required (An exhaust fan may be used for a sanitary compartment, laundry or bathroom provided contaminated air discharges directly to the outside of the building by way of ducts).

Room	Area (m sq.)		Light Required (m sq.)	Light Achieved (m sq.)	Ventilation Required (m sq.)	Ventilation Achieved (m sq.)
Bedroom 1	9.9	Existing	0.99	2.52	0.50	1.26
Bedroom 2	13.7	W4	1.37	2.52	0.69	1.26
Rumpus	11.2	W3	1.12	2.52	0.56	1.26

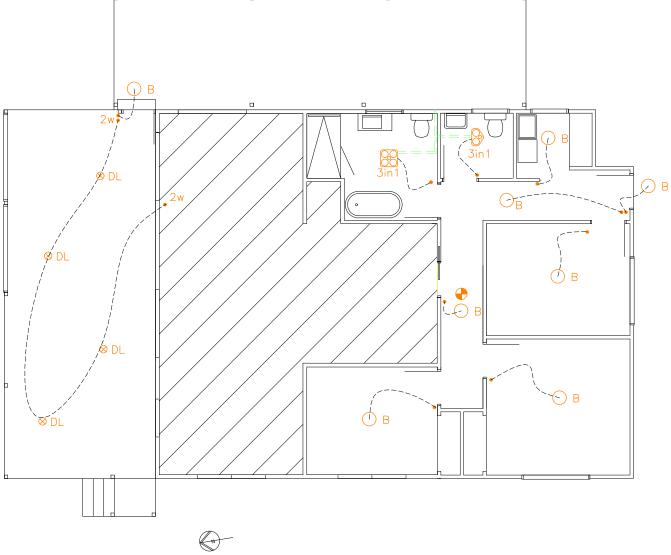

Window Schedule & Glazing Areas

Number	Height	Width	Туре	Room	Area (sq.m)	Orientation	Glass *	Material
W1	900	2100	Awning	Kitchen	1.89	Eastern	Double Glazed Clear	Aluminium
W2	1000	600	Awning	Dining	0.60	Eastern	Double Glazed Clear	Aluminium
D1	2100	2400	Stacker Door (00X)	Dining	5.04	Eastern	Double Glazed Clear	Aluminium
				Totals	7.53			

THE FOUR REPLACEMENT GLAZING ELEMENTS SPECIFIED BELOW ARE DOUBLE GLAZED TO REPLACE THE EXISTING SINGLE GLAZING. THESE ALTERATIONS TO THE EXISTING DWELLING ARE BENEFICIAL TO THE THERMAL PERFORMANCE OF THE BUILDING. SEE ATTACHED GLAZING CALCULATOR.

BUSHFIRE-PRONE AREA BAL RATING- 19 (SEE ATTACHED HAZARD MANAGEMENT PLAN FOR

WINDOW AND DOOR ASSEMBLIES CONSTRUCTION AND FITTING TO COMPLY WITH AS3959-2018-SECTION 5.5

GRADE A SAFETY GLASS MINIMUM 5mm TOUGHENED GLASS WITHIN 400mm OF THE GROUND, DECK etc.

(THIS IS ONLY REQUIRED ON THE EXTERNAL LEAF OF DOUBLE GLAZED UNITS)

OPENABLE PORTIONS OF WINDOWS SHALL BE SCREENED INTERNALLY OR EXTERNALLY WITH SCREENS THAT HAVE A MESH OR PERFORATED SHEET WITH A MAXIMUM APETURE OF 2mm, MADE OF CORROSION RESISTENT STEEL, BRONZE OR ALUMINIUM. GAPS BETWEEN THE PERIMETER OF THE SCREEN ASSEMBLY AND THE BUILDING ELEMENT TO WHICH IT IS FITTED SHALL NOT EXCEED 3mm.

SCREENING SHOULD COMPLY WITH CLAUSE 5.5.3 FOR SPECIFIED SIDE HUNG EXTERNAL DOORS AND CLAUSE 5.5.4 FOR SLIDING DOORS.

EXTERNAL DOORS PROTECTED BY BUSHFIRE SHUTTER OR SCREENED WITH STEEL, BRONZE OR ALUMINIUM MESH OR GLAZED WITH 5 mm TOUGHENED GLASS, NON-COMBUSTIBLE OR 35mm SOLID TIMBER FOR 400mm ABOVE THRESHOLD, METAL OR BUSHFIRE RESISTING TIMBER FRAMED FOR 400mm ABOVE THE GROUND, DECKING, ETC. TIGHT-FITTING WITH WEATHER STRIPS AT BASE.

VEHICLE ACCESS DOORS (GARAGE) COLORBOND PANEL LIFT DOOR WITH BOTTOM WEATHER SEAL AND GUIDE TRACKS WITH MAX. GAP NO LARGER THAN 3mm. NO VENTILATION SLOTS ARE PERMISSABLE.

ADDITION GLAZING REQUIREMENTS

ALL GLAZED WINDOW & DOOR ASSEMBLIES IN EXTERNAL WALLS TO COMPLY WITH NCC (Vol.2) 8.2 & 8.3 AS 2047. ALL OTHER GLASS TO COMPLY WITH AS1288

NEW ADDITION SLIDING DOORS AND WINDOWS ARE DOUBLE GLAZED POWDER COATED ALUMINIUM

FRAMES MDF OR TAS OAK REVEALS.

ALL FLASHINGS AND FASTENINGS TO MANUFACTURERS SPECIFICATIONS.

DIMENSIONS SHOWN IN ELEVATIONS FOR THESE WINDOWS ARE NOMINAL ONLY.

DOORS/ WINDOWS ARE TO BE FABRICATED USING ON-SITE MEASUREMENTS.

ENERGY EFFICIENCY GENERALLY IAW 3.12

CLIMATE ZONE 7 APPLICABLE TO TASMANIA (ZONE 8 APPLICABLE TO ALPINE AREAS). ALL EXHAUST FANS TO BE SELF CLOSING, MAX. 250mm DIA. WINDOW FRAMES TO BE WEATHER STRIPPED.

ALL INSULATION TO BE INSTALLED IN ACCORDANCE WITH AS3999

<u>LIGHTING</u>

LIGHTING LAYOUT IS INDICATIVE ONLY AND SHOULD BE CONFIRMED WITH BUILDING CONTRACTOR AND CLIENT PRIOR TO INSTALLATION, HOWEVER MUST COMPLY WITH MINIMUM ILLUMINATION POWER LOAD ALLOWANCES IN THIS TABLE.

LIGHTING SCHEDULE							
ROOM NAME	FLOOR AREA (sqm)	ALLOWANCE	ILLUMINATION POWER LOAD ALLOWANCE (Watt)				
01- ALFRESCO	38.9	4	156				
02- LOUNGE/KITCH./DINING	49.3	5	247				
03- BATHROOM	8.6	5	43				
04- WC	3.3	5	17				
05- LAUNDRY	2.3	5	12				
06- HALL	11.2	5	56				
07- RUMPUS/ STORE	11.2	5	56				
08- BEDROOM 2	13.7	5	69				
04- BEDROOM 3	9.9	5	50				
TOTAL	148.4		703				

Combination light, fan & heat lamp unit (4 4x275W heat lamps (not included in calculation) 1x 15W fluorescent globe. Combination light, fan & heat lamp unit (2 4x275W heat lamps (not included in calculation) 1x 15W fluorescent globe. 3in1 Exhaust ducts to Exterior • Bathroom fans to be fitted with backdraught dampers/ shutters • External lights must be controlled by a daylight sensor (as shown), or have an average light source efficiency of not less than 40 lumens/W • Adjustment of minimum R —Value for loss of ceiling insulation. (NCC Vol.2 2022 13.2) Minimum R-Value of ceiling insulation required to satisfy NCC Vol.2 2022 Table 13.2.3h = R4.5 Total Extension habitable ceiling area (excl. Alfresco): 121.0 sq.m Area of fans/ lights: Percentage of ceiling un-insulated due to light fittings and fans(NCC $Vol.2 \ 2022 \ table \ 13.2) = 0.49\%$ No adjustment of ceiling insulation is required. (if percentage un-insulated is less than 0.5%)



Mob. 0407071492 ABN 62650579624

ISSUE: DATE: DESCRIPTION: OCT. 2025 FOR TENDERS AND ALL APPROVALS Α1 A2 NOV. 2025 | FIR- Glamorgan Spring Bay Council CLIENT:

PROJECT: PROPOSED EXTENSION TO RESIDENCE 18 FREYCINET DRIVE COLES BAY 7215

GLAZING/ VENTILATION DETAILS REFLECTED CELLING PLAN

SCALE: 1:100 (A3) Check dimensions

Dimensions take

DRAWING NO: A07DRAWN BY: ME

precedence over scale SHEET NO. :7 of 11

COMPLIANCE FOR ROOF & ROOFING ELEMENTS WITH AS3959 SECTION 5-CONSTRUCTION FOR BAL 19

ALL ROOF COVERINGS AND ACCESSORIES SHALL BE NON-COMBUSTABLE.

ROOF AND WALL JUNCTIONS SHALL BE SEALED, TO PREVENT OPENINGS GREATER THAN 3mm, EITHER BY THE USE OF FASCIA AND EAVES LININGS OR BY SEALING BETWEEN THE TOP OF THE WALL AND THE UNDERSIDE OF THE ROOF AND BETWEEN THE RAFTERS AT THE LINE OF THE WALL.

ROOF VENTILATION OPENINGS, SUCH AS GABLE AND ROOF VENTS, SHALL BE FITTED WITH EMBER GUARDS MADE OF NON-COMBUSTABLE MATERIAL OR A MESH OR PERFORATED SHEET WITH A MAXIMUM APETURE OF 2mm, MADE OF CORROSION-RESISTANT STEEL, BRONZE OR ALUMINIUM.

140X35 HySpan LVL

CONT. SPAN

VERANDAH BEAM 2400

SPECIFICALLY SHEET ROOF: SHEET ROOF SHALL BE FULLY SARKED. THE SARKING WILL BE LOCATED ON TOP OF THE ROOF FRAMING AND MAY BE INSTALLED OVER THE BATTENS.

SARKING SHALL COVER THE ENTIRE ROOF AREA INCLUDING RIDGES AND HIPS AND EXTEND INTO GUTTERS AND VALLEYS.

ANY GAPS GREATER THAN 3mm (eg UNDER CORRUGATIONS AND RIBS) SHALL BE SEALED AT THE FASCIA OR WALL LINE AND AT VALLEYS, HIPS AND RIDGES BY ANY OR A COMBINATION OF:

- A MESH OR PERFORATED SHEET WITH A MAXIMUM APERTURE OF 2mm, MADE OF CORROSION-RESITANT STEEL. BRONZE OR ALUMINIUM.

- MINERAL WOOL
- OTHER NON-COMBUSTABLE MATERIAL.

ROOF PENETRATIONS ROOF PENETRATIONS SUCH AS ROOF LIGHTS. ROOF VENTILATORS, ROOF-MOUNTED EVAPORATIVE COOLING UNITS, AERIALS, VENT PIPES AND SUPPORTS FOR SOLAR COLLECTORS, SHALL BE ADEQUATELY SEALED AT THE ROOF WITH A NON-COMBUSTIBLE MATERIAL TO PREVENT GAPS GREATER THAN 3mm.

OPENINGS IN VENTED ROOF LIGHTS, ROOF VENTILATORS OR VENT PIPES SHALL BE FITTED WITH EMBER GUARDS MADE FROM MESH OR PERFORATED SHEET WITH A MAXIMUM APERTURE OF 2mm, MADE OF CORROSION-RESISTANT STEEL, BRONZE OR ALUMINIUM. THIS DOES NOT APPLY TO EXHAUST FLUES OF HEATING AND COOKING DEVICES WITH CLOSED COMBUSTION CHAMBERS OR GAS APPLIANCE FLUES.


EAVES LININGS, FASCIAS AND GABLES: EAVES PENETRATIONS SHALL BE PROTECTED AS FOR ROOF PENETRATIONS.

EAVE VENTILATION OPENINGS GREATER THAN 3mm SHALL BE FITTED WITH EMBER GUARDS MADE OF NON-COMBUSTABLE MATERIAL OR MESH OR PERFORATED SHEET WITH A MAXIMUM APERTURE OF 2mm, MADE OF CORROSION-RESISTANT STEEL, BRONZE OR ALUMINIUM.

JOINTS IN EAVES LININGS, FASCIAS AND GABLES MAY BE SEALED WITH PLASTIC JOINING STRIPS OR TIMBER STORM MOULDS.

GUTTERS AND DOWNPIPES: IF INSTALLED, GUTTER AND VALLEY LEAF GUARDS SHALL BE NON-COMBUSTIBLE.

BOX GUTTERS SHALL BE NON-COMBUSTIBLE AND FLASHED AT THE JUNCTION WITH THE ROOF WITH NON-COMBUSTIBLE MATERIAL.

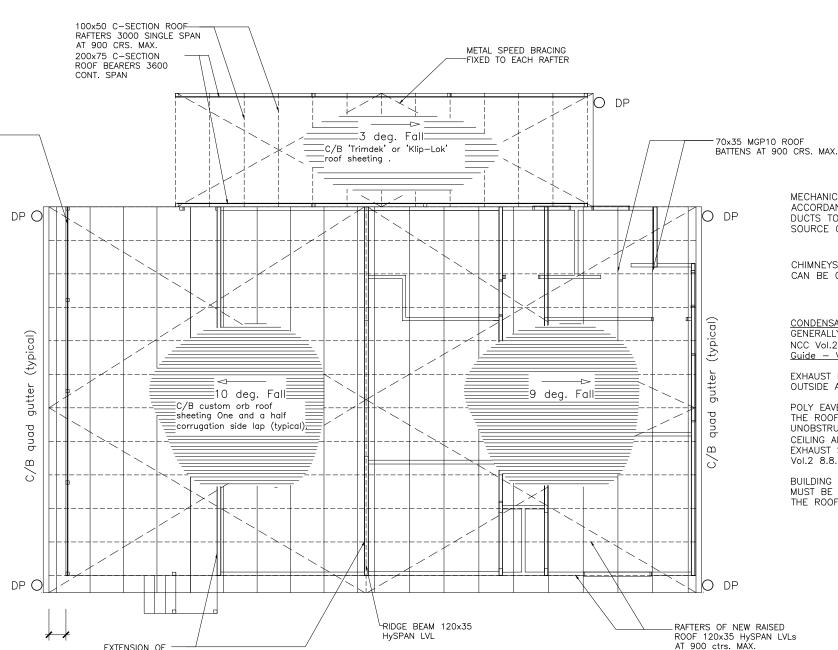

MECHANICAL VENTILATION IS TO BE PROVIDED AND INSTALLED IN ACCORDANCE WITH THE BCA AND MUST BE EXHAUSTED BY WAY OF DUCTS TO THE EXTERIOR OF THE BUILDING IF IT IS THE ONLY SOURCE OF VENTILATION PROVIDED

CHIMNEYS AND FLUES MUST HAVE A DAMPER THAT CAN BE CLOSED TO SEAL THE CHIMNEY OR FLUE.

CONDENSATION DETAILS
GENERALLY ALL CONDENSATION DETAILS TO BE IN ACCORDANCE WITH NCC Vol.2 8.8 and Condensation in Buildings —Tasmanian Designers' Guide - Version 2

EXHAUST FANS FROM BATHROOMS AND EN-SUITES TO BE DUCTED TO OUTSIDE AIR.

POLY EAVE VENTS INSTALLED IF ANY EXHAUST SYSTEM IS DIRECTED TO THE ROOF SPACE. MINIMUM VENT AREA SHOULD BE WITH MINIMUM UNOBSTRUCTED VENT AREA OPENING REQUIRED TO BE A TOTAL CEILING AREA/300 FOR THE 22.5 deg. ROOF PITCH. OTHERWISE EXHAUST SYSTEMS TO BE DISCHARGED DIRECTLY OUTDOORS IAW NCC

BUILDING MEMBRANE USED FOR BUILDING CEILING OF ROOF AND WALLS MUST BE PERMEABLE BUILDING FABRIC. ROOF PERMEABLE FABRIC TO THE ROOF MUST BE LOCATED <u>UNDER THE BATTENS</u>

ROOF CLADDING TO BE GENERALLY IAW NCC VOL.2 PART 7

PLASTIC SHEET ROOFING AS/NZS 4256.1,.2,.3&.5 & AS 1562.3.

COLORBOND ROOF CLADDING ON 70x35 BATTENS AT 900 ctrs.
MAX. AND ANY CONCRETE ROOF TILES ON 50x30 BATTENS AT 330
MAX. BOTH INSTALLED STRICTLY IAW MANUFACTURERS

CAPPING TO MATCH EXISTING AND INSTALLED IAW MANUFACTURERS

GUTTERS AND DOWNPIPES GENERALLY TO BE IAW NCC Vol.2 2022

PART 7.4 & AS/NZS 3500.3.2 & THE TASMANIAN PLUMBING CODE.

LAP GUTTERING 75mm IN DIRECTION OF FLOW, RIVET & SEAL WITH

VALLEY GUTTERS TO BE 145 WIDE COLORBOND STEEL TO MATCH ROOF. TAKE 150mm UNDER ROOF CLADDING AND TURN UP ON BOTH SIDES AND LAPPED 150mm IN DIRECTION OF FLOW.

MAXIMUM SEPARATION OF DOWN PIPES TO BE 12 METRES AND TO BE WITHIN 1000mm OF INTERNAL/VALLEY GUTTER AS TO COMPLY WITH NCC Vol.2 2022 PART 7.4.

FASCIA, GUTTERS AND DOWNPIPES
COLORBOND METAL FASCIA, GUTTERING, FLASHINGS AND RIDGE

VAPOR PERMEABLE SARKING TO BE PROVIDED BETWEEN ROOF

ROOF TILES AS2049 & AS 2050 (N/A) METAL SHEET ROOFING AS 1562.1

FLASHINGS TO NCC Vol.2 2022 Part 7.2

AN APPROVED SILICONE SEALANT.

SPECIFICATIONS

THIS PLAN HAS BEEN DRAWN BY THIS DESIGNER TO COMPLY WITH THE NATIONAL CONSTRUCTION CODE OF AUSTRALIA (NCC Vol.2) AND ALL REQUIREMENTS OF LOCAL AUTHORITIES. USE ONLY FIGURED DIMENSIONS. DO NOT SCALE. NO WORK SHOULD COMMENCE UNTIL LOCAL AUTHORITIES HAVE APPROVED THE BUILDING APPLICATION. THE DESIGNER DOES NOT ACCEPT ANY RESPONSIBILITY FOR MISCONSTRUCTION OR INTERPRETATION. ALL WORK SHOULD BE IN CONJUNCTION WITH ANY STRUCTURAL ENGINEERS CONTRACTORS SHOULD ENSURE ALL WORK IS CLEAR OF EXISTING SERVICES WHITHER SHOWN ON DRAWINGS OR NOT. SERVICES SHOULD BE LOCATED IN CONJUNCTION WITH RELEVANT AUTHORITIES.

Mob 0407071492 ABN 62650579624 ISSUE: DATE: DESCRIPTION: FOR TENDERS AND ALL APPROVALS Α1 Α2

450

CLIENT: PROJECT: PROPOSED EXTENSION TO RESIDENCE 18 FREYCINET DRIVE COLES BAY 7215 DRAWING TITLE(S)

SCALE: 1:100 (A3) Check dimen Dimensions take DRAWING NO: A()8

DRAWN BY: ME

precedence over scale SHEET NO. :8 of 11

ROOFING DETAILS

Building Designs & 11 Balfour Place Launceston 7250 Drafting Trading as MDE Building Designs Accred No. CC1629 D

NOV. 2025 | FIR- Glamorgan Spring Bay Council

EXTENSION OF

EXISTING STUD WALL (See Section A05)

WATERPROOFING AND WATER RESISTANCE REQUIREMENTS FOR BUILDING ELEMENTS IN WET AREAS:

VESSEL OR AREA WHERE THE FIXTURE IS INSTALLED	FLOORS AND HORIZONTAL SURFACES	WALLS	WALL JUNCTIONS AND JOINTS	PENETRATIONS
ENCLOSED SHOWER WITH HOB	WATERPROOF ENTIRE ENCLOSED SHOWER AREA INCL. HOB	WATERPROOF TO NOT LESS THAN 150mm ABOVE THE SHOWER FLOOR SUBSTRATE OR NOT LESS THAN 25mm ABOVE THE MAX RETAINED WATER LEVEL, WHICH EVER IS GREATER, WITH THE REMAINDER BEING WATER RESISTANT TO 1800mm ABOVE THE FFL.	WATERPROOF INTERNAL & EXTERNAL CORNERS & HORIZONTAL JOINTS WITHIN A HEIGHT OF 1800mm ABOVE FLOOR LEVEL AND NOT LESS THAN 40mm WIDTH EITHER SIDE OF THE JUNCTION.	WATERPROOF ALL PENETRATIONS
ENCLOSED SHOWER WITHOUT HOB	WATERPROOF ENTIRE ENCLOSED SHOWER AREA INCL. WATERSTOP	WATERPROOF TO NOT LESS THAN 150mm ABOVE THE SHOWER FLOOR SUBSTRATE WITH THE REMAINDER BEING WATER RESISTANT TO MIN. 1800mm ABOVE THE FFL.	WATERPROOF INTERNAL & EXTERNAL CORNERS & HORIZONTAL JOINTS WITHIN A HEIGHT OF 1800mm ABOVE FLOOR LEVEL AND NOT LESS THAN 40mm WIDTH EITHER SIDE OF THE JUNCTION.	WATERPROOF ALL PENETRATIONS
ENCLOSED SHOWER WITH STEP DOWN	WATERPROOF ENTIRE ENCLOSED SHOWER AREA INCL. THE STEPDOWN	WATERPROOF TO NOT LESS THAN 150mm ABOVE THE SHOWER FLOOR SUBSTRATE OR NOT LESS THAN 25mm ABOVE THE MAX RETAINED WATER LEVEL, WHICH EVER IS GREATER, WITH THE REMAINDER BEING WATER RESISTANT TO 1800mm ABOVE THE FFL.	WATERPROOF INTERNAL & EXTERNAL CORNERS & HORIZONTAL JOINTS WITHIN A HEIGHT OF 1800mm ABOVE FLOOR LEVEL AND NOT LESS THAN 40mm WIDTH EITHER SIDE OF THE JUNCTION.	WATERPROOF ALL PENETRATIONS
ENCLOSED SHOWER WITH PRE-FORMED SHOWER BASE	NOT APPLICABLE	WATER RESISTANT TO A HEIGHT NOT LESS THAN 1800mm ABOVE THE FFL.	WATERPROOF INTERNAL & EXTERNAL CORNERS & HORIZONTAL JOINTS WITHIN A HEIGHT OF 1800mm ABOVE FLOOR LEVEL AND NOT LESS THAN 40mm WIDTH EITHER SIDE OF THE JUNCTION.	WATERPROOF ALL PENETRATIONS
UN-ENCLOSED SHOWERS	WATERPROOF ENTIRE UN-ENCLOSED SHOWER FLOOR	WATERPROOF TO NOT LESS THAN 150mm ABOVE THE SHOWER FLOOR SUBSTRATE OR NOT LESS THAN 25mm ABOVE THE MAX RETAINED WATER LEVEL, WHICH EVER IS GREATER, WITH THE REMAINDER BEING WATER RESISTANT TO 1800mm ABOVE THE FFL.	WATERPROOF INTERNAL & EXTERNAL CORNERS & HORIZONTAL JOINTS WITHIN A HEIGHT OF 1800mm ABOVE FLOOR LEVEL AND NOT LESS THAN 40mm WIDTH EITHER SIDE OF THE JUNCTION.	WATERPROOF ALL PENETRATIONS
AREAS OUTSIDE THE SHOWER AREA FOR CONCRETE AND COMPRESSED FIBRE CEMENT SHEETING	WATER RESISTANT TO ENTIRE FLOOR	NOT APPLICABLE	WATERPROOF ALL WALL/FLOOR JUNCTIONS WHERE A FLASHING IS USED THE HORIZONTAL LEG MUST NOT BE LESS THAN 40mm	NOT APPLICABLE
AREAS OUTSIDE THE SHOWER AREA FOR TIMBER AND PARTICLI BOARD FLOORING	WATER PROOF TO ENTIRE FLOOR	NOT APPLICABLE	WATERPROOF ALL WALL/FLOOR JUNCTIONS WHERE A FLASHING IS USED THE HORIZONTAL LEG MUST NOT BE LESS THAN 40mm	NOT APPLICABLE
AREAS ADJACENT TO BATHS AND SPAS FOR CONCRETE AND COMPRESSED FIBRE CEMENT SHEETING	WATER RESISTANT TO ENTIRE FLOOR	WATER RESITANT TO A HEIGHT OF NOT LESS THAN 150mm ABOVE THE VESSEL AND EXPOSED SURFACES BELOW THE VESSEL UP TO FLOOR LEVEL.	WATERPROOF EDGES OF THE VESSEL AND JUNCTION OF BATH ENCLOSURE WITH FLOOR. WHERE THE LIP OF THE BATH IS SUPPORTED BY A HORIZONTAL SURFACE, THIS AREA MUST BE WATERPROOF FOR SHOWERS OVER A BATH AND WATER RESITANT FOR ALL OTHER CASES.	WATERPROOF ALL TAP & SPOUT PENETRATIONS ONHORIZONTAL SURFACES
AREAS ADJACENT TO BATHS AND SPAS FOR TIMBER AND PARTICLE BOARD FLOORING	WATER PROOF TO ENTIRE FLOOR	WATER RESITANT TO A HEIGHT OF NOT LESS THAN 150mm ABOVE THE VESSEL AND EXPOSED SURFACES BELOW THE VESSEL UP TO FLOOR LEVEL.	WATERPROOF EDGES OF THE VESSEL AND JUNCTION OF BATH ENCLOSURE WITH FLOOR. WHERE THE LIP OF THE BATH IS SUPPORTED BY A HORIZONTAL SURFACE, THIS AREA MUST BE WATERPROOF FOR SHOWERS OVER A BATH AND WATER RESITANT FOR ALL OTHER CASES.	WATERPROOF ALL TAP & SPOUT PENETRATIONS ON HORIZONTAL SURFACES
INSERTED BATHS	N/A FOR FLOOR UNDER BATH. WATERPROOF ENTIRE SHELF AREA INCORPORATING 'WATERSTOP' UNDER THE BATH LIP AND PROJECT NOT LESS THAN 5mm ABOVE THE TILE SURFACE	NOT APPLICABLE FOR WALL UNDER BATH. WATERPROOF TO NOT LESS THAN 150mm ABOVE THE LIP OF THE BATH.	NOT APPLICABLE FOR WALL UNDER BATH	WATERPROOF ALL TAP & SPOUT PENETRATIONS ON HORIZONTAL SURFACES
WALLS ADJOINING OTHER VESSELS (SINKS, TUBS, BASINS)	NOT APPLICABLE	WATER RESISTANT TO A HEIGHT OF NOT LESS THAN 150mm ABOVE THE VESSEL IF THE VESSEL IS WITHIN 75mm OF THE WALL.	WHERE THE VESSEL IS FIXED TO A WALL, WATERPROOF EDGES FOR EXTENT OF THE VESSEL.	WATERPROOF ALL TAP & SPOUT PENETRATIONS ON HORIZONTAL SURFACES
LAUNDRYS & WC'S	WATER RESISTANT TO ENTIRE FLOOR	WATERPROOF ALL WALL/ FLOOR JUNCTIONS TO NOT LESS THAN 25mm ABOVE THE FFL, SEALED TO FLOOR.	WATERPROOF ALL WALL/ FLOOR JUNCTIONS WHERE A FLASHING IS USED THE HORIZONTAL LEG MUST NOT BE LESS THAN 40mm	NOT APPLICABLE

ALL WATERPROOFING USE 'ARDEX' WPM SERIES PRODUCTS (OR SIMILAR) STRICTLY IN ACCORDANCE WITH MANUFACTURERS SPECIFICATIONS AND AS 3740- Waterproofing of Wet Areas within Residential Buildings.

THIS PLAN HAS BEEN DRAWN BY THIS DESIGNER TO COMPLY WITH THE NATIONAL CONSTRUCTION CODE OF AUSTRALIA (NCC Vol.2) AND ALL REQUIREMENTS DESIGNED TO SCALE.

NO WORK SHOULD COMMENOE LINTIL LOCAL AUTHORITIES HAVE APPROVED THE BUILDING APPLICATION. THE DESIGNER DOES NOT ACCEPT ANY RESPONSIBILITY FOR MISCONSTRUCTION OR INTERPRETATION. ALL WORK SHOULD BE IN CONJUNCTION WITH ANY STRUCTURAL ENGINEERS CONTRACTORS SHOULD ENSURE ALL WORK IS CLEAR OF EXISTING SERVICES WHETHER SHOWN ON DRAWINGS OR NOT. SERVICES SHOULD BE LOCATED IN CONJUNCTION WITH RELEVANT AUTHORITIES.

Building Designs & 11 Bolfour Place Launceston 7250 Mob. 040707149

Mob. 0407071492 mdebuildingdesigns@big

ISSUE: DATE: DESCRIPTION: OCT. 2025 FOR TENDERS AND ALL APPROVALS NOV. 2025 | FIR— Glamorgan Spring Bay Council

CLIENT: PROJECT: PROPOSED EXTENSION TO RESIDENCE 18 FREYCINET DRIVE COLES BAY 7215 DRAWING TITLE(S):

WET AREA DETAILS 1


SCALE: N/A (A3) Check dimensions Dimensions take

PRINT DATE:

drawing no: A09


DRAWN BY: ME

SHEET NO. :9 of 11

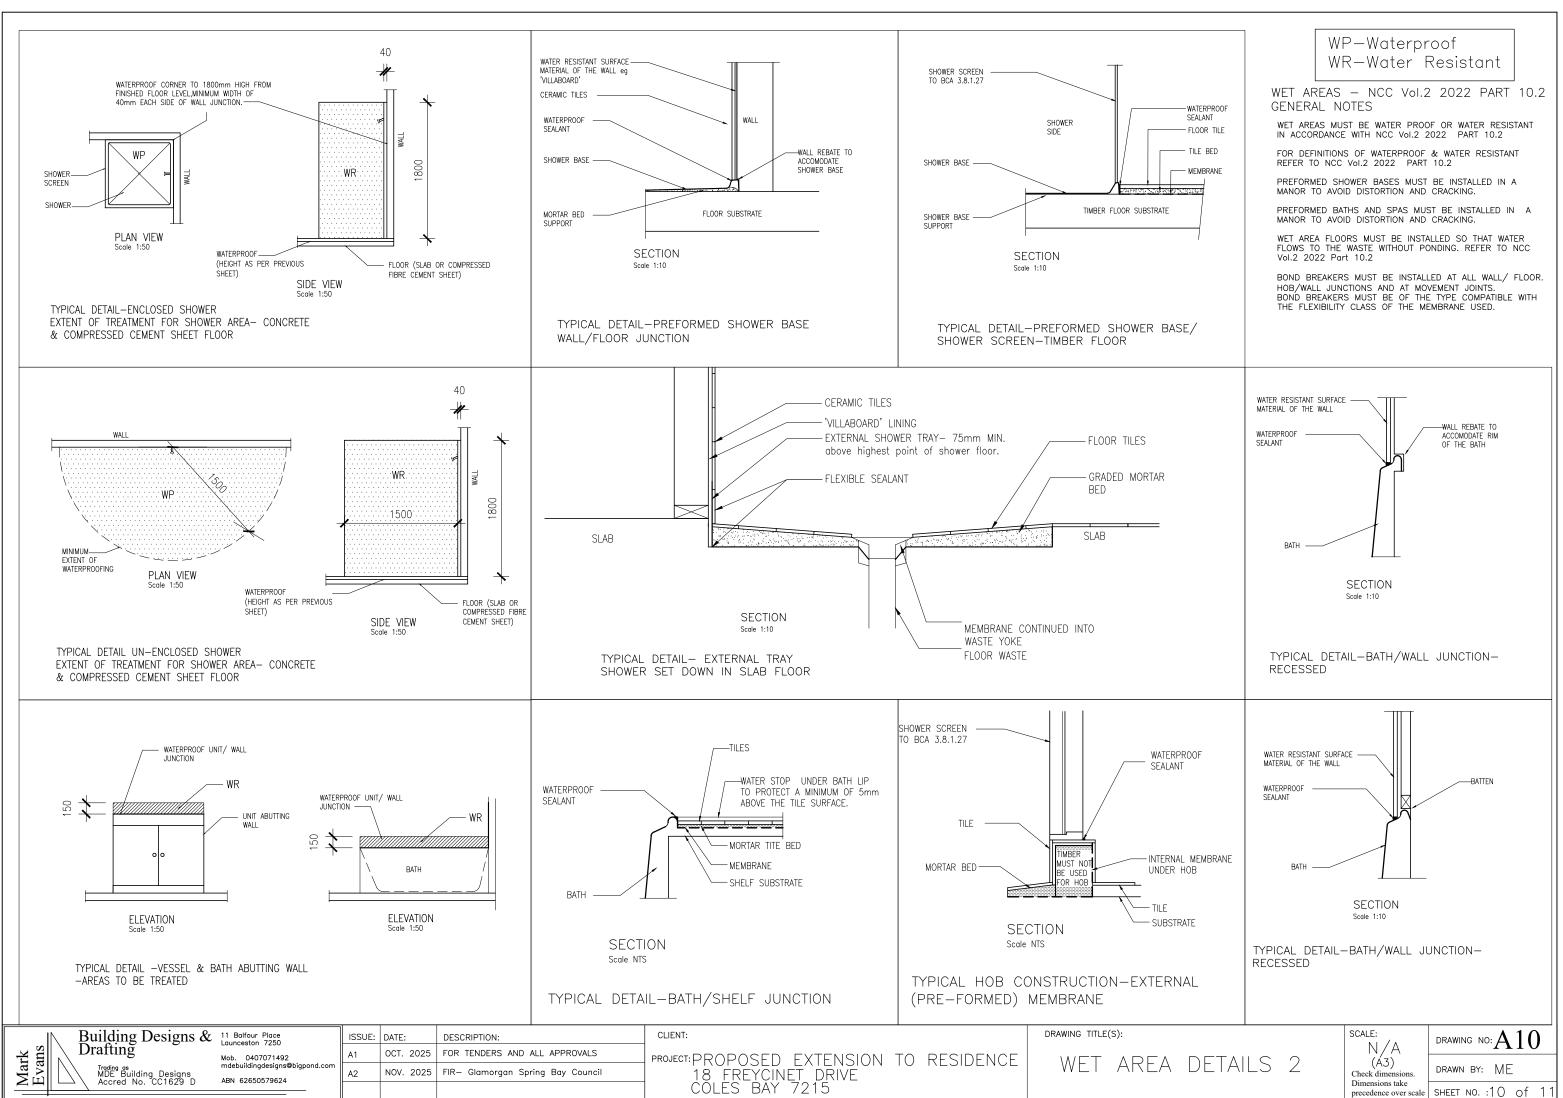

SHEET NO. :10 of 11

precedence over scale

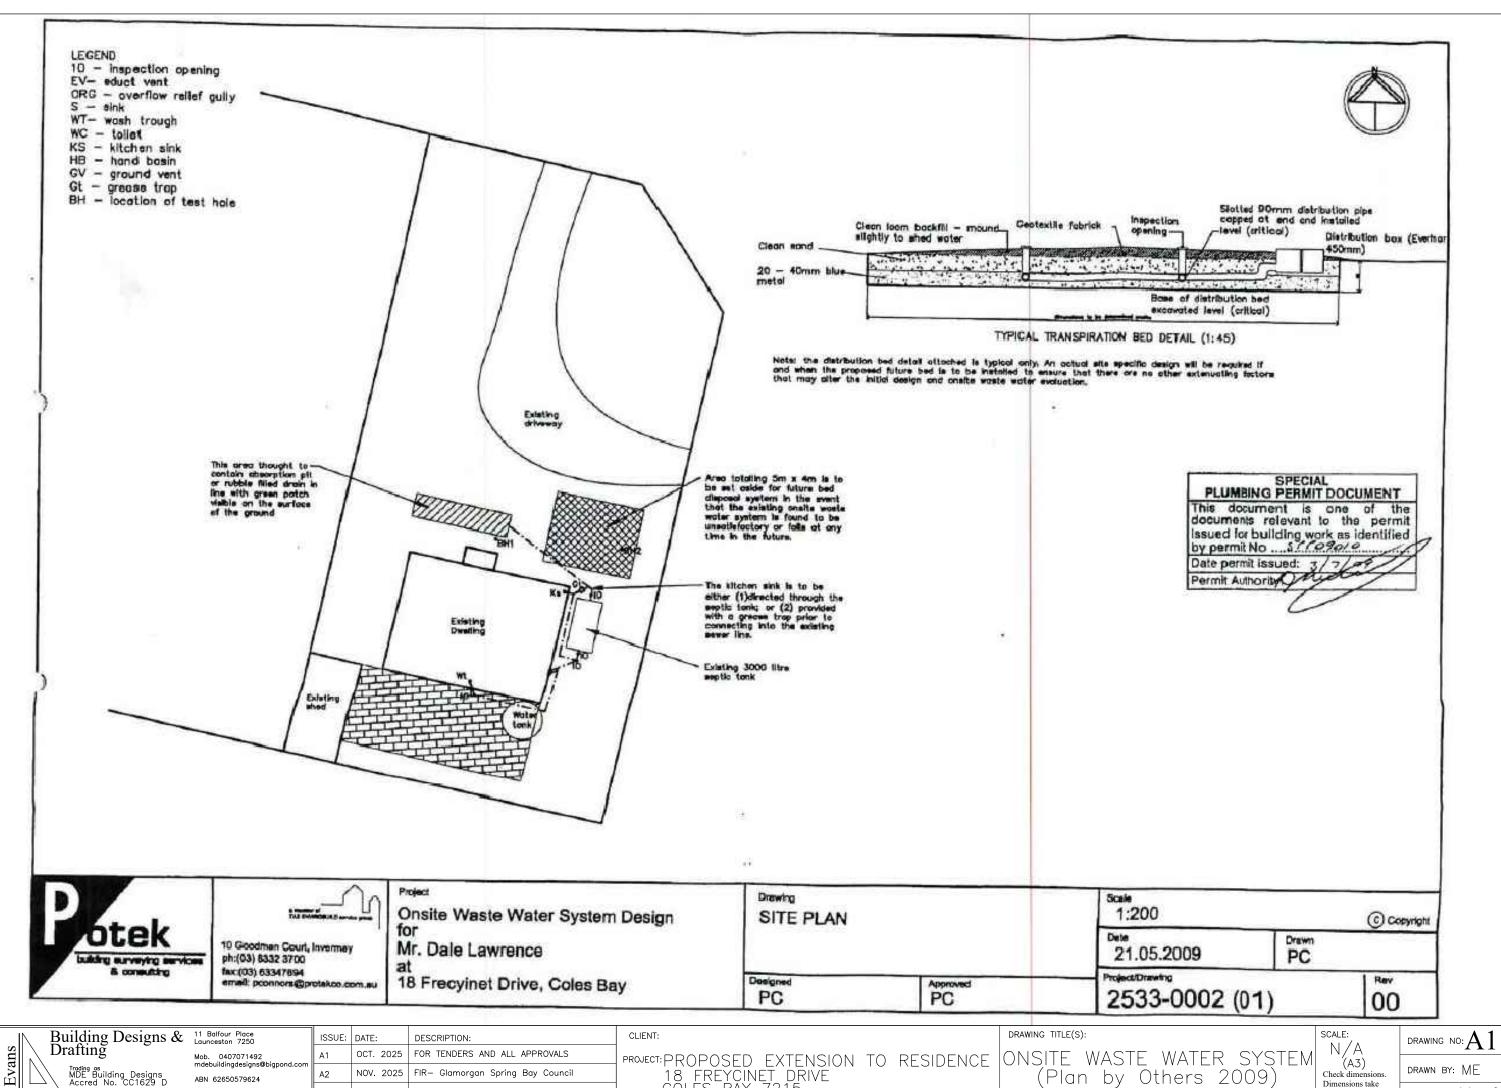

Mark Evans

ABN 62650579624

PROJECT: PROPOSED EXTENSION TO RESIDENCE 18 FREYCINET DRIVE COLES BAY 7215

(Plan by Others 2009)

Dimensions take

drawing no: A11