

# GLAMORGAN/SPRING BAY COUNCIL NOTICE OF PROPOSED DEVELOPMENT

Notice is hereby given that an application has been made for planning approval for the following development:

SITE: Unit 1/37 Jetty Road, Coles Bay

CT 183091/1

PROPOSAL: Partial demolition, additions and alterations

Any person may make representation on the application(s) by letter (PO Box 6, Triabunna) or electronic mail (planning@freycinet.tas.gov.au) addressed to the Chief Executive Officer. Representations must be received before midnight on 11 December 2025.

APPLICANT: Engineering Plus

DATE: **05/11/2025** 

APPLICATION NO: DA 2025 / 194



- **©** 03 6256 4777
- ₼ 03 6256 4774
- admin@freycinet.tas.gov.au
- www.gsbc.tas.gov.au

### **Application for Planning Approval**

### Advice:

Use this form for all no permit required, permitted and discretionary planning applications including visitor accommodation, subdivision as well as for planning scheme amendment & minor amendments to permits.

Completing this form in full will help ensure that all necessary information is provided and avoid any delay. The planning scheme in clause 6.0 provides details of other information that may be required. A checklist of application documents is provided on page 4 of this form.

Often, it is beneficial to provide a separate written submission explaining in general terms what is proposed and why and to justify the proposal against any applicable performance criteria.

If you have any queries with the form or what information is required, please contact the office.

Details of Applicant and Owner					
Applicant:					
Contact perso	on: (if diff	erent from applicant)			
Address:			1		
Suburb:				Post Code:	
Email:				Phone: / Mobile:	
Note: All corre	sponden	ce with the applicant will	be via ei	mail unless otherwi	se advised
Owner (if diff	erent fro	m applicant)			
Address:					
Suburb:			Post Code:		
Email:				Phone: / Mobile:	
Details of Site	e (Note: I	f your application is discr	etionary,	the following will l	be placed on public exhibition)
Address of pr	Address of proposal:				
Suburb:				Post Code:	
Size of site: (m² or Ha)					
Certificate of Title(s):					
Current use of site:					



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General Application Details Complete for All Applications			
Description of proposed use or development:			
Estimated value of works: (design & construction)  The estimated cost is to include the cost of labour and materials using current industry pricing and is to include GST.  You may be required to verify this estimate.  Is the property on the State Heritage Register? (Circle one)  \$ Yes / No			
For all Non-Residential Applications	terr (on one one)	·	
Hours of Operation			
Number of Employees			
Describe any delivery of goods to and from the site, including the types of vehicles used and the estimated average weekly frequency			
Describe any hazardous materials to be used or stored on site			
Type & location of any large plant or machinery used (refrigeration, generators)			
Describe any retail and/or storage of goods or equipment in outdoor areas			
Personal Information Protection Statement			

The personal information requested will be managed in accordance with the *Personal Information Protection Act 2004*. The personal information is being collected by Glamorgan Spring Bay Council for the purposes of managing, assessing, advising on, and determining the relevant application in accordance with the *Land Use Planning and Approvals Act 1993*(LUPPA) and other related purposes, including for the purpose of data collection.

The information may be shared with contractors and agents of the Council for this purpose, law enforcement agencies, courts and other organisations and it may also be made publicly available on the Council's website and available for any person to inspect in accordance with LUPAA. If you do not provide the information sought, Council will be unable to accept and/or process your application.



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### **Applicant Declaration**

I/we hereby apply for planning approval to carry out the use or development described in this application and the accompanying documents and declare that:

- The information in this application is true and correct.
- I/we authorise Council employees or consultants to enter the site to assess the application.
- I/we have obtained all copy licenses and permission from the copyright owner for the publication, communication and reproduction of the application and reports, plans and materials provided as part of the application and for the purposes of managing, assessing, advising on, and determining the application.

I/we authorise the Council to:

- Make available the application and all information, reports, plans, and materials provided with or
  as part of the application in electronic form on the Council's website and in hard copy at the
  Council's office and other locations for public exhibition if and as required;
- Make such copies of the application and all information, reports, plans and materials provided with or as part of the application which are, in the Council's opinion, necessary to facilitate a consideration of the application;
- Publish and or reproduce the application and all information, reports, plans and materials provided with or as part of the application in Council agendas, for representors, referral agencies and other persons interested in the application; and
- provide a copy of any documents relating to this application to any person for the purpose of assessment or public consultation and agree to arrange for the permission of the copyright owner of any part of this application to be obtained.

You indemnify the Council for any claim or action taken against the Council for breach of copyright in respect of the application and all information, report, plan, and material provided with or as part of the application.

I/We declare that the Owner has been notified of the intention to make this application in accordance with section 52(1) of the Land Use Planning and Approvals Act 1993.

Applicant Signature:	Alla.	Date:	
Owners Consent required if application is on or affects Council or Crown owned or administered land			
declare that I have given p	permission for the making of t	his application for use a	ind/or development.
Council General Manager or delegate Signature:		Date:	
f land affected by this ap	plication is owned or adminis	stered by the Crown or	Council, then the written

permission of the relevant Minister (or their delegate) and/or the General Manager must be provided. For Crown land, a copy of the instrument of delegation must be provided.

It is the applicant's responsibility to obtain any owners consent prior to lodgement. Written requests for Council consent are via the General Manager. Request for Ministerial consent is to be directed to the relevant department.



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### **Checklist of application documents:**

		Taken from Section 6 of the Planning Scheme
An	applicat	ion must include:
_	any wri signed details a copy plan; ar	d application form; itten permission and declaration of notification required under s.52 of the Act and, if any document is by the delegate, a copy of the delegation; of the location of the proposed use or development; of the current certificate of title for all land to which the permit sought is to relate, including the title and escription of the proposed use or development.
ena aut rele	able it to hority co evant sta	to the information that is required by clause 6.1.2, a planning authority may, in order to consider an application, require such further or additional information as the planning onsiders necessary to satisfy it that the proposed use or development will comply with any andards and purpose statements in the zone, codes or a specific area plan, applicable to development including:
	a site at (i) (ii) (iii) (iv) (v) (vi) (vii) (viii) (ix) (xi) (xii) (xiii) (xiv) (xv) where the scale of (xvi) (xviii) (xviii) (xviii) (xviii) (xix) (xxi) (xxi) (xxi)	redule of easements if listed in the folio of the title and appear on the plan, where applicable; nalysis and site plan at a scale acceptable to the planning authority showing, where applicable: the existing and proposed use(s) on the site; topography including contours showing AHD levels and major site features; natural drainage lines, watercourses and wetlands on or adjacent to the site; soil type; vegetation types and distribution including any known threatened species, and trees and vegetation to be removed; the location and capacity and connection point of any existing services and proposed services; the location of easements on the site or connected to the site; existing pedestrian and vehicle access to the site; the location of existing and proposed buildings on the site; the location of existing adjoining properties, adjacent buildings and their uses; any natural hazards that may affect use or development on the site; proposed roads, driveways, parking areas and footpaths within the site; any proposed open space, common space, or facilities on the site; and proposed subdivision lot boundaries; it is proposed to erect buildings, a detailed layout plan of the proposed buildings with dimensions at a f 1:100 or 1:200 as required by the planning authority showing, where applicable: the internal layout of each building on the site; the private open space for each dwelling; external storage spaces; parking space location and layout; major elevations of every building to be erected; the relationship of the elevations to existing ground level, showing any proposed cut or fill; shadow diagrams of the proposed buildings and adjacent structures demonstrating the extent of

shading of adjacent private open spaces and external windows of buildings on adjacent sites; and


(xxiii) materials and colours to be used on roofs and external walls.

### CERTIFICATE OF TITLE

LAND TITLES ACT 1980



**TASMANIA** 

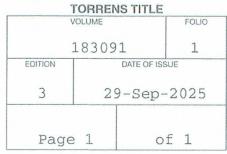

I certify that the person described in Schedule 1 is the registered proprietor of an estate in fee simple (or such other estate or interest as is set forth in that Schedule) in the land within described subject to such exceptions, encumbrances, interests and entries specified in Schedule 2 and to any additional entries in the Folio of the Register.

Recorder of Titles



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### DESCRIPTION OF LAND

Town of COLES BAY
Lot 1 on Strata Plan 183091 and a general unit entitlement operating for all purposes of the Strata Scheme being a 50 undivided 1/100 interest
Derived from Strata Plan 183091
Derivation: Part of Lot 1 (Sec. A) Gtd. to H.A.W. Parsons.

### SCHEDULE 1

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N281168 TRANSFER to DAVID BRUCE NADIN and BELINDA WIN NADIN Registered 29-Sep-2025 at noon

### SCHEDULE 2

Reservations and conditions in the Crown Grant if any
The registered proprietor holds the lot and unit entitlement
subject to any interest noted on common property
Folio of the Register volume 183091 folio 0



### **RESULT OF SEARCH**

RECORDER OF TITLES





#### SEARCH OF TORRENS TITLE

VOLUME	FOLIO		
183091	2		
EDITION 1	DATE OF ISSUE 28-Apr-2022		

SEARCH DATE : 14-Jul-2022 SEARCH TIME : 12.29 PM

### DESCRIPTION OF LAND

Town of COLES BAY

Lot 2 on Strata Plan 183091 and a general unit entitlement operating for all purposes of the Strata Scheme being a 50 undivided 1/100 interest

Derived from Strata Plan 183091

Derivation: Part of Lot 1 (Sec. A) Gtd. to H.A.W. Parsons.

### SCHEDULE 1

M923763 TRANSFER to GRANT JAMES PFEIFFER and TRINITY MAREE PFEIFFER Registered 17-Jan-2022 at 12.01 PM

### SCHEDULE 2

Reservations and conditions in the Crown Grant if any
The registered proprietor holds the lot and unit entitlement
subject to any interest noted on common property
Folio of the Register volume 183091 folio 0
E287244 MORTGAGE to National Australia Bank Limited
Registered 17-Jan-2022 at 12.02 PM

### UNREGISTERED DEALINGS AND NOTATIONS

No unregistered dealings or other notations




### **FOLIO PLAN**

**RECORDER OF TITLES** 



Issued Pursuant to the Land Titles Act 1980

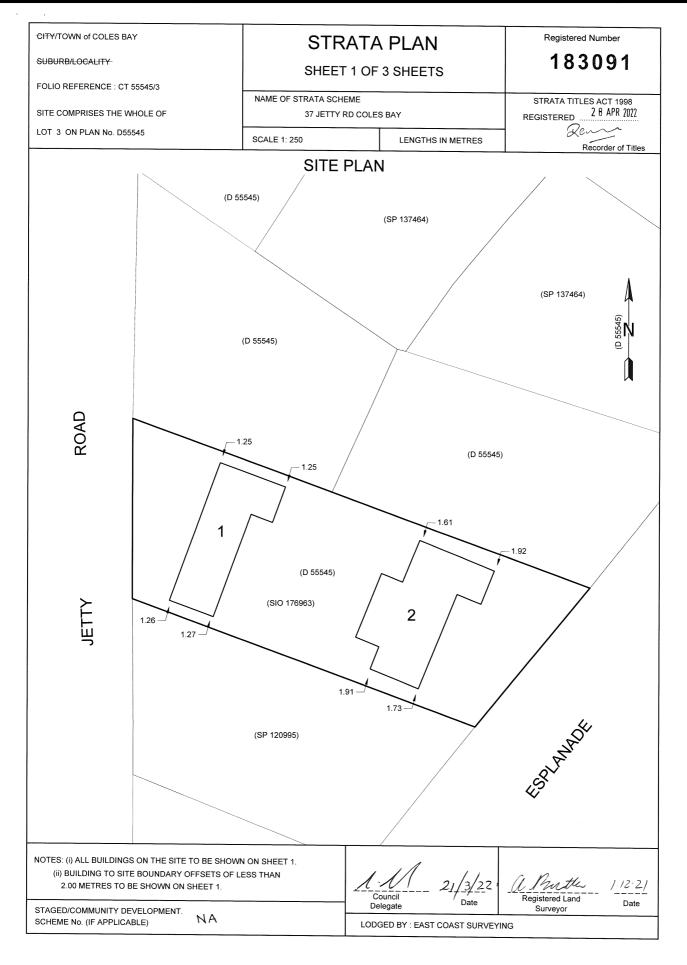

Search Date: 14 Jul 2022 Search Time: 12:30 PM Volume Number: 183091 Revision Number: 01 Page 1 of 3



### **FOLIO PLAN**

**RECORDER OF TITLES** 



Issued Pursuant to the Land Titles Act 1980

STRATA PLAN

SHEET 2 OF 3 SHEETS

STRATA TITLES ACT 1998


Council Delegate Date

Registered Number

183091

GROUND FLOOR



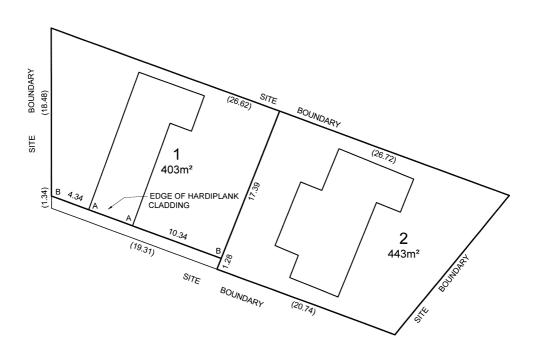

THE HORIZONTAL LOT BOUNDARIES ARE SHOWN BY HEAVY UNBROKEN LINES DEFINED BY:

SITE BOUNDARIES EDGE OF HARDIPLANK CLADDING MEASUREMENT WHERE THE BOUNDARY IS OPEN

MEASUREMENTS IN BRACKETS ARE FOR BOUNDARY FIXATION ONLY

THE VERTICAL LOT BOUNDARIES EXTEND FROM 2.0 METRES BELOW GROUND LEVEL TO 10.0 METRES ABOVE GROUND LEVEL.

AB IS THE PROLONGATION OF EDGE OF HARDIPLANK CLADDING AA

Registered Land Surveyor

4 · 2 · 22 Date

Search Date: 14 Jul 2022 Search Time: 12:30 PM Volume Number: 183091 Revision Number: 01 Page 2 of 3



### **FOLIO PLAN**

RECORDER OF TITLES



Issued Pursuant to the Land Titles Act 1980

STRATA PLAN

SHEET 3 OF 3 SHEETS

STRATA TITLES ACT 1998

Registered Number

183091

NAME OF BODY CORPORATE: STRATA CORPORATION NO. 183091 37 JETTY RD, COLES BAY

ADDRESS FOR THE SERVICE OF NOTICES: 37 JETTY RD, COLES BAY TAS 7215

SURVEYORS CERTIFICATE

I, ANDREW JOHN BUTLER of ST HELENS

a surveyor registered under the Surveyors Act 2002 certify that the building or buildings erected on the site and drawn on sheet 1 of this plan are within the site boundaries of the folio stated on sheet 1 and any encroachment beyond those boundaries is properly authorised

Registered Land Surveyor Date

COUNCIL CERTIFICATE

I certify that the Clamor goin Spring Boyu .... Council has:
(a) approved the lots shown in this plan and

(b) issued this certificate of approval in accordance with section 31 of the Strata Titles Act 1998

### GENERAL UNIT ENTITLEMENTS

LOT	UNIT ENTITLEMENT
1	50
2	50
TOTAL	100

Search Date: 14 Jul 2022 Search Time: 12:30 PM Volume Number: 183091 Page 3 of 3 Revision Number: 01



### **RESULT OF SEARCH**

**RECORDER OF TITLES** 

Issued Pursuant to the Land Titles Act 1980



#### SEARCH OF TORRENS TITLE

VOLUME 183091	FOLIO 0
103091	U
EDITION	DATE OF ISSUE
1	28-Apr-2022

SEARCH DATE : 14-Jul-2022 SEARCH TIME : 12.29 PM

### DESCRIPTION OF LAND

Town of COLES BAY

The Common Property for Strata Scheme 183091

Derivation: Part of Lot 1 (Sec. A) Gtd. to H.A.W. Parsons.

Prior CT 55545/3

### SCHEDULE 1

STRATA CORPORATION NUMBER 183091, 37 JETTY ROAD, COLES BAY

### SCHEDULE 2

Reservations and conditions in the Crown Grant if any

### UNREGISTERED DEALINGS AND NOTATIONS

No unregistered dealings or other notations



### **DRAWING SCHEDULE**

**COVER PAGE** A00

SITE PLAN A01

A02 **EXISTING & DEMOLITION PLAN** 

**CONSTRUCTION PLAN** A03

FLOOR PLAN A04

**ROOF PLAN** A05

**80A** 

A06 **ELEVATION #1** 

**ELEVATION #2** A07 PERSPECTIVE #1

A09 PERSPECTIVE #2

A10 SHADOW PLANS

A11 PLANNING RESPONSE

## PROPOSED EXTENSION & INTERNAL RENOVATION

DAVID BRUCE NADIN & BELINDA WIN NADIN UNIT 1 37 JETTY RD **COLES BAY TAS 7215** 

GLAMORGAN-SPRING BAY COUNCIL

### PROJECT INFORMATION

**BUILDING DESIGNER: GRANT JAMES PFEIFFER** 

ACCREDITATION No: CC2211T

10.0 LOW DENSITY GENERAL RESIDENTIAL ZONE ZONE:

**BUILDING CLASS:** CLASS 1B LAND TITLE REFERENCE NUMBER: 183091/1 **DESIGN WIND SPEED: ASSUMED 'N3'** 

SOIL CLASSIFICATION: ASSUMED 'H1'

CLIMATE ZONE: **BUSHFIRE-PRONE BAL RATING:** N/A ALPINE AREA: N/A

CORROSION ENVIRONMENT: LOW FLOODING: NO LANDSLIP: LOW

**DISPERSIVE SOILS:** UNKNOWN SALINE SOILS: UNKNOWN


SAND DUNES: NO MINE SUBSIDENCE: NO LANDFILL: NO

**REFER PLAN GROUND LEVELS:** 

ORG LEVEL: 75mm ABOVE GROUND LEVEL


Area Schedule (Gross Building)			
Name	Area	Area (sq)	
PROPOSED EXTENSION 2	9.96 m²	1.07	
PROPOSED EXTENSION 1	10.06 m²	1.08	
EXISTING VISITOR ACCOMMODATION	110.18 m²	11.86	
	130.20 m²	14.01	


## ISSUED FOR DEVELOPMENT APPROVAL

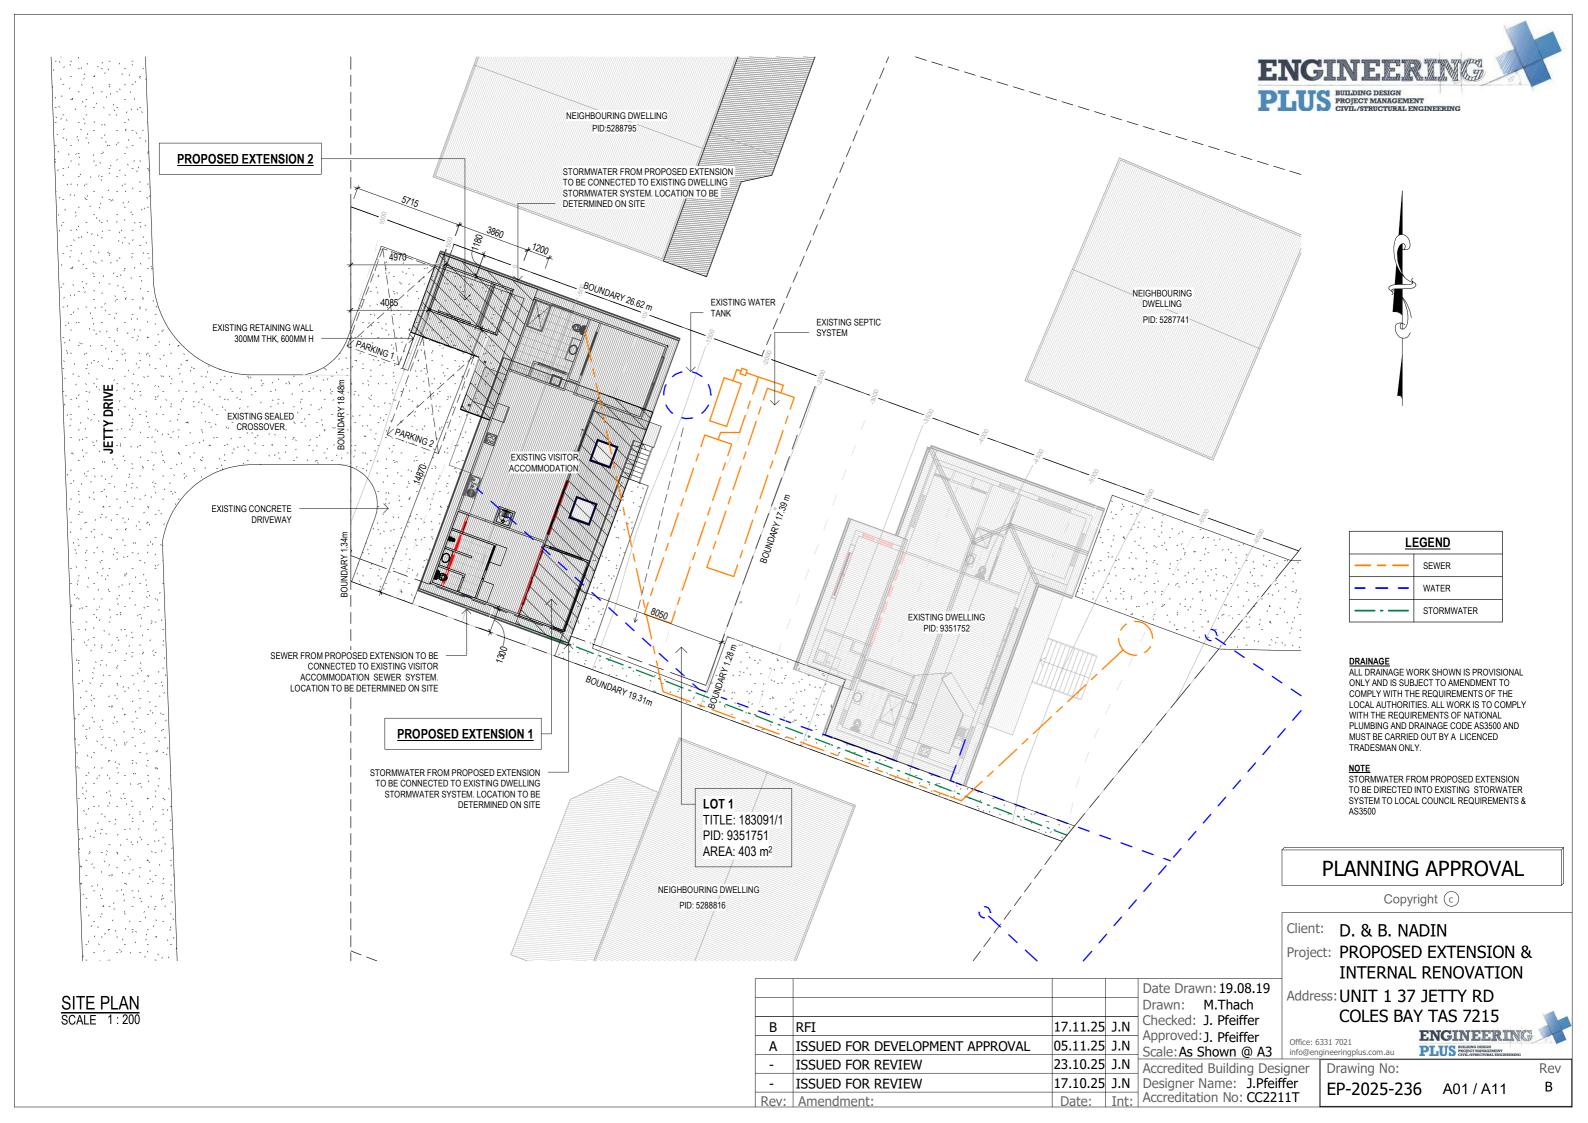





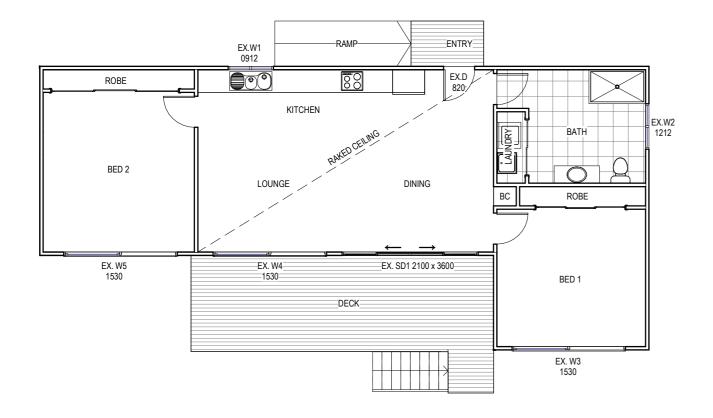

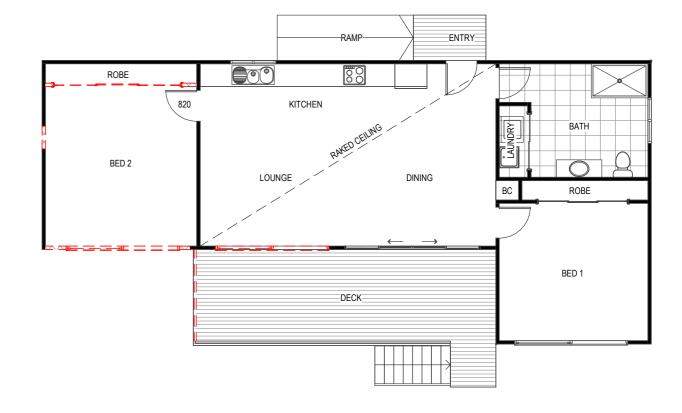

EXISTING PLAN SCALE 1:100

DEMOLITION PLAN SCALE 1:100

Date Drawn: 19.08.19

Drawn: M.Thach

### PLANNING APPROVAL

Copyright ©

Client: D. & B. NADIN

Project: PROPOSED EXTENSION & INTERNAL RENOVATION

Address: UNIT 1 37 JETTY RD **COLES BAY TAS 7215** 

ENGINEERING PLUS BUILDING DESIGN
PROJECT MANAGEMENT
CIVIL/STRUCTURAL ENGIS

Rev

В

Drawing No:


EP-2025-236 A02 / A11

NOTES: - WALLS TO BE REMOVED - EXISTING WALLS

Checked: J. Pfeiffer 17.11.25 J.N B RFI 17.11.25 J.N Approved: J. Pfeiffer Scale: As Shown @ A3 Office: 6331 7021 info@engineeringplus.com.au ISSUED FOR DEVELOPMENT APPROVAL 23.10.25 J.N Accredited Building Designer ISSUED FOR REVIEW 17.10.25 J.N Designer Name: J.Pfeiffer ISSUED FOR REVIEW Date: Int: Accreditation No: CC2211T Rev: Amendment:





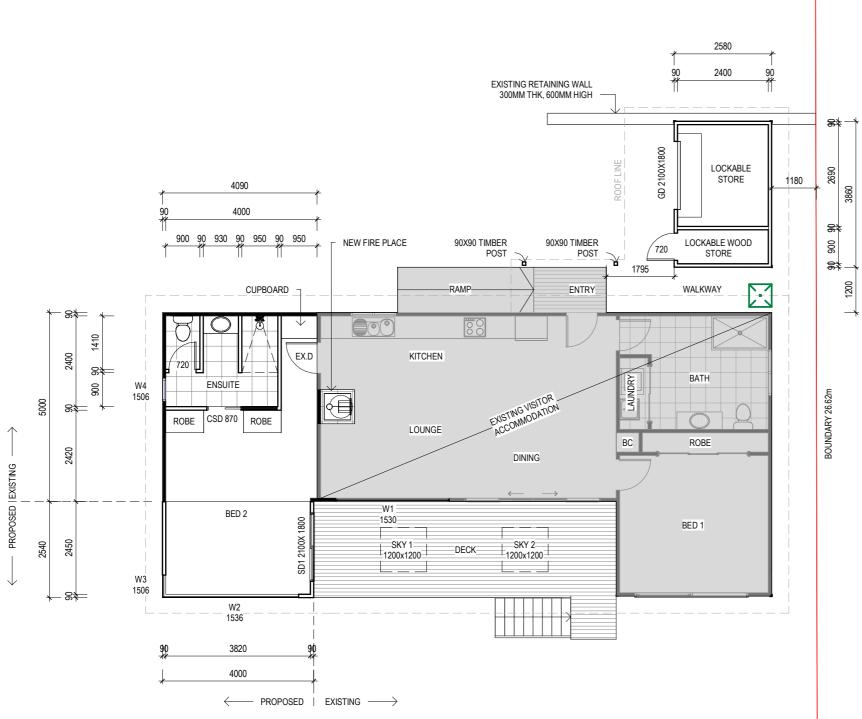

### WINDOW SCHEDULE

MARK	HEIGHT	WIDTH	TYPE	U-VALUE	SHGC	
W1 W2	1500 1500	3000 3600	DG DG	4.3 4.3	0.55 0.55	
W3	1500	600	DG	4.3	0.55	
W4	1500	600	DG	4.3	00.5	
SD1	2100	1800	DG	4.0	0.61	

ALL WINDOWS SHOWN ON PLAN ARE APPROX. BASED OFF STANDARD MANUFACTURING SIZES. ALL WINDOW DIMENSIONS TO BE CONFIRMED ON SITE BY BUILDER PRIOR TO ORDERING AND MANUFACTURING.

DEVELOPMENT AREA		
Name Area		
EXISTING VISITOR ACCOMMODATION	110.18 m²	
PROPOSED EXTENSION 1	10.06 m²	
PROPOSED EXTENSION 2	9.96 m²	
	130,20 m²	

### PLANNING APPROVAL

Copyright ©

Client: D. & B. NADIN

Project: PROPOSED EXTENSION & INTERNAL RENOVATION

Address: UNIT 1 37 JETTY RD

**COLES BAY TAS 7215** 

cale: As Shown @ A3 info@engineeringplus.com.au

ENGINEERING PLUS BUILDING DESIGN
PROJECT MANAGEMENT
CIVIL/STRUCTURAL ENGIN

Rev

В

Drawing No:

EP-2025-236 A03 / A11

## CONSTRUCTION PLAN SCALE 1:100

				Date Drawn: 19.08.19 Drawn: M.Thach	Addre
В	RFI	17.11.25		Checked: J. Pfeiffer Approved: J. Pfeiffer	
Α	ISSUED FOR DEVELOPMENT APPROVAL	05.11.25		Scale: As Shown @ A3	Office: 6
-	ISSUED FOR REVIEW	23.10.25	J.N	Accredited Building Desi	igner
-	ISSUED FOR REVIEW	17.10.25	J.N	Designer Name: J.Pfeif	fer
Rev:	Amendment:	Date:	Int:	Accreditation No: CC221	.1T







## FLOOR PLAN SCALE 1:100

DEVELOPMENT AREA		
Name Area		
EXISTING VISITOR	110.18 m²	
ACCOMMODATION		
PROPOSED EXTENSION 1	10.06 m²	
PROPOSED EXTENSION 2	9.96 m²	
	130.20 m²	

Date Drawn: 19.08.1	9 Add
Drawn: M.Thach	
B RFI 17.11.25 J.N Checked: J. Pfeiffer Approved: J. Pfeiffer	
A ISSUED FOR DEVELOPMENT APPROVAL 05.11.25 J.N Scale: As Shown @ A	
- ISSUED FOR REVIEW 23.10.25 J.N Accredited Building I	
- ISSUED FOR REVIEW 17.10.25 J.N Designer Name: J.P	feiffer
Rev: Amendment: Date: Int: Accreditation No: CC	2211T

Date Drawn: 19.08.19 Drawn: M.Thach Checked: J. Pfeiffer Approved: J. Pfeiffer Approved: J. Pfeiffer
Scale: As Shown @ A3

Office: 6331 7021
info@engineeringplus.com.au

Accredited Building Designer

FLOOR COVERINGS

TILE

WITH NCC PART 3.7.5.2.

CARPET

CONCRETE

TIMBER DECKING

VINYL TIMBER FLOORING

ENGINEERING

Client: D. & B. NADIN

Drawing No:

Address: UNIT 1 37 JETTY RD

PLUS BUILDING DESIGN
PROJECT MANAGEMENT
CIVIL/STRUCTURAL ENGIN

EP-2025-236 A04 / A11

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В

(\$) - DENOTES INTERCONNECTED SMOKE DETECTORS

SMOKE ALARMS
PROVIDE AND INSTALL SMOKE ALARMS & HARD WIRE
TO BUILDING POWER SUPPLY TO AS 3786.
CEILING MOUNTED WITH 9VDC
ALKALINE BATTERY BACKUP
TO LOCATIONS INDICATED ON PLAN AND IN ACCORDANCE

### PLANNING APPROVAL


Copyright ©

INTERNAL RENOVATION

**COLES BAY TAS 7215** 

Project: PROPOSED EXTENSION &



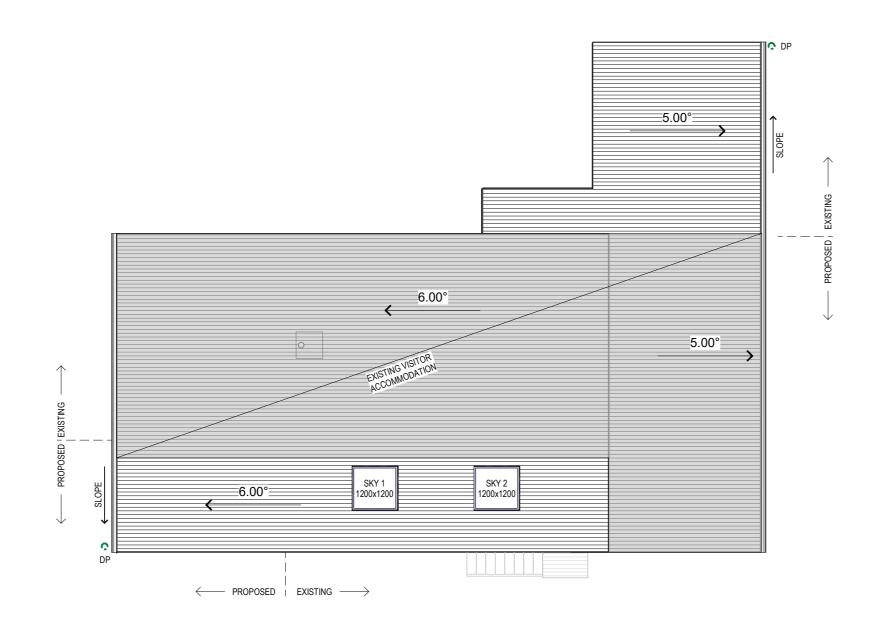

### ROOF CLADDING. NCC PART 7.2 SHEET ROOFING

COLORBOND 'CUSTOM ORB' METAL SHEETING INSTALLED IN ACCORDANCE WITH THIS PART, AS 1562.1 AND MANUFACTURERS RECOMMENDATIONS.

REFER TO LYSAGHT ROOFING & WALLING MANUAL FOR FULL DETAILS ON SHEET INSTALLATION, FIXINGS & FLASHINGS

### COLORBOND 'CUSTOM ORB'

- MINIMUM PITCH 5 DEGREES.
- CORROSION PROTECTION IN ACCORDANCE WITH NCC PART 7.2.2
- END LAP OF SHEETS

5-15 DEGREES - MINIMUM 200MM.

ABOVE 15 DEGREES - MINIMUM 150 MM.

- RIDGE LINE VALLEY TO BE TURNED UP (STOP ENDED).
- FASTENERS TO BE MADE OF COMPATIBLE MATERIAL WITH ROOFING MATERIAL.
- CREST FIXINGS OF END SPANS @ EVERY SECOND RIB AND INTERNAL SPANS @ EVERY THIRD RIB.
- WHERE POSSIBLE SHEETS TO BE LAID WITH SIDE LAPS FACING AWAY FROM PREVAILING WEATHER.
- REFLECTIVE FOIL INSULATION TO BE FITTED TO UNDERSIDE OF SHEETS.

R4.0 INSULATION BATTS TO ROOF SPACE ABOVE CEILING LINING.

RECOMMENDED FIXINGS FOR SEVERE EXPOSURE CONDITIONS TO AS 3566

USE CLASS 4 MATERIALS FOR SEVERE EXPOSURE & STAINLESS STEEL FOR VERY SEVERE COASTAL ENVIRONMENTS.

### DOWNPIPES - NCC PART 7.4

ROOF PLAN

SCALE 1:100

MAX. 12M GUTTER LENGTH PER DOWNPIPE LOCATED AS CLOSE AS POSSIBLE TO VALLEY GUTTERS SELECTED IN ACCORDANCE WITH TABLES 7.4.4a TO 7.4.4c

### OVERFLOW MEASURES

IN ACCORDANCE WITH 7.4.7 AND TABLE 7.4.4a & 7.4.4b AND FIG. 7.4.7a TO 7.4.7d END STOP WEIR

100mm MIN CLEAR WIDTH. INSTALLED 25mm BELOW FASCIA TOP NOT SUITABLE WHEN END-STOP ABUTS WALL INVERTED NOZZLE

INSTALLED WITHIN 500mm OF GUTTER HIGH POINT 100x50mm MIN. NOZZLE SIZE - MIN. 25mm BELOW FASCIA TOP FRONT FACE WEIR

200mm CLEAR WIDTH - 20mm CLEAR HEIGHT INSTALLED MIN. 25mm BELOW FASCIA TOP RAINHEAD

75mm DIA HOLE IN OUTWARD FACE - CENTERLINE 100mm BELOW FASCIA TOP

### **GUTTERS** - NCC PART 7.4

FALL NOT LESS THAN 1:500
SUPPORT BRACKETS FIXED AT STOP ENDS, CORNERS AND MAX. 1.2m CENTRES
VALLEY GUTTERS TO BE DIMENSIONED IN ACCORDANCE WITH TABLE 7.4.4c
HAVE A ROOF PITCH AND SIDE ANGLE OF NOT LESS THAN 12.5deg
HAVE A MIN. FREEBOARD OF NOT LESS THAN 15mm

### **OVERFLOW MEASURES**

IN ACCORDANCE WITH 7.4.6 AND TABLE 7.4.4a & 7.4.4b AND FIGURE 7.4.6a & 7.4.6b FRONT FACE SLOTTED GUTTER

MIN SLOT OPENING 1200mm/ GUTTER m LOWER EDGE OF SLOT INSTALLED 25mm BELOW FASCIA TOP CONTROLLED BACK GAP PERMANENT MIN. 10mm SPACER BETWEEN GUTTER & FASCIA ONE PER BRACKET - MIN. 50mm WIDE GUTTER INSTALLED MIN. 10mm BELOW FASCIA TOP

				Data Deputation 10 00 10	]
				Date Drawn: 19.08.19	Addre
				Drawn: M.Thach	Addic
В	RFI	17.11.25	J.N	Checked: J. Pfeiffer	
Α	ISSUED FOR DEVELOPMENT APPROVAL	05.11.25	J.N	Approved: J. Pfeiffer Scale: As Shown @ A3	Office: 6
-	ISSUED FOR REVIEW	23.10.25	J.N	Accredited Building Desi	igner
-	ISSUED FOR REVIEW	17.10.25	J.N	Designer Name: J.Pfeif	fer
Rev:	Amendment:	Date:	Int:	Accreditation No: CC221	l1T

### PLANNING APPROVAL

Copyright (c)

Client: D. & B. NADIN

Project: PROPOSED EXTENSION & INTERNAL RENOVATION

Address: UNIT 1 37 JETTY RD COLES BAY TAS 7215

Office: 6331 7021

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Scale: As Shown @ A3 | info@engineeringplus.com.au PLUS WINDOWS OF CONTRIBUTION OF CONTRIBUTIO

EP-2025-236 A05 / A11

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SOFFIT / EAVE LINED WITH 'HARDIFLEX' CEMENT SHEETING

- TRIMMERS LOCATED WITHIN 1200 MM OF EXTERNAL CORNERS TO BE SPACED @ 500 MM CENTERS, REMAINDER OF SHEET 700 MM CENTERS
- FASTENER / FIXINGS WITHIN 1200 MM OF EXTERNAL CORNERS @ 200 MM CENTERS, REMAINDER OF SHEET 300 MM CENTERS

### SELECTED ALUMINIUM FRAMED WINDOWS - ABCB VOLUME 2 PART 8.3


POWDER COATED ALUMINIUM WINDOW & DOOR FRAMES, UNLESS OTHERWISE NOTED.


TASMANIAN OAK REVEALS AND TRIMS. ALL FLASHING AND FIXINGS TO MANUFACTURERS SPECIFICATIONS.

### GLAZING & FRAME CONSTRUCTION TO AS 2047 & AS 1288

SOUTH EAST ELEVATION

ALL FIXINGS AND FLASHINGS TO MANUFACTURERS REQUIREMENTS

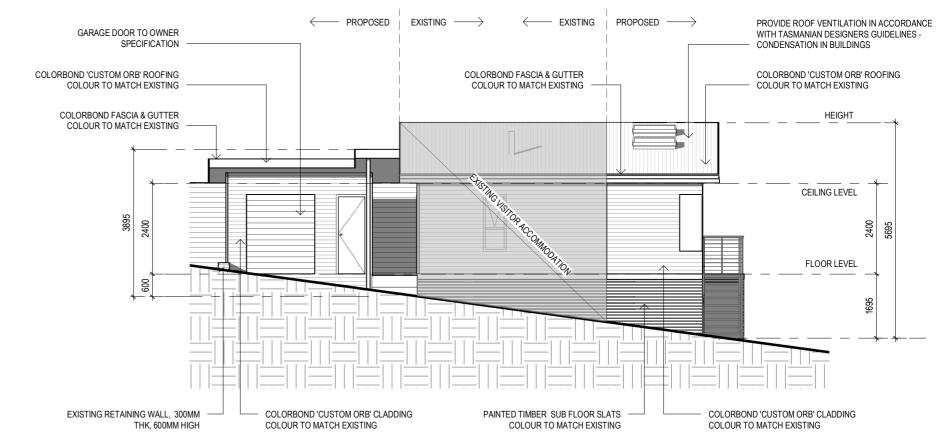

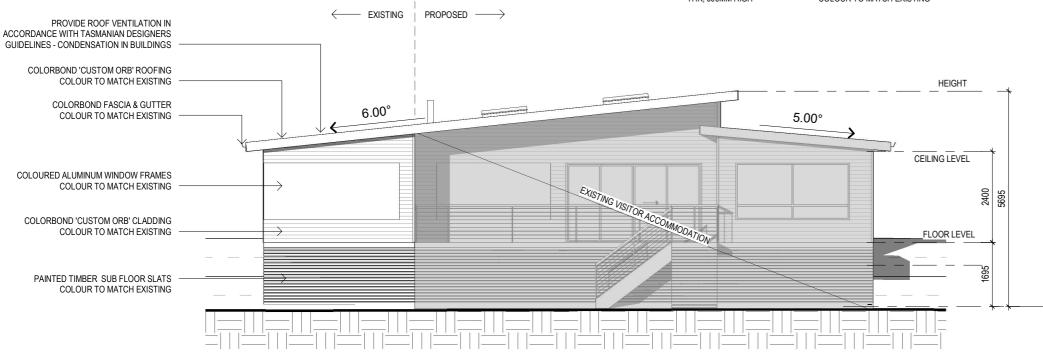

B RFI

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ISSUED FOR REVIEW

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SOUTH WEST ELEVATION

### PLANNING APPROVAL

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Client: D. & B. NADIN

Project: PROPOSED EXTENSION & INTERNAL RENOVATION

Address: UNIT 1 37 JETTY RD **COLES BAY TAS 7215** 

Date Drawn: 19.08.19

Drawn: M.Thach

Checked: J. Pfeiffer

Approved: J. Pfeiffer

17.10.25 J.N Designer Name: J.Pfeiffer

Date: Int: Accreditation No: CC2211T

17.11.25 J.N

05.11.25 J.N

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Scale: As Shown @ A3 info@engineeringplus.com.au 23.10.25 J.N Accredited Building Designer

PLUS BUILDING DESIGN
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Drawing No:

EP-2025-236 A06 / A11


### SUB FLOOR VENTILATION. NCC VOL 2 PART 6.2.1

- A MINIMUM OF 150 MM OF SUB FLOOR CLEARANCE IS TO BE PROVIDED BETWEEN FINISHED SURFACE LEVEL & THE UNDERSIDE OF THE FLOOR BEARER.
- A MINIMUM OF 6000 MM2 PER METRE OF SUB FLOOR VENTILATION IS TO BE UNIFORMLY DISTRIBUTED AROUND THE EXTERNAL AND INTERNAL WALLS OF THE BUILDING.
- VENTS TO BE LOCATED NO GREATER THAN 600 MM FROM AN INTERNAL OR EXTERNAL CORNER.

PRYDA 230x75 - 52 HOLE VENT MAXIMUM SPACING 1050 MM ALONG WALL OR PRYDA 230x165 - 117 HOLE VENT MAXIMUM SPACING 2350 MM ALONG WALL

ADDITIONAL VENTILATION PROVISIONS TO BE INSTALLED WHERE OBSTRUCTIONS SUCH AS CONCRETE VERANDAH'S, DECKS, PATIOS AND PAVING ARE INSTALLED & OBSTRUCT VENTILATION.




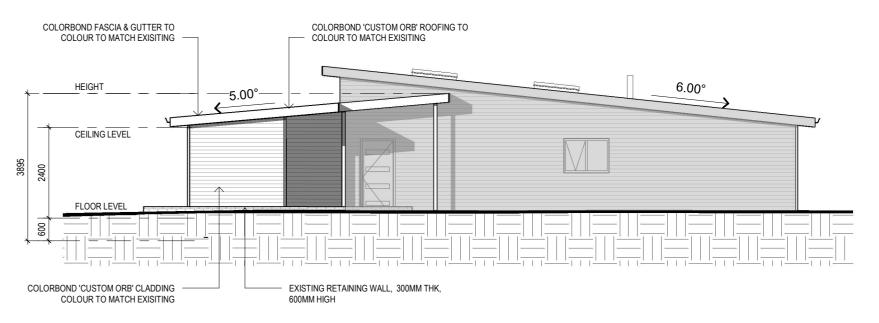

NORTH WEST ELEVATION SCALE 1:100

17.11.25 J.N

05.11.25 J.N

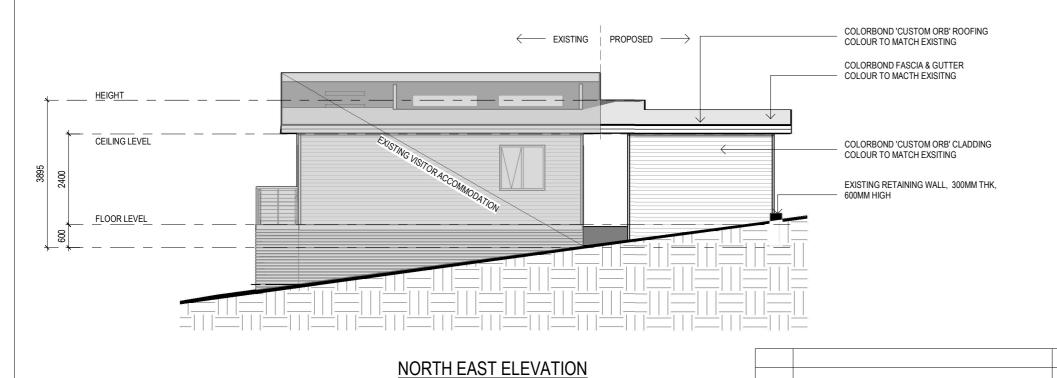

B RFI

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17.10.25 J.N | Designer Name: J.Pfeiffer

Date: Int: Accreditation No: CC2211T

Scale: As Shown @ A3

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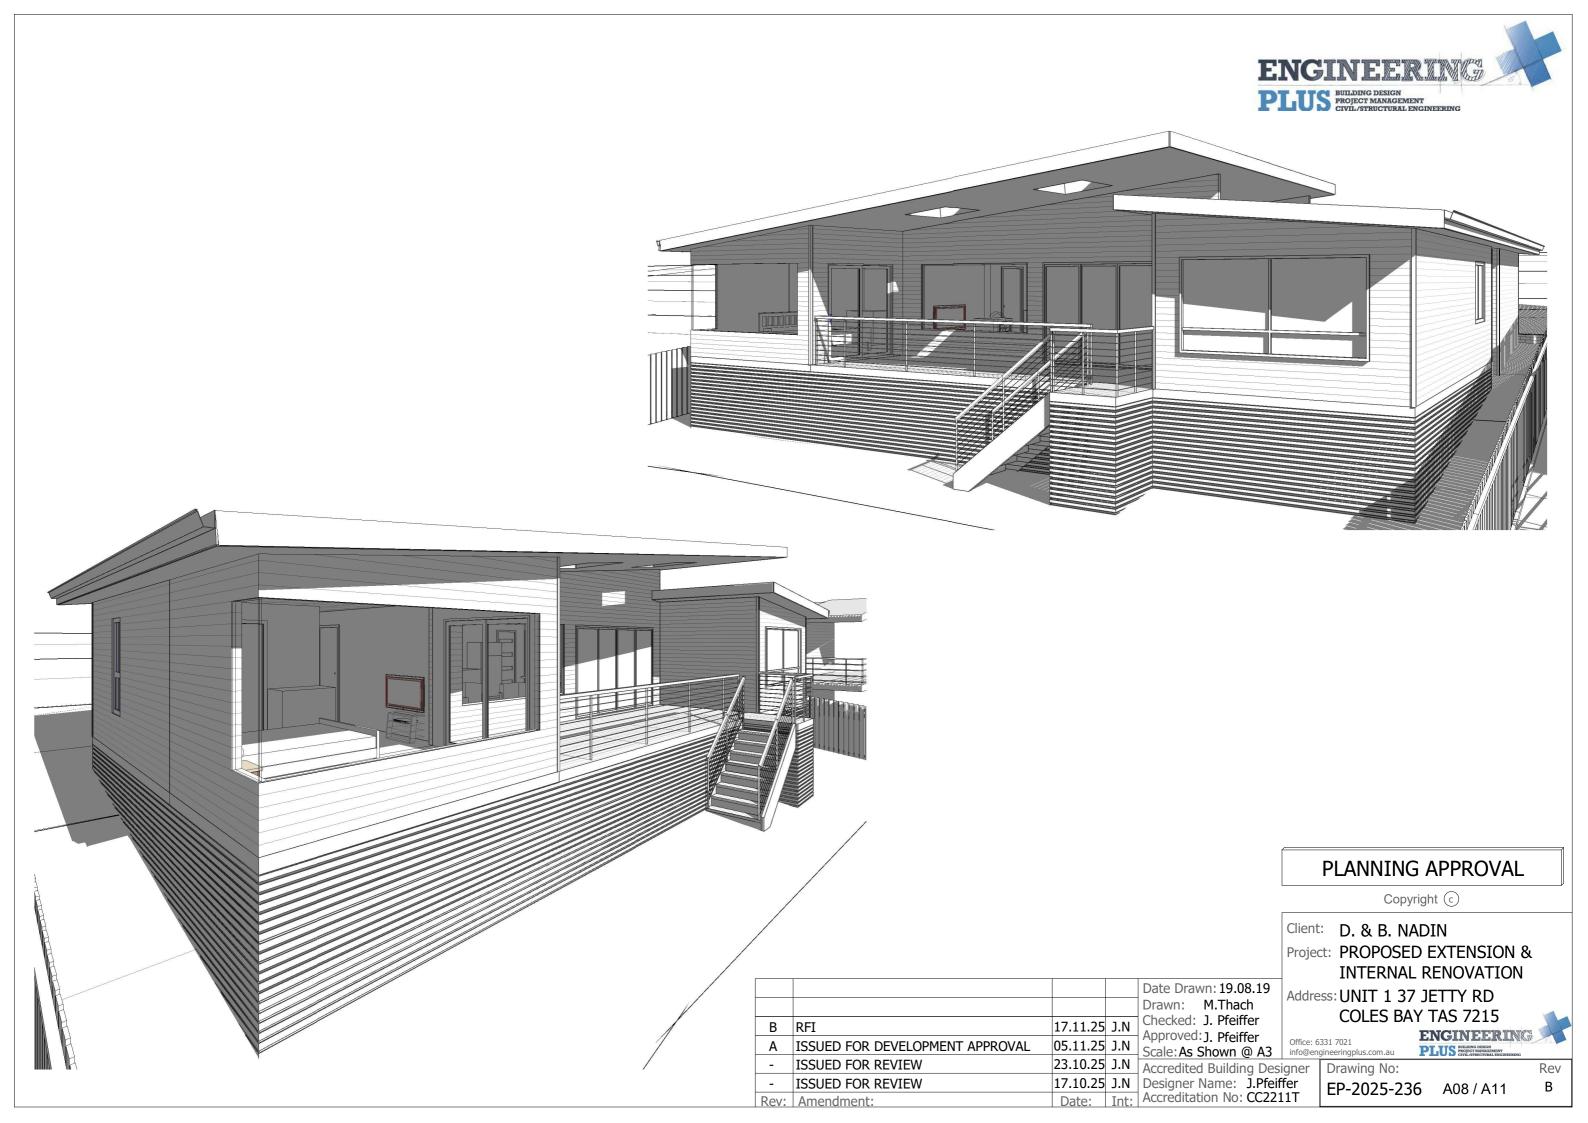
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23.10.25 J.N Accredited Building Designer


Drawing No:

EP-2025-236 A07 / A11






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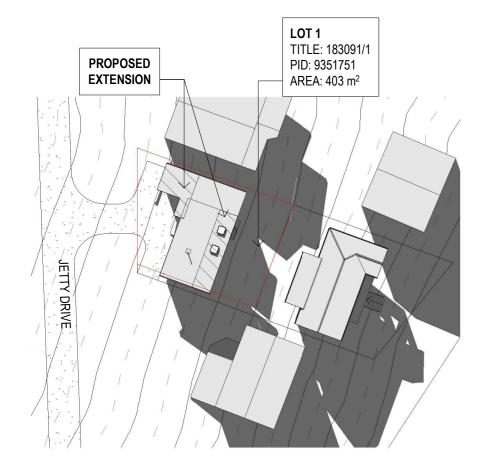


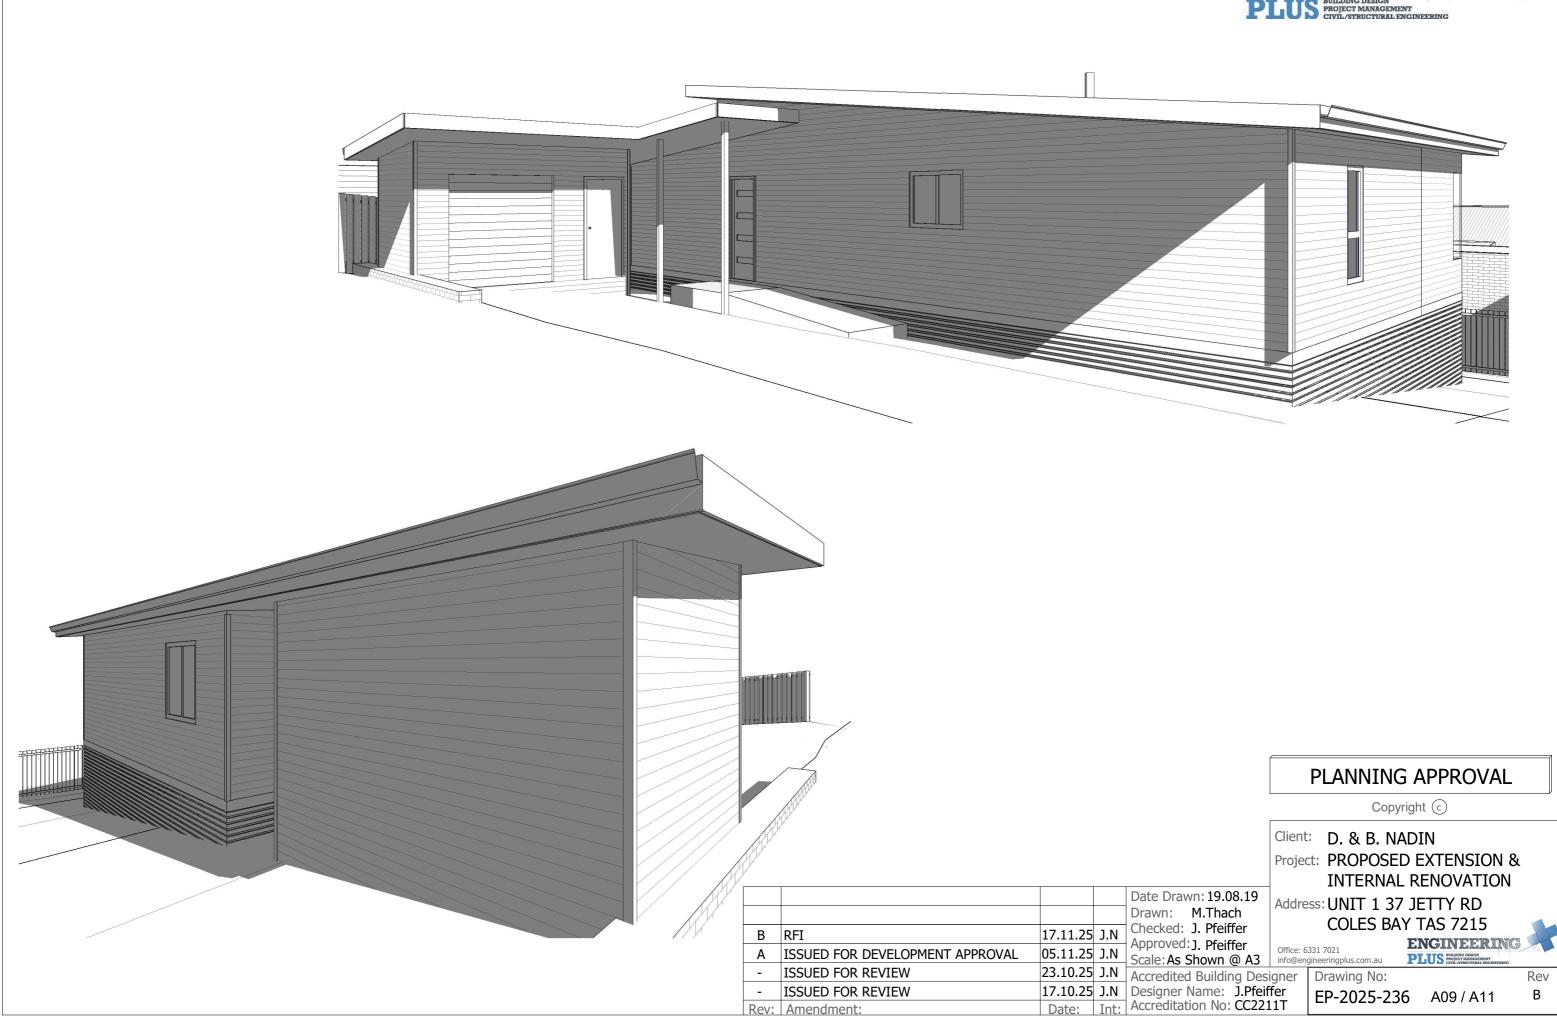Rev: Amendment:


### **WINTER SOLSTICE - 21.06.25**

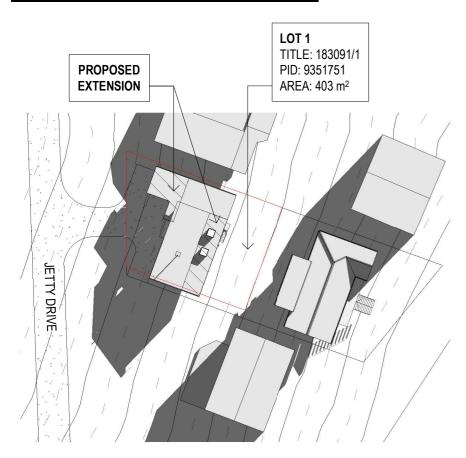


SHADOW PLAN 21.06.2025 9am SCALE 1:600



SHADOW PLAN 21.06.2025 1.30pm

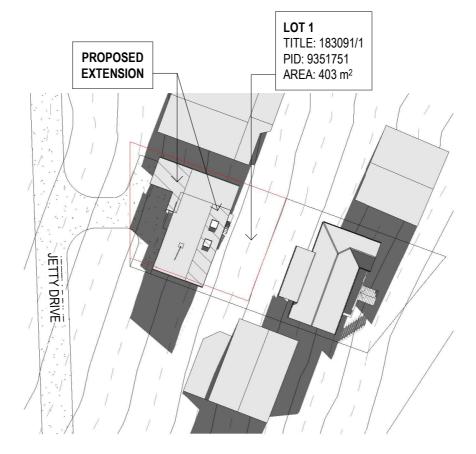

SHADOW PLAN 21.06.2025 10.30am SCALE 1:600

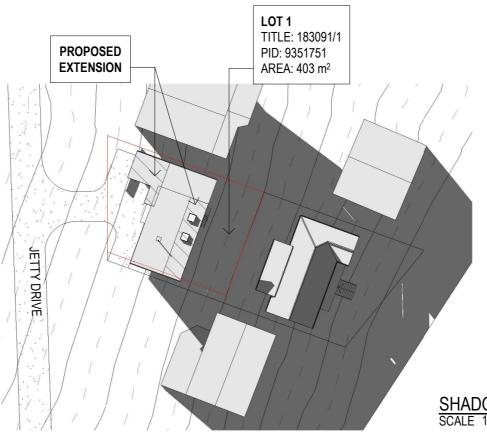

LOT 1 TITLE: 183091/1 **PROPOSED** PID: 9351751 **EXTENSION** AREA: 403 m<sup>2</sup> JETTY DRIVE

SHADOW PLAN 21.06.2025 12pm SCALE 1:600

SHADOW PLAN 21.06.2025 3.00pm SCALE 1:600

				Date Drawn: 19.08.19	Addre
				Drawn: M.Thach	Addic
В	RFI	17.11.25	J.N	Checked: J. Pfeiffer Approved: J. Pfeiffer	
Α		05.11.25		Scale: As Shown @ A3	Office: 6
-	ISSUED FOR REVIEW	23.10.25	J.N	Accredited Building Des	igner
-	ISSUED FOR REVIEW	17.10.25	J.N	Designer Name: J.Pfeif	fer
Rev:	Amendment:	Date:	Int:	Accreditation No: CC221	l1T

### PLANNING APPROVAL

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Client: D. & B. NADIN

Project: PROPOSED EXTENSION & INTERNAL RENOVATION

Address: UNIT 1 37 JETTY RD **COLES BAY TAS 7215** 

Approved: J. Pfeiffer Office: 6331 7021 info@engineeringplus.com.au

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Drawing No:

EP-2025-236 A10 / A11

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### PLANNING RESPONSE: CLAUSE 10.5.1 – LOW DENSITY RESIDENTIAL ZONE

#### P2 - Compatibility with Streetscape and Character

The siting of a building that is not a dwelling must be compatible with the streetscape and character of development existing on established properties in the area, having regard to:

RESPONSE: The proposal has been designed to follow the natural topography of the site. No earthworks are required, ensuring the building sits comfortably within the existing landform.

### (b) The setbacks of surrounding buildings;

RESPONSE: The proposed extension is setback approx. 4.1 metres from the frontage boundary. The adjoining property PID5288795 and PID5288787 and PID1554603 along the Jetty road is setback approx. 3.8 m, 3.0 m and 4.0 m. The proposed siting is consistent with the prevailing setback pattern in the area and does not dominate the streetscape.

#### (c) The height, bulk and form of existing and proposed buildings:

RESPONSE: The proposed extension is attached to the existing building and continues the same low roof form. In appearance, the extension reads as part of the existing building, consistent with

(d) The appearance when viewed from roads and public open space adjacent to the site; and RESPONSE: The building extension will be viewed as a continuation of the existing structure, using consistent materials, colours and roof form. The overall visual impact from the street and adjacent public areas will be minimal and compatible with surrounding low-scale development.

### (e) The safety of road users.

RESPONSE: The extension does not impact existing sightlines, vehicle access, or pedestrian safety. Existing driveway access remains unchanged, ensuring no adverse impact on road user

Conclusion: The proposal satisfies P2, being compatible with the established streetscape and character of the area.

### P3 - Amenity of Adjoining Properties

The siting of a building that is not a dwelling, must not cause unreasonable loss of amenity to adjoining properties, having regard to:

#### (a) The topography of the site; AND

(b) The size, shape and orientation of the site;

RESPONSE: The proposal respects the site's existing topography and orientation. The building is located to the side of the existing structure, maintaining generous separation from adjoining

#### (c) The setbacks of surrounding buildings;

RESPONSE: The proposed setbacks are consistent with adjoining development patterns, maintaining privacy and avoiding overshadowing.

### (d) The height, bulk and form of existing and proposed buildings;

RESPONSE: The low height and modest scale of the extension ensure no unreasonable impact on adjoining properties. The bulk is mitigated through continuation of the existing roofline.

### (e) The existing buildings and private open space areas on the site;

RESPONSE: he extension is positioned to avoid any loss of private open space or functional outdoor area. Existing private open space remains accessible and compliant with the zone

(f) Sunlight to private open space and windows of habitable rooms on adjoining properties; and RESPONSE: Given the single-storey form and orientation, the proposal will not cause overshadowing or loss of sunlight to habitable room windows or private open space of adjoining

(g) The character of development existing on established properties in the area. RESPONSE: The proposal complements the existing character of low-density residential development and maintains the open landscaped setting typical of the area.

Conclusion: The proposal complies with P3, as it will not cause unreasonable loss of amenity to adjoining properties.

#### P4 - Site Coverage

The site coverage of a building that is not a dwelling must be consistent with that existing on established properties in the area, having regard to:

#### (a) The topography of the site;

RESPONSE: The proposed extension follows the existing topography and integrates with the landform.

### (b) The capacity of the site to absorb runoff;

RESPONSE: Stormwater runoff will continue to be managed via the existing drainage system. The extension is to be constructed over the existing carparking area, which is already an impermeable surface, therefore no change to site drainage capacity occurs.

RESPONSE: The site size comfortably accommodates the proposed extension without resulting in overdevelopment, and the design has been planned to ensure the extension remains consistent with the appearance of the existing building

#### (d) The existing buildings and any constraints imposed by existing development;

RESPONSE: The extension connects seamlessly to the existing building and respects existing development constraints and access

### (e) The provision for landscaping and private open space;

RESPONSE: Landscaping and private open space areas remain unaffected, as the extension occupies part of the existing carparking area. Adequate open space is retained on site in accordance with zone requirements.

### (f) The need to remove vegetation; and

RESPONSE: No vegetation removal is required. The proposed works occur within previously developed and paved areas.

#### (q) The site coverage of adjacent properties.

RESPONSE: Comparison with surrounding lots (PID 5288795, 5288507, 5288787 shows site coverage in the range of approx. 40.58 %, 40.85 &, 32.36%. The subject site's proposed coverage of 41% is consistent with the character of development in the area.

Conclusion: The proposal satisfies P4, as the site coverage is consistent with surrounding development and does not impact runoff, landscaping, or amenity

				Date Drawn: 19.08.19	Addre
				Drawn: M.Thach	Addit
В	RFI	17.11.25	J.N	Checked: J. Pfeiffer	
Α	ISSUED FOR DEVELOPMENT APPROVAL	05.11.25	J.N	Approved: J. Pfeiffer Scale: As Shown @ A3	Office: (info@er
-	ISSUED FOR REVIEW	23.10.25	J.N	Accredited Building Des	
-	ISSUED FOR REVIEW	17.10.25	J.N	Designer Name: J.Pfeif	fer
Rev:	Amendment:	Date:	Int:	Accreditation No: CC221	L1T

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